PACKAGE-3: EFAP/KPID/CW-03: REHABILITATION OF CANALS AND DRAINS, DISTRICT DI KHAN – PAHARPUR IRRIGATION DIVISION



PROJECT MANAGEMENT OFFICE PEHUR HIGH LEVEL EXTENSIONPROJECT SWABI GOHATI IRRIGATION COMPLEX SWABI

Phone No. +92-938-530103, Fax No. +92-938-530104 Email: efapirrigation@gmail.com

INVITATION FOR BIDS TO ALL THE PREQUALIFIED BIDDERS FOR CATEGORY-III

Date:	19 October 2023	
Loan No. and Title:	Loan 4279-PAK(COL): Emergency Flood Assistance Pro Pakhtunkhwa Irrigation Department Component)	oject (Khyber
Contract No.	Packages / Contract Title	Qualification Category
EFAP/KPID- CW-03	Package-3: Rehabilitation of Canals and Drains, District DI Khan – Paharpur Irrigation Division	Category-III
Deadline for Submission of Bids	02 November 2023 (1100 Hours PST)	

- 1. The Islamic Republic of Pakistan has received financing from the Asian Development Bank (ADB) toward the cost of Repair, Rehabilitation and Reconstruction of Irrigation Structure, Drainage System and Flood Protection Works Spreads in Province of Khyber Pakhtunkhwa. Part of this financing will be used for payments under the Contract named above. Bidding is open to prequalified Bidders from eligible source countries of ADB.
- 2. The Irrigation Department, Government of Khyber Pakhtunkhwa ("the Employer") invites sealed bids from prequalified eligible Bidders for the construction and completion of works mentioned in the table above under "Packages / Contract Title" ("the Works").
- 3. Open competitive bidding will be conducted in accordance with ADB's Single-Stage: One Envelope following Prequalification procedure and is open to all prequalified Bidders from eligible countries as described in the Bidding Document.
- 4. Only eligible prequalified Bidders with the following key qualifications defined in the Bidding Document may participate in this bidding.

A pre-bid meeting shall take place on **25 October 2023** at **11:00 hours (Pakistan Standard Time)** at the address mentioned below.

5. To obtain further information and inspect the bidding documents, Bidders should contact:

Project Director

Project Management Office

Pehur High Level Canal Extension Project /Emergency Flood Assistance Project Irrigation Department Khyber Pakhtunkhwa, Gohati, Swabi.

- 6. To purchase the bidding documents in English, eligible bidders should
 - write to address above requesting the Bidding Documents for each package mentioned in the table above under "Packages / Contract Title".
 - pay a nonrefundable fee of PKR 15,000/- or USD equivalent by Pay Order or Demand Bank Draft in favor of Project Director. The eligible bidders also have the option to download the bidding documents at no cost from Irrigation website i.e., www.irrigation.gkp.pk. Eligible bidders opting to download the bidding document from Irrigation Department website shall inform PMO in writing at the address given



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below failing which PMO shall not be responsible if the applicants do not receive clarifications and amendments, if any. In case of any discrepancy between the downloaded document and hard copy, the latter shall prevail.

- 7. Deliver your bid
 - to the address given above vide Para-5
 - on or before the deadline **02 November 2023 (1100 Hours 'Pakistan Standard Time')**
 - together with a Bid-Securing Declaration as described in the Bidding Document.

Bids will be opened promptly after the deadline for bid submission in the presence of Bidders' representatives who choose to attend.

8. When comparing Bids, Domestic Preference will not be applied as stipulated in the Bidding Document.

Project Director

Project Management Office (PMO) Emergency Flood Assistance Project (EFAP) Irrigation Department, Khyber Pakhtunkhwa

Gohati Swabi

Phone No.: +92-938-530103 Fax: No. +92-938-530104

BIDDING DOCUMENT

PACKAGE-3: EFAP/KPID/CW-03: REHABILITATION OF CANALS AND DRAINS, DISTRICT DI KHAN – PAHARPUR IRRIGATION DIVISION

ISLAMIC REPUBLIC OF PAKISTAN KHYBER PAKHTUNKHWA IRRIGATION DEPARTMENT (KPID)



ASIAN DEVELOPMENT BANK

Loan 4279-PAK(COL):

Emergency Flood Assistance Project
(Khyber Pakhtunkhwa Irrigation Department Component)
(EFAP/KPID/CW-03)

BIDDING DOCUMENT Procurement of Works

- Single-Stage: One-Envelope Bidding Procedure - Following Prequalification -

Package-3: EFAP/KPID-CW-03
Rehabilitation of Canals and Drains, District
DI Khan – Paharpur Irrigation Division

Project Management Office (PMO),

Pehur High Level Canal Extension Project / Emergency Flood Assistance Project Gohati, Swabi

Tel: +92-(938)-530103 Fax: +92-(938)-530104

Email: pmophlce@gmail.com / efapirrigation@gmail.com

PROCUREMENT OF WORKS

BIDDING DOCUMENT

for

Procurement

of

Repair, Rehabilitation and Reconstruction of Irrigation Structure, Drainage System and Flood Protection Work Spreads in Province of Khyber Pakhtunkhwa

EFAP/KPID/CW-03: Rehabilitation of Canals and Drains, District DI Khan – Paharpur Irrigation Division

Issued on: 19 October 2023
Invitation for Bids No.: EFAP/KPID/CW-03
OCB No.: EFAP/KPID/CW-03
Employer: Project Director

Project Management Office

Pehur High Level Canal Extension Project / Emergency Flood

Assistance Project

Irrigation Department, Govt. of

Khyber Pakhtunkhwa

Country: Pakistan

Preface

This Bidding Document for the Procurement of Works has been prepared by Irrigation Department, Government of Khyber Pakhtunkhwa and is based on the Standard Bidding Document for the Procurement of Works-Small Contracts (SBD Works-Small) issued by the Asian Development Bank dated December 2021.

ADB's SBD Works-Small has the structure and the provisions of the Master Procurement Document entitled "Bidding Documents for the Procurement of Works-Small Contracts", prepared by multilateral development banks and other public international financial institutions except where ADB-specific considerations have required a change.

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	Section 9 - Contract Forms (COF) This section contains forms that, once completed, will form part of the Contract. The forms for Performance Security and Advance Payment Security, when required, shall only be completed by the successful Bidder after contract award.	9-1

Section 1: Instructions to Bidders

This Section specifies the procedures to be followed by Bidders in the preparation and submission of their Bids. Information is also provided on the submission, opening, evaluation of bids, and award of contract.

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A. General

1. Scope of Bid

- 1.1 In connection with the Invitation for Bids (IFB) indicated in the Bid Data Sheet (BDS), the Employer, as indicated in the BDS, issues this Bidding Document for the procurement of Works as specified in Section 6 (Employer's Requirements). The name, identification, and number of contracts of the open competitive bidding (OCB) are provided in the BDS.
- 1.2 Throughout this Bidding Document,
 - (a) the term "in writing" means communicated in written form and delivered against receipt;
 - (b) except where the context requires otherwise, words indicating the singular also include the plural and words indicating the plural also include the singular; and
 - (c) "day" means calendar day.

2. Source of Funds

- 2.1 The Borrower or Recipient (hereinafter called "Borrower") indicated in the BDS has applied for or received financing (hereinafter called "funds") from the Asian Development Bank (hereinafter called "ADB") toward the cost of the project named in the BDS. The Borrower intends to apply a portion of the funds to eligible payments under the contract(s) for which this Bidding Document is issued.
- 2.2 Payments by the ADB will be made only at the request of the Borrower and upon approval by ADB in accordance with the terms and conditions of the Financing Agreement between the Borrower and ADB (hereinafter called "Financing Agreement"), and will be subject in all respects to the terms and conditions of that Financing Agreement. No party other than the Borrower shall derive any rights from the Financing Agreement or have any claim to the funds.

3. Fraud and Corruption

- 3.1 ADB requires Borrowers (including beneficiaries of ADB-financed activity) and their personnel, as well as firms and individuals participating in an ADB-financed activity, including but not limited to, Bidders, Suppliers, and Contractors agents, subcontractors, subconsultants, service providers, subsuppliers, manufacturers (including their respective officers, directors, employees and personnel) under ADB-financed contracts to observe the highest standard of ethics during the procurement and execution of such contracts in accordance with ADB's Anticorruption Policy (1998, as amended from time to time. In pursuance of this policy, ADB
 - (a) defines, for the purposes of this provision, the terms set forth below as follows:
 - "corrupt practice" means the offering, giving, receiving, or soliciting, directly or indirectly, anything of value to influence improperly the actions of another party;
 - "fraudulent practice" means any act or omission, including a misrepresentation, that knowingly or recklessly misleads, or attempts to mislead, a party to obtain a financial or other benefit or to avoid an obligation;

- (iii) "coercive practice" means impairing or harming, or threatening to impair or harm, directly or indirectly, any party or the property of the party to influence improperly the actions of a party;
- (iv) "collusive practice" means an arrangement between two or more parties designed to achieve an improper purpose, including influencing improperly the actions of another party;
- (v) "abuse" means theft, waste, or improper use of assets related to ADB-related activity, either committed intentionally or through reckless disregard;
- (vi) "conflict of interest" means any situation in which a party has interests that could improperly influence that party's performance of official duties or responsibilities, contractual obligations, or compliance with applicable laws and regulations; and
- (vii) "integrity violation" is any act, as defined under ADB's Integrity Principles and Guidelines (2015, as amended from time to time), which violates ADB's Anticorruption Policy, including (i) to (vi) above and the following: obstructive practice, violations of ADB sanctions, retaliation against whistleblowers or witnesses, and other violations of ADB's Anticorruption Policy, including failure to adhere to the highest ethical standard.
- (b) will reject a proposal for award if it determines that the Bidder recommended for award or any of its officers, directors, employees, personnel, subconsultants, subcontractors, service providers, suppliers or manufacturers has, directly or through an agent, engaged in corrupt, fraudulent, collusive, coercive, or obstructive practices or other integrity violations in competing for the Contract;
- (c) will cancel the portion of the financing allocated to a contract if it determines at any time that representatives of the Borrower or of a beneficiary of ADB financing engaged in corrupt, fraudulent, collusive, coercive, or obstructive practices or other integrity violations during the procurement or the execution of that contract, without the Borrower having taken timely and appropriate action satisfactory to ADB to remedy the situation, including by failing to inform ADB in a timely manner at the time they knew of the integrity violations;
- (d) will impose remedial actions on a firm or an individual, at any time, in accordance with ADB's Anticorruption Policy and Integrity Principles and Guidelines, including declaring ineligible, either indefinitely or for a stated period of time, to participate¹ in ADB-financed, -administered, or -supported activities or to benefit from an ADB-financed, -administered, or -supported contract, financially or otherwise, if it at any time determines that the firm or individual has, directly or through an agent, engaged in corrupt, fraudulent, collusive, coercive or obstructive practices or other integrity violations; and
- (e) will have the right to require that a provision be included in bidding documents and in contracts financed, administered, or supported by

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¹ Whether as a Contractor, Subcontractor, Consultant, Manufacturer or Supplier, or Service Provider; or in any other capacity (different names are used depending on the particular Bidding Document).

ADB, requiring Bidders, suppliers and contractors, consultants, manufacturers, service providers and other third parties engaged or involved in ADB-related activities, and their respective officers, directors, employees and personnel, to permit ADB or its representative to inspect the site and their assets, accounts and records and other documents relating to the bid submission and contract performance and to have them audited by auditors appointed by ADB.

- 3.2 All Bidders, consultants, contractors, suppliers, manufacturers, service providers, and other third parties engaged or involved in ADB-related activities and their respective officers, directors, employees and personnel, are obliged to cooperate fully in any investigation when requested by ADB to do so. As determined on a case by case basis by ADB, such cooperation includes, but is not limited to, the following:
 - (a) being available to be interviewed and replying fully and truthfully to all questions asked;
 - (b) providing ADB with any items requested that are within the party's control including, but not limited to, documents and other physical objects;
 - (c) upon written request by ADB, authorizing other related entities to release directly to ADB such information that is specifically and materially related, directly or indirectly, to the said entities or issues which are the subject of the investigation;
 - (d) cooperating with all reasonable requests to search or physically inspect their person and/or work areas, including files, electronic databases, and personal property used on ADB activities, or that utilizes ADB's Information and Communications Technology (ICT) resources or systems (including mobile phones, personal electronic devices, and electronic storage devices such as external disk drives);
 - (e) cooperating in any testing requested by ADB, including but not limited to, fingerprint identification, handwriting analysis, and physical examination and analysis; and
 - (f) preserving and protecting confidentiality of all information discussed with, and as required by, ADB.
- 3.3 All Bidders, consultants, contractors and suppliers shall require their officers, directors, employees, personnel, agents to ensure that, in its contract with its sub-consultants, Subcontractors, and other third parties engaged or involved in ADB-related activities, such sub-consultants, Subcontractors, and other third parties similarly are obliged to cooperate fully in any investigation when requested by ADB to do so.
- 3.4 The Employer hereby puts the Bidder on notice that the Bidder or any Joint Venture partner of the Bidder (if any) may not be able to receive any payments under the Contract if the Bidder or any of its Joint Venture partners, as appropriate, is, or is owned (in whole or in part) by a person or entity subject to applicable sanctions.
- 3.5 Furthermore, Bidders shall be aware of the provision stated in Subclauses 1.15 and 15.6 of the Conditions of Contract.

4. Eligible Bidders

- 4.1 A Bidder may be a natural person, private entity, or government-owned enterprise subject to ITB 4.5 or any combination of them with a formal intent to enter into an agreement or under an existing agreement in the form of a Joint Venture. In the case of a Joint Venture,
 - (a) all partners shall be jointly and severally liable; and
 - (b) the Joint Venture shall nominate a Representative who shall have the authority to conduct all business for and on behalf of any and all the parties of the Joint Venture during the bidding process and, in the event the Joint Venture is awarded the Contract, during contract execution.
- 4.2 A Bidder, and all parties constituting the Bidder, shall have the nationality of an eligible country, in accordance with Section 5 (Eligible Countries). A Bidder shall be deemed to have the nationality of a country if the Bidder is a citizen or is constituted, incorporated, or registered, and operates in conformity with the provisions of the laws of that country. This criterion shall also apply to the determination of the nationality of proposed Subcontractors or Suppliers for any part of the Contract including related services.
- 4.3 A Bidder shall not have a conflict of interest. All Bidders found to have a conflict of interest shall be disqualified. A Bidder may be considered to be in a conflict of interest with one or more parties in the bidding process if any of, including but not limited to, the following apply:
 - (a) they have controlling shareholders in common; or
 - (b) they receive or have received any direct or indirect subsidy from any of them; or
 - (c) they have the same legal representative for purposes of this bid; or
 - (d) they have a relationship with each other, directly or through common third parties, that puts them in a position to have access to material information about or improperly influence the bid of another Bidder, or influence the decisions of the Employer regarding this bidding process; or
 - (e) a Bidder participates in more than one bid in this bidding process, either individually or as a partner in a Joint Venture, except for alternative offers permitted under ITB 13 of the Bidding Document. This will result in the disqualification of all Bids in which it is involved. However, subject to any finding of a conflict of interest in terms of ITB 4.3(a)-(d) above, this does not limit the participation of a Bidder as a Subcontractor in another Bid or of a firm as a Subcontractor in more than one Bid: or
 - (f) a Bidder, Joint Venture partner, associates, parent company, or any affiliated entity, participated as a Consultant in the preparation of the design or technical specifications of the works that are the subject of the Bid; or
 - (g) a Bidder was affiliated with a firm or entity that has been hired (or is proposed to be hired) by the Employer or Borrower as Engineer for the Contract; or
 - (h) a Bidder would be providing goods, works, or nonconsulting services resulting from or directly related to consulting services for the preparation or implementation of the project specified in the BDS

ITB 2.1 that it provided or were provided by any affiliate that directly or indirectly controls, is controlled by, or is under common control with that firm; or

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- (i) A Bidder that has a financial or familial relationship with staff of the Employer including project implementing/executing agency, or of a recipient of a part of the loan who: (i) are directly or indirectly involved in the preparation of the bidding documents or specifications of the contract, and/or the bid evaluation process of such contract; or (ii) would be involved in the implementation or supervision of such contract unless the conflict stemming from such relationship has been resolved in a manner acceptable to ADB throughout the procurement process and execution of the contract.
- 4.4 A firm will not be eligible to participate in any procurement activities under an ADB-financed, -administered, or -supported project while under temporary suspension or debarment by ADB pursuant to its Anticorruption Policy (see ITB 3), whether such debarment was directly imposed by ADB, or enforced by ADB pursuant to the Agreement for Mutual Enforcement of Debarment Decisions. A bid from a temporarily suspended or debarred firm will be rejected and such bid may be in breach of debarment conditions, thereby subject to further ADB's investigation.
- 4.5 Government-owned enterprises in the Employer's country shall be eligible only if they can establish that they (i) are legally and financially autonomous, (ii) operate under commercial law, and (iii) are not a dependent agency of the Employer.
- 4.6 A Bidder shall not be under suspension from bidding by the Employer as the result of the execution of a Bid–Securing Declaration.
- 4.7 Bidders shall provide such evidence of their continued eligibility satisfactory to the Employer, as the Employer shall reasonably request.
- 4.8 Bidders shall be excluded if, by an act of compliance with a decision of the United Nations Security Council taken under Chapter VII of the Charter of the United Nations, the Borrower's country prohibits any import of goods from, or payments to, a particular country, person or entity in respect of goods or services originating in that country. Where the Borrower's country prohibits payments to a particular person or entity or for particular goods or services by such an act of compliance, that firm shall be excluded.
- 4.9 Since a prequalification exercise was conducted prior to the issuance of this Bidding Document, only prequalified Bidders may submit bids for the contract(s) described in BDS.
- Eligible Materials, Equipment, and Services
- 5.1 The materials, equipment, and services to be supplied under the Contract shall have their origin in eligible source countries as defined in ITB 4.2, and all expenditures under the Contract will be limited to such materials, equipment, and services. At the Employer's request, Bidders may be required to provide evidence of the origin of materials, equipment, and services.

5.2 For purposes of ITB 5.1 above, "origin" means the place where the materials and equipment are mined, grown, produced, or manufactured, and from which the services are provided. Materials and equipment are produced when, through manufacturing, processing, or substantial or major assembling of components, a commercially recognized product results that differs substantially in its basic characteristics or in purpose or utility from its components.

B. Contents of Bidding Document

6. Sections of Bidding Document

6.1 The Bidding Document consists of Parts I, II, and III, which include all the sections indicated below, and should be read in conjunction with any addenda issued in accordance with ITB 8.

PART I Bidding Procedures

Section 1 - Instructions to Bidders (ITB)

Section 2 - Bid Data Sheet (BDS)

Section 3 - Evaluation and Qualification Criteria (EQC)

Section 4 - Bidding Forms (BDF)

Section 5 - Eligible Countries (ELC)

PART II Requirements

Section 6 - Employer's Requirements (ERQ)

PART III Conditions of Contract and Contract Forms

Section 7 - General Conditions of Contract (GCC)

Section 8 - Particular Conditions of Contract (PCC)

Section 9 - Contract Forms (COF)

- 6.2 The IFB issued by the Employer is not part of the Bidding Document.
- 6.3 The Employer is not responsible for the completeness of the Bidding Document and its addenda, if they were not obtained directly from the source stated by the Employer in the IFB.
- 6.4 The Bidder is expected to examine all instructions, forms, terms, and specifications in the Bidding Document. Failure to furnish all information or documentation required by the Bidding Document may result in the rejection of the bid.
- 7. Clarification of Bidding Document, Site Visit, Pre-Bid Meeting
- 7.1 A prospective Bidder requiring any clarification on the Bidding Document shall contact the Employer in writing at the Employer's address indicated in the BDS or raise his inquiries during the pre-bid meeting if provided for in accordance with ITB 7.4. The Employer will respond in writing to any request for clarification, provided that such request is received no later than 21 days prior to the deadline for submission of bids. The Employer shall forward copies of its response to all Bidders who have acquired the Bidding Document in accordance with ITB 6.3, including a description of the inquiry but without identifying its source. Should the Employer deem it necessary to amend the Bidding Document as a result of a request for clarification, it shall do so following the procedure under ITB 8 and ITB 22.2.
- 7.2 The Bidder is advised to visit and examine the Site of Works and its surroundings and obtain for itself on its own responsibility all information that may be necessary for preparing the Bid and entering into a contract

- for construction of the Works. The costs of visiting the Site shall be at the Bidder's own expense.
- 7.3 The Bidder and any of its personnel or agents will be granted permission by the Employer to enter its premises and lands for the purpose of such visit, but only upon the express condition that the Bidder, its personnel, and agents will release and indemnify the Employer and its personnel and agents from and against all liability in respect thereof, and will be responsible for death or personal injury; loss of or damage to property; and any other loss, damage, costs, and expenses incurred as a result of the inspection.
- 7.4 The Bidder's designated representative is invited to attend a pre-bid meeting, if provided for in the BDS. The purpose of the meeting will be to clarify issues and to answer questions on any matter that may be raised at that stage.
- 7.5 The Bidder is requested to submit any questions in writing, to reach the Employer not later than 1 week before the meeting.
- 7.6 Minutes of the pre-bid meeting, including the text of the questions raised, without identifying the source, and the responses given, together with any responses prepared after the meeting, will be transmitted promptly to all Bidders who have acquired the Bidding Document in accordance with ITB 6.3. Any modification to the Bidding Document that may become necessary as a result of the pre-bid meeting shall be made by the Employer exclusively through the issue of an addendum pursuant to ITB 8 and not through the minutes of the pre-bid meeting.
- 7.7 Nonattendance at the pre-bid meeting will not be a cause for disqualification of a Bidder.

8. Amendment of Bidding Document

- 8.1 At any time prior to the deadline for submission of Bids, the Employer may amend the Bidding Document by issuing addenda.
- 8.2 Any addendum issued shall be part of the Bidding Document and shall be communicated in writing to all who have obtained the Bidding Document from the Employer in accordance with ITB 6.3.
- 8.3 To give prospective Bidders reasonable time in which to take an addendum into account in preparing their Bids, the Employer may, at its discretion, extend the deadline for the submission of Bids, pursuant to ITB 22.2.

C. Preparation of Bids

- 9. Cost of Bidding
- 9.1 The Bidder shall bear all costs associated with the preparation and submission of its Bid, and the Employer shall in no case be responsible or liable for those costs, regardless of the conduct or outcome of the bidding process.
- 10. Language of Bid
- 10.1 The Bid, as well as all correspondence and documents relating to the bid exchanged by the Bidder and the Employer, shall be written in the language specified in the BDS. Supporting documents and printed literature that are part of the Bid may be in another language provided they are accompanied by an accurate translation of the relevant

passages in the language specified in the BDS, in which case, for purposes of interpretation of the Bid, such translation shall govern.

11. Documents Comprising the Bid

- 11.1 The Bid shall comprise the following:
 - (a) Letter of Bid;
 - (b) completed schedules as required, including priced Bill of Quantities, in accordance with ITB 12 and ITB 14;
 - (c) Bid Security or Bid-Securing Declaration, in accordance with ITB 19;
 - (d) alternative Bids, if permissible, in accordance with ITB 13;
 - (e) written confirmation authorizing the signatory of the Bid to commit the Bidder, in accordance with ITB 20.2;
 - (f) documentary evidence in accordance with ITB 17, establishing the Bidder's qualifications to perform the contract if its Bid is accepted;
 - (g) Technical Proposal in accordance with ITB 16; and
 - (h) any other document required in the BDS.
- 11.2 In addition to the requirements under ITB 11.1, Bids submitted by a Joint Venture shall include a copy of the Joint Venture Agreement entered into by all partners. Alternatively, a Letter of Intent to execute a Joint Venture Agreement in the event of a successful Bid shall be signed by all partners and submitted with the Bid, together with a copy of the proposed agreement.

12. Letter of Bid and Schedules

12.1 The Letter of Bid and Schedules, including the Bill of Quantities, shall be prepared using the relevant forms furnished in Section 4 (Bidding Forms). The forms must be completed without any alterations to the text, and no substitutes shall be accepted. All blank spaces shall be filled in with the information requested and as required in the BDS.

13. Alternative Bids

- 13.1 Unless otherwise indicated in the BDS, alternative Bids shall not be considered.
- 13.2 When alternative times for completion are explicitly invited, a statement to that effect will be included in the BDS, as will the method of evaluating different times for completion.
- 13.3 Except as provided under ITB 13.4 below, Bidders wishing to offer technical alternatives to the requirements of the Bidding Document must first price the Employer's design as described in the Bidding Document and shall further provide all information necessary for a complete evaluation of the alternative by the Employer, including drawings, design calculations, technical specifications, breakdown of prices, and proposed construction methodology and other relevant details. Only the technical alternatives, if any, of the lowest evaluated Bidder conforming to the basic technical requirements shall be considered by the Employer.
- 13.4 When specified in the BDS, Bidders are permitted to submit alternative technical solutions for specified parts of the Works. Such parts will be identified in the BDS and described in Section 6 (Employer's Requirements). The method for their evaluation will be stipulated in Section 3 (Evaluation and Qualification Criteria).

14. Bid Prices and Discounts

- 14.1 The prices and discounts quoted by the Bidder in the Letter of Bid and in the Bill of Quantities shall conform to the requirements specified below.
- 14.2 The Bidder shall fill in rates and prices for all items of the Works described in the Bill of Quantities. Items against which no rate or price is entered by the Bidder will not be paid for by the Employer when executed, and shall be deemed covered by the rates for other items and prices in the Bill of Quantities. Unit rates and prices for all items of the Works described in the Bill of Quantities shall be expressed in positive values. If unit rates and prices are expressed in negative values, the bid will be rejected.
- 14.3 The price to be quoted in the Letter of Bid, in accordance with ITB 12.1, shall be the total price of the Bid, excluding any discounts offered. Absence of the total bid price in the Letter of Bid may result in the rejection of the Bid.
- 14.4 The Bidder shall quote any discounts and the methodology for their application in the Letter of Bid, in accordance with ITB 12.1.
- 14.5 The prices shall be either fixed or adjustable as specified in the BDS.
 - (a) In the case of Fixed Price, prices quoted by the Bidder shall be fixed during the Bidder's performance of the contract and not subject to variation on any account. A Bid submitted with an adjustable price will be treated as nonresponsive and rejected.
 - (b) In the case of Adjustable Price, prices quoted by the Bidder shall be subject to adjustment during performance of the contract to reflect changes in the cost elements such as labor, material, transport, and contractor's equipment in accordance with the provisions of the Conditions of Contract. A Bid submitted with a fixed price will be treated as nonresponsive and be rejected. The Bidder shall furnish the indexes and weightings for the price adjustment formulas in the Tables of Adjustment Data included in Section 4 (Bidding Forms) and the Employer may require the Bidder to justify its proposed indexes and weightings. Any bid that omits indexes and weightings shall be subject to clarification with the Bidder.
- 14.6 If so indicated in ITB 1.1, bids are being invited for individual contracts or for any combination of contracts (packages). Bidders wishing to offer any price reduction for the award of more than one Contract shall specify in their bid the price reductions applicable to each package, or alternatively, to individual Contracts within the package. Price reductions or discounts shall be submitted in accordance with ITB 14.4, provided the Bids for all contracts are submitted and opened at the same time.
- 14.7 All duties, taxes, and other levies payable by the Contractor under the Contract, or for any other cause, as of the date 28 days prior to the deadline for submission of bids, shall be included in the rates and prices and the total Bid Price submitted by the Bidder.

15. Currencies of Bid and Payment

- 15.1 The unit rates and the prices shall be quoted by the Bidder entirely in the currency specified in the BDS.
- 15.2 Bidders shall indicate the portion of the bid price that corresponds to expenditures incurred in the currency of the Employer's country in the Schedule of Payment Currencies included in Section 4 (Bidding Forms).
- 15.3 Bidders expecting to incur expenditures in other currencies for inputs to the Works supplied from outside the Employer's country and wishing to be paid accordingly may indicate the other currencies in the Schedule of Payment Currencies included in Section 4 (Bidding Forms).
- 15.4 The rates of exchange to be used by the Bidder for currency conversion during bid preparation shall be the selling rates for similar transactions prevailing on the date 28 days prior to the deadline for submission of bids published by the source specified in the BDS. If exchange rates are not so published for certain currencies, the Bidder shall state the rates used and the source. Bidders should note that for the purpose of payments, the exchange rates confirmed by the source specified in the BDS as the selling rates prevailing 28 days prior to the deadline for submission of Bids shall apply for the duration of the Contract so that no currency exchange risk is borne by the Bidder.
- 15.5 Foreign currency requirements indicated by the Bidders in the Schedule of Payment Currencies shall include but not limited to the specific requirements for
 - (a) expatriate staff and labor employed directly on the Works;
 - (b) social, insurance, medical and other charges relating to such expatriate staff and labor, and foreign travel expenses;
 - (c) imported materials, both temporary and permanent, including fuels, oil and lubricants required for the Works;
 - (d) depreciation and usage of imported Plant and Contractor's Equipment, including spare parts, required for the Works;
 - (e) foreign insurance and freight charges for imported materials, Plant and Contractor's Equipment, including spare parts; and
 - (f) overhead expenses, fees, profit, and financial charges arising outside the Employer's country in connection with the Works.
- 15.6 Bidders may be required by the Employer to clarify their foreign currency requirements, and to substantiate that the amounts included in the unit rates and prices and shown in the Schedule of Payment Currencies are reasonable and responsive to ITB 15.3 above, in which case a detailed breakdown of its foreign currency requirements shall be provided by the Bidder.
- 15.7 Bidders should note that during the progress of the Works, the foreign currency requirements of the outstanding balance of the Contract Price may be adjusted by agreement between the Employer and the Contractor in order to reflect any changes in foreign currency requirements for the Contract, in accordance with Subclause 14.15 of the Conditions of Contract. Any such adjustment shall be effected by

comparing the percentages quoted in the bid with the amounts already used in the Works and the Contractor's future needs for imported items.

16. Documents Comprising the Technical Proposal

16.1 The Bidder shall furnish a Technical Proposal including a statement of work methods, equipment, personnel, schedule, environmental, health and safety (EHS) management plan commensurate with the proposed scope of works, EHS Code of Conduct, and any other information as stipulated in Section 4 (Bidding Forms), in sufficient detail to demonstrate the adequacy of the Bidders' proposal to meet the work requirements and the completion time.

17. Documents Establishing the Qualifications of the Bidder

- 17.1 To establish its qualifications to perform the Contract in accordance with Section 3 (Evaluation and Qualification Criteria) the Bidder shall provide the information requested in the corresponding information sheets included in Section 4 (Bidding Forms).
- 17.2 Domestic Bidders, individually or in Joint Ventures, applying for eligibility for domestic preference shall supply all information required to satisfy the criteria for eligibility as described in ITB 33.

18. Period of Validity of Bids

- 18.1 Bids shall remain valid for the bid validity period specified in the BDS. The bid validity period starts from the date fixed for the bid submission deadline date prescribed by the Employer in accordance with ITB 22.1. A bid valid for a shorter period shall be rejected by the Employer as nonresponsive.
- 18.2 In exceptional circumstances, prior to the expiration of the bid validity period, the Employer may request Bidders to extend the period of validity of their Bids. The request and the responses shall be made in writing. If a bid security is requested in accordance with ITB 19, it shall also be extended 28 days beyond the deadline of the extended validity period. A Bidder may refuse the request without forfeiting its bid security. A Bidder granting the request shall not be required or permitted to modify its Bid.

19. Bid Security/Bid-Securing Declaration

- 19.1 Unless otherwise specified in the BDS, the Bidder shall furnish as part of its Bid, in original form, either a Bid-Securing Declaration or a bid security as specified in the BDS. In the case of a bid security, the amount and currency shall be as specified in the BDS.
- 19.2 If a Bid-Securing Declaration is required pursuant to ITB 19.1, it shall use the form included in Section 4 (Bidding Forms). The Employer will declare a Bidder ineligible to be awarded a Contract for a specified period of time, as indicated in the BDS, if the Bid-Securing Declaration is executed.
- 19.3 If a bid security is specified pursuant to ITB 19.1, the bid security shall be, at the Bidder's option, in any of the following forms:
 - (a) an unconditional bank guarantee (hard copy of the bank guarantee or in the form of SWIFT message MT760), or
 - (b) an irrevocable letter of credit, or
 - (c) a cashier's or certified check.

all from a reputable source from an eligible country as described in Section 5 (Eligible Countries). In the case of a bank guarantee, the bid

- security shall be submitted either using the Bid Security Form included in Section 4 (Bidding Forms) or another form acceptable to the Employer. The form must include the complete name of the Bidder. The bid security shall be valid for 28 days beyond the original validity period of the bid, or beyond any period of extension if requested under ITB 18.2.
- 19.4 Unless otherwise specified in the BDS, any Bid not accompanied by a substantially compliant bid security or Bid-Securing Declaration, if one is required in accordance with ITB 19.1, shall be rejected by the Employer as nonresponsive.
- 19.5 If a bid security is specified pursuant to ITB 19.1, the bid security of unsuccessful Bidders shall be returned promptly upon the successful Bidder's furnishing of the performance security pursuant to ITB 44.
- 19.6 If a bid security is specified pursuant to ITB 19.1, the bid security of the successful Bidder shall be returned promptly once the successful Bidder has signed the Contract and furnished the required performance security.
- 19.7 The bid security may be forfeited or the Bid-Securing Declaration executed, if
 - (a) notwithstanding ITB 24.3, a Bidder withdraws its bid during the period of bid validity specified by the Bidder on the Letter of Bid, except as provided in ITB 18.2; or
 - (b) the successful Bidder fails to
 - (i) sign the Contract in accordance with ITB 43;
 - (ii) furnish a performance security in accordance with ITB 44;
 - (iii) accept the arithmetical correction of its Bid in accordance with ITB 31: or
 - (iv) furnish a domestic preference security if so required.
- 19.8 If the bid security is required as per ITB 19.1, the bid security of a Joint Venture shall be in the name of the Joint Venture that submits the Bid. If the Joint Venture has not been legally constituted at the time of bidding, the bid security shall be in the name of any or all of the Joint Venture partners. If the Bid-Securing Declaration is required as per ITB 19.1, the Bid-Securing Declaration of a Joint Venture shall be in the name of the Joint Venture that submits the Bid. If the Joint Venture has not been legally constituted at the time of bidding, the Bid-Securing Declaration shall be in the names of all future partners as named in the letter of intent mentioned in ITB 4.1.

20. Format and Signing of Bid

- 20.1 The Bidder shall prepare one original set of the documents comprising the Bid as described in ITB 11 and clearly mark it "ORIGINAL." Alternative Bids, if permitted in accordance with ITB 13, shall be clearly marked "ALTERNATIVE." In addition, the Bidder shall submit copies of the Bid, in the number specified in the BDS and clearly mark them "COPY." In the event of any discrepancy between the original and the copies, the original shall prevail.
- 20.2 The original and all copies of the Bid shall be typed or written in indelible ink and shall be signed by a person duly authorized to sign on behalf of the Bidder. This authorization shall consist of a written confirmation as

specified in the BDS and shall be attached to the bid. The name and position held by each person signing the authorization must be typed or printed below the signature. If a Bidder submits a deficient authorization, the Bid shall not be rejected in the first instance. The Employer shall request the Bidder to submit an acceptable authorization within the number of days as specified in the BDS. Failure to provide an acceptable authorization within the period as stated in the Employer's request shall cause the rejection of the Bid. If either the Letter of Bid or Bid-Securing Declaration (if applicable) is not signed, the Bid shall be rejected.

20.3 Any amendments such as interlineations, erasures, or overwriting shall be valid only if they are signed or initialed by the person signing the Bid.

D. Submission and Opening of Bids

21. Sealing and Marking of Bids

- 21.1 Bidders shall submit their Bids as specified in the BDS. Procedures for submission, sealing, and marking are as follows:
 - (a) Bidders submitting Bids by mail or by hand shall enclose the original and all copies of the Bid, including alternative Bids, if permitted in accordance with ITB 13, in separate sealed envelopes, duly marking the envelopes as "ORIGINAL," "ALTERNATIVE," and "COPY." These envelopes containing the original and the copies shall then be enclosed in one single envelope. The rest of the procedure shall be in accordance with ITB 21.2 and ITB 21.3.
 - (b) Bidders submitting Bids electronically shall follow the electronic bid submission procedures specified in the BDS.
- 21.2 The inner and outer envelopes shall
 - (a) bear the name and address of the Bidder;
 - (b) be addressed to the Employer in accordance with BDS 22.1;
 - (c) bear the specific identification of this bidding process indicated in the BDS 1.1; and
 - (d) bear a warning not to open before the time and date for bid opening.
- 21.3 If all envelopes are not sealed and marked as required, the Employer will assume no responsibility for the misplacement or premature opening of the Bid.

22. Deadline for Submission of Bids

- 22.1 Bids must be received by the Employer at the address and no later than the date and time indicated in the BDS.
- 22.2 The Employer may, at its discretion, extend the deadline for the submission of Bids by amending the Bidding Document in accordance with ITB 8, in which case all rights and obligations of the Employer and Bidders previously subject to the deadline shall thereafter be subject to the deadline as extended.
- 23. Late Bids
- 23.1 The Employer shall not consider any Bid that arrives after the deadline for submission of bids, in accordance with ITB 22. Any bid received by

24. Withdrawal, Substitution, and Modification of Bids the Employer after the deadline for submission of Bids shall be declared late, rejected, and returned unopened to the Bidder.

- 24.1 A Bidder may withdraw, substitute, or modify its Bid after it has been submitted by sending a written notice, duly signed by an authorized representative, and shall include a copy of the authorization in accordance with ITB 20.2 (except for withdrawal notices, which do not require copies). The corresponding substitution or modification of the Bid must accompany the respective written notice. All notices must be
 - (a) prepared and submitted in accordance with ITB 20 and ITB 21 (except for withdrawal notices, which do not require copies), and in addition, the respective envelopes shall be clearly marked "WITHDRAWAL," "SUBSTITUTION," "MODIFICATION"; and
 - (b) received by the Employer no later than the deadline prescribed for submission of Bids, in accordance with ITB 22.
- 24.2 Bids requested to be withdrawn in accordance with ITB 24.1 shall be returned unopened to the Bidders.
- 24.3 No Bid may be withdrawn, substituted, or modified in the interval between the deadline for submission of Bids and the expiration of the period of bid validity specified by the Bidder on the Letter of Bid or any extension thereof.

25. Bid Opening

- 25.1 The Employer shall open the Bids in public at the address, on the date and time specified in the BDS in the presence of Bidders' designated representatives and anyone who chooses to attend. Any specific electronic bid opening procedures required if electronic bidding is permitted in accordance with ITB 21.1, shall be as specified in the BDS.
- 25.2 First, envelopes marked "WITHDRAWAL" shall be opened and read out and the envelope with the corresponding Bid shall not be opened, but returned to the Bidder. No bid withdrawal shall be permitted unless the corresponding withdrawal notice contains a valid authorization to request the withdrawal and is read out at bid opening. Next, envelopes marked "SUBSTITUTION" shall be opened and read out and exchanged with the corresponding Bid being substituted. The substituted Bid shall not be opened, but returned to the Bidder. No bid substitution shall be permitted unless the corresponding substitution notice contains a valid authorization to request the substitution and is read out at bid opening. Envelopes marked "MODIFICATION" shall be opened and read out with the corresponding Bid. No bid modification shall be permitted unless the corresponding modification notice contains a valid authorization to request the modification and is read out at bid opening. Only envelopes that are opened and read out at bid opening shall be considered further.
- 25.3 All other envelopes shall be opened one at a time, reading out the name of the Bidder and whether there is a modification; the Bid Price(s), including any discounts and alternative offers; the presence of a bid security or Bid-Securing Declaration, if required; and any other details as the Employer may consider appropriate. Only discounts and alternative offers read out at bid opening shall be considered for evaluation. Unless otherwise specified in the BDS, all pages of the Letter of Bid and Bill of Quantities are to be initialed by at least three representatives of the

- Employer attending bid opening. No Bid shall be rejected at bid opening except for late Bids. in accordance with ITB 23.1.
- 25.4 The Employer shall prepare a record of the bid opening that shall include, as a minimum, the name of the Bidder and whether there is a withdrawal, substitution, or modification; the Bid Price, per contract if applicable, including any discounts and alternative offers; and the presence or absence of a bid security or Bid-Securing Declaration, if one was required. The Bidders' representatives who are present shall be requested to sign the record. The omission of a Bidder's signature on the record shall not invalidate the contents and effect of the record. A copy of the record shall be distributed to all Bidders who submitted Bids on time, and posted online when electronic bidding is permitted.

E. Evaluation and Comparison of Bids

26. Confidentiality

- 26.1 Information relating to the examination, evaluation, comparison, and qualification of Bids and recommendation of contract award, shall not be disclosed to Bidders or any other persons not officially concerned with such process until the publication of Contract award.
- 26.2 Any attempt by a Bidder to influence the Employer in the evaluation of the Bids or Contract award decisions may result in the rejection of its Bid.
- 26.3 Notwithstanding ITB 26.2, from the time of bid opening to the time of Contract award, if any Bidder wishes to contact the Employer on any matter related to the bidding process, it may do so in writing.

27. Clarification of Bids

- 27.1 To assist in the examination, evaluation, and comparison of the bids, and qualification of the Bidders, the Employer may, at its discretion, ask any Bidder for a clarification of its Bid. Any clarification submitted by a Bidder that is not in response to a request by the Employer shall not be considered. The Employer's request for clarification and the response shall be in writing. No change in the prices or substance of the Bid shall be sought, offered, or permitted, except to confirm the correction of arithmetic errors discovered by the Employer in the evaluation of the Bids, in accordance with ITB 31.
- 27.2 If a Bidder does not provide clarifications of its Bid by the date and time set in the Employer's request for clarification, its Bid may be rejected.

28. Deviations, Reservations, and Omissions

- 28.1 During the evaluation of Bids, the following definitions apply:
 - (a) "Deviation" is a departure from the requirements specified in the Bidding Document;
 - (b) "Reservation" is the setting of limiting conditions or withholding from complete acceptance of the requirements specified in the Bidding Document; and
 - (c) "Omission" is the failure to submit part or all of the information or documentation required in the Bidding Document.

29. Determination of Responsiveness

- 29.1 The Employer's determination of a Bid's responsiveness is to be based on the contents of the Bid itself, as defined in ITB11.
- 29.2 A substantially responsive Bid is one that meets the requirements of the Bidding Document without material deviation, reservation, or omission. A material deviation, reservation, or omission is one that,
 - (a) if accepted, would
 - (i) affect in any substantial way the scope, quality, or performance of the Works specified in the Contract; or
 - (ii) limit in any substantial way, inconsistent with the Bidding Document, the Employer's rights or the Bidder's obligations under the proposed Contract; or
 - (b) if rectified, would unfairly affect the competitive position of other Bidders presenting substantially responsive Bids.
- 29.3 The Employer shall examine the technical aspects of the Bid submitted in accordance with ITB 16, Technical Proposal, in particular, to confirm that all requirements of Section 6 (Employer's Requirements) have been met without any material deviation, reservation, or omission.
- 29.4 If a Bid is not substantially responsive to the requirements of the Bidding Document, it shall be rejected by the Employer and may not subsequently be made responsive by correction of the material deviation, reservation, or omission.

30. Nonmaterial Nonconformities

- 30.1 Provided that a Bid is substantially responsive, the Employer may waive any nonconformities in the Bid that do not constitute a material deviation, reservation, or omission.
- 30.2 Provided that a Bid is substantially responsive, the Employer may request that the Bidder submit the necessary information or documentation, within a reasonable period of time, to rectify nonmaterial nonconformities in the Bid related to documentation requirements. Requesting information or documentation on such nonconformities shall not be related to any aspect of the price of the Bid. Failure of the Bidder to comply with the request may result in the rejection of its Bid.
- 30.3 Provided that a Bid is substantially responsive, the Employer shall rectify quantifiable nonmaterial nonconformities related to the Bid Price. To this effect, the Bid Price shall be adjusted, for comparison purposes only, to reflect the price of a missing or nonconforming item or component. The adjustment shall be made using the method indicated in Section 3 (Evaluation and Qualification Criteria).

31. Correction of Arithmetical Errors

- 31.1 Provided that the Bid is substantially responsive, the Employer shall correct arithmetical errors on the following basis:
 - (a) If there is a discrepancy between the unit price and the total price that is obtained by multiplying the unit price and quantity, the unit price shall prevail and the total price shall be corrected, unless in the opinion of the Employer there is an obvious misplacement of the

- decimal point in the unit price, in which case the total price as quoted shall govern and the unit price shall be corrected.
- (b) If there is an error in a total corresponding to the addition or subtraction of subtotals, the subtotals shall prevail and the total shall be corrected.
- (c) If there is a discrepancy between the bid price in the Summary of Bill of Quantities and the bid amount in item (c) of the Letter of Bid, the bid price in the Summary of Bill of Quantities will prevail and the bid amount in item (c) of the Letter of Bid will be corrected.
- (d) If there is a discrepancy between words and figures, the amount in words shall prevail, unless the amount expressed in words is related to an arithmetic error, in which case the amount in figures shall prevail subject to (a), (b) and (c) above.
- 31.2 If the Bidder that submitted the lowest evaluated Bid does not accept the correction of errors, its Bid shall be disqualified and its bid security may be forfeited, or its bid securing declaration executed.
- 32. Conversion to Single Currency
- 32.1 For evaluation and comparison purposes, the currency(ies) of the Bid shall be converted into a single currency as specified in the BDS.
- 33. Domestic Preference
- 33.1 Unless otherwise specified in the BDS, domestic preference shall not apply.
- 34. Subcontractors
- 34.1 Unless otherwise stated in the BDS, the Employer does not intend for the contractor to execute any specific elements of the Works through nominated subcontractors.
- 35. Evaluation and Comparison of Bids
- 35.1 The Employer shall use the criteria and methodologies listed in this Clause. No other evaluation criteria or methodologies shall be permitted.
- 35.2 To evaluate a Bid, the Employer shall consider the following:
 - (a) the bid price, excluding Provisional Sums and the provision, if any, for contingencies in the Summary Bill of Quantities, but including Daywork items, where priced competitively;
 - (b) price adjustment for correction of arithmetic errors in accordance with ITB 31.1;
 - (c) price adjustment due to discounts offered in accordance with ITB 14.4;
 - (d) converting the amount resulting from applying (a) to (c) above, if relevant, to a single currency in accordance with ITB 32;
 - (e) adjustment for nonmaterial nonconformities in accordance with ITB 30.3:
 - (f) assessment whether the bid is abnormally low in accordance with ITB 36; and
 - (g) application of all the evaluation factors indicated in Section 3 (Evaluation and Qualification Criteria).

35.3 The estimated effect of the price adjustment provisions of the Conditions of Contract, applied over the period of execution of the Contract, shall not be taken into account in bid evaluation.

- 35.4 If this Bidding Document allows Bidders to quote separate prices for different contracts, and the award to a single Bidder of multiple contracts, the methodology to determine the lowest evaluated price of the contract combinations, including any discounts offered in the Letter of Bid, is specified in Section 3 (Evaluation and Qualification Criteria).
- 35.5 The Employer shall compare all substantially responsive Bids to determine the lowest evaluated Bid price, in accordance with ITB 35.2.

36. Abnormally Low Bids

- 36.1 An abnormally low bid is one where the bid price, in combination with other elements of the bid, appears to be so low that it raises concerns as to the capability of the Bidder to perform the contract for the offered bid price.
- 36.2 When the offered bid price appears to be abnormally low, the Employer shall undertake a three-step review process as follows:
 - (a) identify abnormally low costs and unit rates by comparing them with the Engineer's estimates, other substantially responsive bids, or recently awarded similar contracts;
 - (b) clarify and analyze the bidder's resource inputs and pricing, including overheads, contingencies and profit margins; and
 - (c) decide whether to accept or reject the bid.
- 36.3 With regard to ITB 36.2 (b) above, the Employer will seek a written explanation from the bidder of the reasons for the offered bid price, including a detailed analysis of costs and unit prices, by reference to the scope, proposed methodology, schedule, and allocation of risks and responsibilities. This may also include information regarding the economy of the manufacturing process; the services to be provided, or the construction method to be used; the technical solutions to be adopted; and any exceptionally favorable conditions available to the bidder for the works, equipment or services proposed.
- 36.4 After examining the explanation given and the detailed price analyses presented by the bidder, the Employer may:
 - (a) accept the bid, if the evidence provided satisfactorily accounts for the low bid price and costs, in which case the bid is not considered abnormally low;
 - (b) accept the bid, but require that the amount of the performance security be increased at the expense of the bidder to a level sufficient to protect the Employer against financial loss. The amount of the performance security shall generally be not more than 20% of the contract price; or
 - (c) reject the bid if the evidence provided does not satisfactorily account for the low bid price, and make a similar determination for the next ranked bid, if required.

37. Unbalanced or Front-Loaded Bids

- 37.1 If the Bid, which results in the lowest evaluated Bid Price, is seriously unbalanced or front-loaded in the opinion of the Employer, the Employer may require the Bidder to produce detailed price analyses for any or all items of the Bill of Quantities, to demonstrate the internal consistency of those prices with the construction methods and schedule proposed, as well as the pricing and sources of materials, equipment and labor.
- 37.2 After the evaluation of the information and detailed price analyses presented by the Bidder, the Employer may as appropriate:
 - (a) accept the Bid; or
 - (b) accept the Bid, but require that the total amount of the Performance Security be increased at the expense of the Bidder to a level sufficient to protect the Employer against financial loss in the event of default of the successful Bidder under the Contract subject to ITB 44.2; or
 - (c) reject the Bid and make a similar determination for the next ranked bid.

38. Qualification of the Bidder

- 38.1 The Employer shall determine to its satisfaction whether the Bidder that is selected as having submitted the lowest evaluated and substantially responsive Bid meets the qualifying criteria specified in Section 3 (Evaluation and Qualification Criteria).
- 38.2 The determination shall be based upon an examination of the documentary evidence of the Bidder's qualifications submitted by the Bidder, pursuant to ITB 17.1. Unless permitted in the BDS, the determination shall not take into consideration the qualifications of other firms such as the Bidder's subsidiaries, parent entities or affiliates.
- 38.3 An affirmative determination shall be a prerequisite for award of the Contract to the Bidder. The Employer reserves the right to reject the bid of any Bidder found to be in circumstances described in GCC 15.2(e). A negative determination shall result in disqualification of the Bid, in which event the Employer shall proceed to the next lowest evaluated bid to make a similar determination of that Bidder's qualifications to perform satisfactorily.
- 39. Employer's Right to Accept Any Bid, and to Reject Any or All Bids
- 39.1 The Employer reserves the right to accept or reject any Bid, and to annul the bidding process and reject all Bids at any time prior to contract award, without thereby incurring any liability to Bidders. In case of annulment, all Bids submitted and specifically bid securities, shall be promptly returned to the Bidders.
- 40. Notice of Intention for Award of Contract
- 40.1 If Standstill provisions apply as specified in the BDS, the standstill period shall be defined in the BDS to specify the duration subsequent to notification of intention for award of contract (before making the actual contract award) within which any unsuccessful bidder can challenge the proposed award.

F. Award of Contract

- 41. Award Criteria
- 41.1 The Employer shall award the Contract to the Bidder whose offer has been determined in line with ITB 35 to ITB 37 above to be the lowest evaluated Bid and is substantially responsive to the Bidding Document,

provided further that the Bidder is determined to be qualified to perform the Contract satisfactorily.

42. Notification of Award

- 42.1 Prior to the expiration of the period of bid validity and upon expiry of the standstill period specified in ITB 40.1; or upon satisfactory resolution of a complaint filed within standstill period, if applicable, the Employer shall transmit the Notification of Award through issuance of Letter of Acceptance using the form included in Section 9 (Contract Forms) to the successful Bidder, in writing, that its Bid has been accepted. At the same time, the Employer shall also notify all other Bidders of the results of the bidding.
- 42.2 Unless standstill period applies, upon notification of award through issuance of Letter of Acceptance, unsuccessful Bidders may request in writing to the Employer for a debriefing seeking explanations on the grounds on which their Bids were not selected. The Employer shall promptly respond in writing and/or in a debriefing meeting to any unsuccessful Bidder who, after publication of contract award, requests a debriefing.
- 42.3 Until a formal contract is prepared and executed, the notification of award through issuance of Letter of Acceptance shall constitute a binding Contract.
- 42.4 Within 2 weeks of the award of contract or expiry of the standstill period, where such period applies; or, if a complaint has been filed within the standstill period, upon receipt of ADB's confirmation of satisfactory resolution of the complaint, the borrower shall publish in an English language newspaper or widely known and freely accessible website the results identifying the bid and lot or package numbers, as applicable and the following information:
 - (a) name of each Bidder who submitted a Bid;
 - (b) bid prices as read out at bid opening;
 - (c) name and evaluated prices of each Bid that was evaluated;
 - (d) name of bidders whose bids were rejected and the reasons for their rejection; and
 - (e) name of the winning Bidder, and the price it offered, as well as the duration and summary scope of the contract awarded.

43. Signing of Contract

- 43.1 Promptly after notification, the Employer shall send the successful Bidder the Contract Agreement.
- 43.2 Within 28 days of receipt of the Contract Agreement, the successful Bidder shall sign, date, and return it to the Employer.

44. Performance Security

44.1 Within 28 days of the receipt of notification of award through issuance of Letter of Acceptance from the Employer, the successful Bidder shall furnish the performance security in accordance with the Conditions of Contract, subject to ITB 36 and ITB 37, using for that purpose the Performance Security Form included in Section 9 (Contract Forms), or another form acceptable to the Employer. If the bank issuing performance security is located outside the Employer's country, it shall

- be counter-guaranteed or encashable by a bank in the Employer's country.
- 44.2 Failure of the successful Bidder to submit the abovementioned performance security or to sign the Contract Agreement shall constitute sufficient grounds for the annulment of the award and forfeiture of the bid security or execution of the Bid-Securing Declaration. In that event, the Employer may award the Contract to the next lowest evaluated Bidder whose offer is substantially responsive and is determined by the Employer to be qualified to perform the Contract satisfactorily.
- 44.3 The above provision shall also apply to the furnishing of a domestic preference security if so required.

45. Bidding-Related Complaints

45.1 The procedures for dealing with Bidding-Related Complaints arising out of this bidding process are specified in the BDS.

Section 2: Bid Data Sheet 2-1

Section 2: Bid Data Sheet

This Section consists of provisions that are specific to each procurement and supplement the information or requirements included in Section 1 (Instructions to Bidders).

A. General

ITB 1.1	The number of the Invitation for Bids (IFB) is: EFAP/KPID/CW-03	
ITB 1.1	The Employer is: Irrigation Department, Government of Khyber Pakhtunkhwa	
ITB 1.1	The name of the open competitive bidding (OCB) is: Package-3: EFAP/KPID/CW-03: Rehabilitation of Canals and Drains, District DI Khan – Paharpur Irrigation Division	
	The identification number of the OCB is: EFAP/KPID/CW-03	
	The number and identification of lots comprising this OCB is: None	
ITB 2.1	The Borrower is: Islamic Republic of Pakistan	
ITB 2.1	The name of the Project is: Emergency Flood Assistance Project (EFAP)	
ITB 4.1(b)	Representative: The Joint Venture shall nominate a Representative from the Lead Partner.	

B. Contents of Bidding Documents

ITB 7.1	For clarification p	urposes only, the Employer's address is:
	Attention:	Project Director Project Management Office Pehur High Level Canal Extension Project/ Emergency Flood Assistance Project Khyber Pakhtunkhwa, Irrigation Department
	Street address:	Gohati, Swabi
	Floor/ Room number:	Office of the Project Director
	City:	Swabi, Khyber Pakhtunkhwa
	ZIP code:	23430
	Country:	Islamic Republic of Pakistan
	Telephone:	+92-(938)-530103
	E-mail address:	pmophice@gmail.com / efapirrigation@gmail.com
ITB 7.4	A Pre-Bid meeting	will be take place.
	Date:	25 October 2023
	Time:	1100 Hours (PST)
	Place:	Project Management Office
		Pehur High Level Canal Extension Project/ Emergency Flood Assistance Project
		Khyber Pakhtunkhwa, Irrigation Department
	City:	Gohati, Swabi

2-2 Section 2: Bid Data Sheet

Country:	Islamic Republic of Pakistan
Telephone:	+92-(938)-530103
encouraged to co	ducted by the Employer will not be organized. Bidders are and uct site visit on their own and contact the Employer and the scheduling / making the site visit.

C. Preparation of Bids

	C. Preparation of Bids
ITB 10.1	The language of the Bid is: English. The translation of the documents shall be duly notarized
	·
ITB 11.1 (h)	The Bidder shall submit with its Bid the following additional documents: Documents indicating the Historical Financial Performance i.e., audited financial statements for the Financial Year 2019-20, 2020-21 & 2021-22 of the bidders which close their accounts on June 30 th every year OR Calendar Year 2020, 2021 & 2022 of the bidders which close their accounts on 31 st December every year or for latest three years, as applicable.
	Supporting documents indicating availability of Financial Resources shown by the bidder to meet with the Cash Flow Requirements (refer 2.1 of Section 3) i.e., latest year's audited financial statements, the line of credit should be (i) project specific; (ii) address to the Client; (iii) shall be issued within last 03 month; (iv) it should be confirmed by the concerned bank(s); (v) it should be unconditional; and (vi) it must be for the complete duration of the Project).
	Bidders are required to submit all documents to support their bid in English language. If the documentary evidence is in a language other than the English language, then the bidder shall submit accurate translation of the relevant passages in the English language duly attested by the notary public of the Bidder's Country or similar legal instrument of notarization as applicable under the laws of the Bidder's home country, (specifying the authority for such attestation as per law of the country).
	If a Bidder omits to submit any of the above documents or the documents submitted are deficient, the Bid shall not be rejected in the first instance and a clarification will be sought from the Bidder under ITB 27.
ITB 11.2	In addition to the requirement under ITB 4.1, the Joint Venture Agreement or a Letter of Intent to execute a Joint Venture Agreement in the event of the successful Bid, shall include the following:
	(a) The lead partner shall be clearly identified and nominated.
	(b) The financial share of each partner shall be clearly stated.
	(c) Corresponding to the financial share of each Partner, the roles and responsibilities of each partner shall also be specified; and
	(d) Any other requirements as per the applicable law.
ITB 12.1	The units and rates in figures entered into the Bill of Quantities and Daywork Schedule should be typewritten, if written by hand, must be in print form. Bill of Quantities and Daywork Schedule not presented accordingly may be considered nonresponsive.

Section 2: Bid Data Sheet 2-3

ITB 13.1	Alternative Bids shall not be permitted.	
ITB 13.2	Alternative times for completion shall not be permitted.	
ITB 13.4	Alternative technical solutions shall be permitted for the following parts of the Works: Not Applicable	
ITB 14.5	The prices quoted by the Bidder Adjustable .	
ITB 15.1	The unit rates and the prices shall be quoted by the Bidder entirely in "Pakistan Rupees".	
ITB 15.4	The rates of exchange shall be the selling rates 28 days prior to the deadline for submission of bids published by State Bank of Pakistan .	
ITB 18.1	The bid validity period shall be Sixty (60) days .	
ITB 19.1	The Bidder shall furnish a Bid-Securing Declaration	
ITB 19.2	The ineligibility period is: Five (05) Years	
ITB 19.4	Subject to the succeeding sentences, any bid not accompanied by Bid-Securing Declaration shall be rejected by the Employer as nonresponsive. If a Bidder submits a Bid-Securing Declaration that (i) deviates in form, content, and/or period of validity or (ii) does not provide sufficient identification of the Bidder (including, without limitation, failure to indicate the name of the Joint Venture or, where the Joint Venture has not yet been constituted, the names of all future Joint Venture Partners), the Employer shall request the Bidder to submit a compliant Bid-Securing Declaration within fourteen (14) days of receiving such a request. Failure to provide a compliant Bid-Securing Declaration within the prescribed period of receiving such a request shall cause the rejection of the Bid	
ITB 20.1	In addition to the original Bid, the number of copies is: Three (03)	
	To facilitate evaluation, bidders are encouraged to submit the scanned soft copies, in PDF format, of their Bids in shape of a USB Drive.	
	The soft copy (USB) of the Bids shall be enclosed in the envelope containing the hard copy of the Bidder's Original Bid.	
	If there is any discrepancy between the data/information in the soft copy (USB) of the Bidder's Bids and the hard copy of the Bidder's Bids and between the Price indicated in the hard copy of the Bidder's Original Price Bid, and in the soft copy (USB) of the Bidder's Price Bid, the data and information indicated in the hard copy of the Original Bid shall prevail. All of the rates and amounts must be written by the bidder in words that are written in figures.	
	In addition to above, soft copy of Priced Bid in "Excel format", in the same USB containing the "PDF format", shall also be provided in the envelope containing the hard copy of the Bidder's Original Price Bid, to facilitate review and evaluation process.	
	Note: Submission of the USB is only for reference and shall not constitute electronic bid submission as stipulated in ITB 21.1(b) and is provision in the Data Sheet.	

2-4 Section 2: Bid Data Sheet

ITB 20.2	The written confirmation of authorization to sign on behalf of the Bidder shall consist of a board resolution or its equivalent, or power of attorney, which should either be:	
	a) notarized, or	
	b) attested to by an appropriate forum (authority) in the Bidder's home country, specifying the representative's authority to sign the bid on behalf of the bidder.	
	If the bidder is an intended or existing joint venture, such authorization should be signed by all parties and specify the representative's authority to sign the bid on behalf of the intended or existing joint venture.	
	If the joint venture has not yet been formed, also include written evidence from all proposed partners of joint venture of their intent to enter into a joint venture in the event of a contract award.	
ITB 20.2	The Bidder shall submit an acceptable authorization within fourteen (14) days.	

D. Submission and Opening of Bids

ITB 21.1	Bidders shall submit their Bids by mail or by hand.		
ITB 21.1 (b)	Electronic bidding submission procedures shall be: Not Applicable.		
ITB 22.1	For <u>bid submissio</u> Attention:	Project Director Project Management Office Pehur High Level Canal Extension Project/ Emergency Flood Assistance Project Khyber Pakhtunkhwa, Irrigation Department	
	Street address: Floor/ Room number:	Gohati, Swabi Office of the Project Director	
	City: ZIP code:	Swabi, Khyber Pakhtunkhwa 23430	
	Country: Telephone:	Islamic Republic of Pakistan +92-(938)-530103	
	E-mail address:	pmophice@gmail.com / efapirrigation@gmail.com	
	The deadline for bid submission is:		
	Date: Time:	02 November 2023 1100 Hours	
ITB 25.1	The bid opening sh	nall take place at:	
	Street address:	Office of the Project Director Project Management Office Pehur High Level Canal Extension Project/ Emergency Flood Assistance Project Khyber Pakhtunkhwa, Irrigation Department	
	Floor / Room number:	Office of the Project Director	
	City:	Gohati, Swabi, Khyber Pakhtunkhwa 23430	
	Country:	Islamic Republic of Pakistan	
	Date:	02 November 2023	

Section 2: Bid Data Sheet 2-5

	Time: 1130 Hours
ITB 25.1	Electronic bid opening procedure shall be as follows: Not Applicable
ITB 25.3	The Letter of Bid and Bill of Quantities shall be initialled by at least three (03) representatives of the Employer attending the Bid opening.

E. Evaluation and Comparison of Bids

ITB 32.1	The currency that shall be used for bid evaluation and comparison purposes to convert all bid prices expressed in various currencies into a single currency is: Pak Rupees (PKR)	
	The source of the selling exchange rate shall be: State Bank of Pakistan	
	The date for the selling exchange rate shall be: 28 days prior to the deadline for submission of bids.	
ITB 33.1	Domestic preference shall not apply.	
ITB 34.1	The Employer does not intend for the contractor to execute any specific elements of the Works through nominated Subcontractors.	
ITB 38.2	Qualifications of other firms such as the Bidder's subsidiaries , parent entities , affiliates , subcontractors (other than Specialist Subcontractors permitted in ITB 38.2) shall not be permitted.	
ITB 40.1	Standstill provisions shall not apply.	

F. Award of Contracts

ITB 45.1	The procedures for Bidding-Related Complaints are referenced in the Procurement Regulations for ADB Borrowers (Appendix 7). The Bidder should submit its complaint following these procedures, in writing, to:		
	Title or position:	Secretary	
	Client:	Irrigation Department, Government of Khyber Pakhtunkhwa	
	Address:	Civil Secretariat, Peshawar	
	Project:	Emergency Flood Assistance Project (EFAP)	

Section 3: Evaluation and Qualification Criteria - Following Prequalification -

This Section contains all the criteria that the Employer shall use to evaluate bids and qualify Bidders. In accordance with ITB 35 to ITB 38, no other methods, criteria and factors shall be used. The Bidder shall provide all the information requested in the forms included in Section 4 (Bidding Forms).

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1. Evaluation

In addition to the criteria listed in ITB 35.2 (a)–(f), other relevant factors are as follows:

1.1 Adequacy of Technical Proposal

Evaluation of the Bidder's Technical Proposal will include an assessment of the Bidder's technical capacity to successfully implement the contract considering its proposed site organization, method statement, mobilization, and construction schedule (to be described by the Bidder in sufficient detail to demonstrate the adequacy of its work methods, scheduling, and material sourcing) including the extent to which they are presented in a consistent manner and comply with requirements stipulated in Section 6 (Employer's Requirements) without material deviation, reservation, or omission.

Noncompliance with equipment and personnel requirements described in Section 6 (Employer's Requirements) shall not normally be a ground for bid rejection, and such noncompliance will be subject to clarification during bid evaluation and rectification prior to contract award.

1.2 Completion Time

An alternative Completion Time, if permitted under ITB 13.2, will be evaluated as follows:

Not Applicable

1.3 Technical Alternatives

Technical alternatives, if permitted under ITB 13.4, will be evaluated as follows:

Not Applicable

1.4 Quantifiable Nonconformities and Omissions

Subject to ITB 14.2 and ITB 35.2, the evaluated cost of quantifiable nonconformities including omissions, is determined as follows:

Pursuant to ITB 30.3, the cost of all quantifiable nonmaterial nonconformities shall be evaluated, including omissions in Daywork where competitively priced but excluding omission of prices in the Bill of Quantities. The Employer will make its own assessment of the cost of any nonmaterial nonconformities and omissions for the purpose of ensuring fair comparison of Bids.

1.5 Domestic Preference

If domestic preference is provided for under ITB 33.1, the following procedure shall apply:

Not Applicable

1.6 Other Criteria

The Other Criteria is described as under:

1.6.1 Environmental, Health and Safety Management Plan (EHSMP)

Any bid not accompanied by the EHSMP may be rejected by the Employer as nonresponsive. If a Bidder submits a EHSMP that is not commensurate with the risks and impacts of the proposed works and activities in the bidding document, the Employer shall issue a request for clarification to request for further information from the Bidder. The Bidder must submit the requested information within **five (05)** days of receiving such a request. Failure to provide a satisfactory response to the request for further information within the prescribed period of receiving such a request may cause the rejection of the Bid.

1.6.2 Sustainable Procurement

Not Applicable.

1.6.3 Life Cycle costs (for Financial Evaluation)

Life cycle costing shall not apply.

1.8 Multiple Contracts

Works are grouped in multiple contracts and pursuant to ITB 35.4, the Employer shall evaluate and compare Bids on the basis of a contract, or a combination of contracts, or as a total of contracts in order to arrive at the least-cost combination for the Employer by taking into account discounts offered by Bidders in case of award of multiple contracts.

If a Bidder as defined in ITB 4.1 submits several successful (lowest evaluated substantially responsive) bids, the evaluation will also include an assessment of the Bidder's capacity to meet the following aggregated requirements as presented in the bid:

- Average annual construction turnover,
- Financial resources,
- Equipment to be allocated, and
- Personnel to be fielded.

2. Qualification

2.1 Financial Resources

If the bid evaluation process and the decision for the award of the Contract takes more than 1 year from the date of bid submission, Bidders may be asked to resubmit their current contract commitments and latest information on financial resources supported by latest audited accounts or audited financial statements, or if not required by the law of the Bidder's country, other financial statements acceptable to the Employer, and the Bidders' financial capacity, will be reassessed on this basis.

Criteria	Compliance Requirements			Documents	
		Joint Venture			Submission
Requirement	Single Entity	All Partners Combined	Each Partner	One Partner	Requirements
For Single Entities The Bidder must demonstrate that its financial resources defined in FIN-3, less its financial obligations for its current contract commitments defined in FIN-4, meet or exceed the total requirement for the Subject Contract is PKR 253 million or US\$ equivalent	Must meet requirement	Not applicable	Not applicable	Not applicable	Form FIN – 3 and Form FIN – 4
For Joint Ventures (1) One partner must demonstrate that its financial resources defined in FIN-3, less its financial obligations for its own current contract commitments defined in FIN-4, meet or exceed its required share of 40% from the total requirement for the Subject Contract.	Not applicable	Not applicable	Not applicable	Must meet requirement	Form FIN – 3 and Form FIN – 4
AND					
(2) Each partner must demonstrate that its financial resources defined in FIN - 3, less its financial obligations for its own current contract commitments defined in FIN-4, meet or exceed its required share of 25% from the total requirement for the Subject Contract.	Not applicable	Not applicable	Must meet requirement	Not applicable	Form FIN – 3 and Form FIN – 4
AND					
(3) The Joint Venture must demonstrate that the combined financial resources of all partners defined in FIN - 3, less all the partners' total financial obligations for the current contract commitments defined in FIN-4, meet or exceed the total requirement for the Subject Contract of PKR 253 million or US\$ equivalent	Not applicable	Must meet requirement	Not applicable	Not applicable	Form FIN – 3 and Form FIN – 4

2.2 Updating of Information

The Bidder shall continue to meet the criteria used at the time of prequalification. Updating and reassessment of the following information which was previously considered during prequalification will be required:

- (a) Eligibility
- (b) Historical Contract Nonperformance
- (c) Financial Requirements
 - (i) Historical Financial Performance
 - (ii) Average Annual Construction Turnover

The Bidder shall provide updated details for the above by using the relevant forms included in Section 4 (Bidding Forms).

Section 4: Bidding Forms

- Following Prequalification -

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4-2 Section 4: Bidding Forms

Letter of Bid

-Note-

The Bidder must accomplish the Letter of Bid on its letterhead clearly showing the Bidder's complete name and address.

Date:	
OCB No.:	
Invitation for Bid No.:	

To:

Project Director
Project Management Office (PMO),
Pehur High Level Canal Extension Project /
Emergency Flood Assistance Project
Gohati. Swabi

We, the undersigned, declare that:

- (a) We have examined and have no reservations to the Bidding Documents, including Addenda issued in accordance with Instructions to Bidders (ITB) 8.
- (b) We acknowledge that we have read and understand ADB's Anticorruption Policy (1998) and Integrity Principles and Guidelines (2015), both as amended from time to time.
- (c) We offer to execute in conformity with the Bidding Documents the following Works:

Package-3: EFAP/KPID/CW-03: Rehabilitation of Canals and Drains, District DI Khan – Paharpur Irrigation Division

(d) The total price of our Bid, excluding any discounts offered in item (d) below is:

[amount of foreign currency in words], [amount in figures], and [amount of local currency in words], [amount in figures]

The total bid price from the Summary of Bill of Quantities should be entered by the Bidder inside this box. Absence of the total bid price in the Letter of Bid may result in the rejection of the bid.

- (e) The discounts offered and the methodology for their application are: [insert discounts and methodology for their application if any]
- (f) Our bid shall be valid for a period of [insert bid validity period as specified in ITB 18.1 of the BDS] days starts from the date fixed for the bid submission deadline in accordance with ITB 22.1, and it shall remain binding upon us and may be accepted at any time before the expiration of that period.
- (g) If our bid is accepted, we commit to obtain a performance security in accordance with the Bidding Documents.
- (h) Our firm, including any Subcontractors or Suppliers for any part of the Contract, have nationalities from eligible countries in accordance with ITB 4.2.

(i)	We, our directors, key officers, key personnel, including any Subcontractors, consultants, subconsultants, manufacturers, service providers or Suppliers for any part of the contract, do not have any conflict of interest in accordance with ITB 4.3.
	If there is any conflict of interest, please state details: (i) Parties involved in the conflict of interest: (ii) Details about the conflict of interest:
(j)	We are not participating, as a Bidder, either individually or as partner in a Joint Venture, in more than one Bid in this bidding process in accordance with ITB 4.3(e), other than alternative offers submitted in accordance with ITB 13.
(k)	Our firm, Joint Venture partners, our respective direct and indirect shareholders, directors, key officers, key personnel, associates, parent company, affiliates or subsidiaries, including any Subcontractors, consultants, subconsultants, manufacturers, service providers or Suppliers for any part of the contract, are not subject to, or not controlled by any entity or individual that is subject to a temporary suspension or a debarment imposed by the Asian Development Bank or a debarment imposed by the Asian Development Bank in accordance with the Agreement for Mutual Enforcement of Debarment Decisions between the Asian Development Bank and other development banks. ¹
(I)	Our firm, Joint Venture partners, our respective direct and indirect shareholders, directors, key officers, key personnel, associates, parent company, affiliates or subsidiaries, including any Subcontractors, consultants, subconsultants, manufacturers, service providers or Suppliers for any part of the contract, are not under ongoing investigation and/or sanctions proceedings by the Asian Development Bank or any multilateral development bank.
	If under ongoing investigation and/or sanction proceedings by the Asian Development Bank or any multilateral development bank, please state details: (i) Name of the multilateral development bank: (ii) Reason for the ongoing investigation/allegations:
(m)	Our firm, Joint Venture partners, our respective direct and indirect shareholders, directors, key officers, key personnel, associates, parent company, affiliates or subsidiaries, including any Subcontractors, consultants, subconsultants, manufacturers, service providers or Suppliers for any part of the Contract, are not temporarily suspended, debarred, declared ineligible, or subject to any national and/or international sanctions by any country, any international organization, any multilateral development bank and other donor agency.
	If so temporarily suspended, debarred, declared ineligible, or subject to any national and/or international sanctions by any country, any international organization, any multilateral development bank and other donor agency, please state details (as applicable to each Joint Venture partner, their respective direct or indirect shareholders, directors, key officers, key personnel, associate, parent company, affiliate, subsidiaries, Subcontractors, consultants, subconsultants, manufacturers, service providers and/or Suppliers): (i) Name of Institution:
	 (ii) Period of the temporary suspension, debarment, ineligibility, or national or international sanction [start and end date]: (iii) Reason for the temporary suspension, debarment, ineligibility, or national or international sanction:
	e institutions include African Development Bank, European Bank for Reconstruction and Development (EBRD), Inter-Americopment Bank (IADB), and the World Bank Group. According to paragraph 9 of the Agreement, other international finan

These institutions include African Development Bank, European Bank for Reconstruction and Development (EBRD), Inter-American Development Bank (IADB), and the World Bank Group. According to paragraph 9 of the Agreement, other international financial institutions may join upon the consent of all Participating Institutions and signature of a Letter of Adherence by the international financial institution substantially in the form provided (Annex B to the Agreement). Upon adherence, such international financial institution shall become a Participating Institution for purposes of the Agreement. Bidders are advised to check www.adb.org/integrity for updates.

(n)	Our firm, Joint Venture partners, associates, parent company, affiliates or subsidiaries, including any Subcontractors, consultants, subconsultants, manufacturers, service providers, Suppliers, key officers, directors and key personnel have never been charged or convicted with any criminal offense (including felonies but excluding misdemeanors) or infractions and/or violations of ordinance; nor charged or found liable in any civil or administrative proceedings in the last 10 years; or undergoing investigation for such, or subject to any criminal, civil or administrative orders, monitorship or enforcement actions. If so charged, convicted found liable, under ongoing investigation, or subject to orders, monitorship or enforcement actions, please state details: (i) Nature of the offense, violation, proceedings, investigation, and/or monitorship or enforcement actions: (ii) Court, area of jurisdiction and/or the enforcement agency: (iii) Resolution [i.e. dismissed, settled, or convicted; duration of penalty]: (iv) Other relevant details [please specify]:				
(0)	Our firm, Joint Venture partners, our respective direct and indirect shareholders, directors, key officers, key personnel, associates, affiliates or subsidiaries, including any Subcontractors, consultants, subconsultants, manufacturers, service providers or Suppliers, can make and receive electronic fund transfer payments through the international banking system or otherwise discharge the Employer's obligation upon initiation of wire transfer.				
	If unable to make or receive funds through the international banking system or otherwise discharge the Employer's obligation upon initiation of wire transfer, please state the details: (i) Nature of the restriction: (ii) Jurisdiction of the restriction: (iii) Other relevant details:				
(p)	Our firm, Joint Venture partners, associates, parent company, affiliates or subsidiaries, including any Subcontractors, consultants, subconsultants, manufacturers, service providers or Suppliers, key officers, directors and key personnel are not from a country which is prohibited to export goods or services to, or receive any payments from the Employer's country and/or are not prohibited to receive payments for particular goods or services by the Employer's country by an act of compliance with a decision of the United Nations Security Council taken under Chapter VII of the Charter of the United Nations.				
(q)	We understand that it is our obligation to notify the Employer of any changes in connection with the matters described in paragraphs (i), (k), (l), (m), (n), (o), (p) and (t) of this Letter of Bid.				
(r)	[We are not a government-owned enterprise] / [We are a government-owned enterprise but meet the requirements of ITB 4.5]. ²				
(s)	We have not been suspended nor declared ineligible by the Employer based on execution of a Bid-Securing Declaration in accordance with ITB 4.6.				
(t)	We have paid, or intend to pay, either directly or indirectly, the following commissions, gratuities, or fees with respect to the bidding process or execution of the Contract: ³				
	Name of Recipient Address Reason Amount				

Use one of the two options as appropriate. If none has been paid or is to be paid, indicate "None".

(u) We understand that this bid, together with your written acceptance thereof included in your notification of award through the issuance of Letter of Acceptance, shall constitute a binding contract between us, until a formal contract is prepared and executed.

- (v) We understand that you are not bound to accept the lowest evaluated bid or any other bid that you may receive.
- (w) At any time following submission of our Bid, we shall permit, and shall cause our Joint Venture partners, directors, key officers, key personnel, associates, parent company, affiliates or subsidiaries, including any Subcontractors, consultants, subconsultants, manufacturers, service providers or Suppliers for any part of the contract to permit ADB or its representative to inspect our site, assets, accounts and records and other documents relating to the bid submission and to have them audited by auditors appointed by ADB. We understand that failure of this obligation may constitute obstructive practice that may result in debarment and/or contract termination.
- (x) Regardless of whether the contract will be awarded to us, we shall preserve all accounts, records and other documents related to bid submission for at least 3 years from the date of submission of the bid or the period prescribed in applicable law, whichever is longer.
- (y) If we are awarded the contract, we shall preserve all accounts, records and other documents related to the procurement and execution of the contract for at least 5 years after completing the works contemplated in the relevant contracts or the period prescribed in applicable law, whichever is longer.
- (z) If our Bid is accepted, we commit to mobilizing key equipment and personnel in accordance with the requirements set forth in Section 6 (Employer's Requirements) and our technical proposal, or as otherwise agreed with the Employer.
- (aa) We certify on behalf of the Bidder, that the information provided in the bid has been fully reviewed, given in good faith, and to the best of our knowledge is true and complete. We understand that it is our obligation to inform the Employer of any changes to the information as and when it becomes known to us. We understand that any misrepresentation that knowingly or recklessly misleads, or attempts to mislead may lead to the automatic rejection of the Bid or cancellation of the contract, if awarded; and may result in remedial actions, in accordance with ADB's Anticorruption Policy (1998, as amended to date) and Integrity Principles and Guidelines (2015, as amended from time to time).

Name
In the capacity of
Signed
Duly authorized to sign the Bid for and on behalf of
Date

4-6 Section 4: Bidding Forms

Schedules

Schedule of Payment Currencies

Package-3: EFAP/KPID/CW-03: Rehabilitation of Canals and Drains, District DI Khan – Paharpur Irrigation Division

	Α	В	С	D
Name of Payment Currency	Amount of Currency	Rate of Exchange to Local Currency	Local Currency Equivalent C = A x B	Percentage of Net Bid Price (NBP) <u>100xC</u> NBP
Local Currency		1.00		
Foreign Currency #1				
Foreign Currency #2				
Foreign Currency #3				
Net Bid Price				100.00
Provisional Sums Expressed in Local Currency		1.00		
BID PRICE				

Note -

The rates of exchange shall be the selling rates 28 days prior to the deadline for submission of bids published by the source specified in BDS 15.

Tables of Adjustment Data

Table A - Local Currency Payment

Package-3: EFAP/KPID/CW-03: Rehabilitation of Canals and Drains, District DI Khan – Paharpur Irrigation Division

S/No	Description	Unit	*Base Rate	Weightages	Source of Index (District: DI Khan)
(i)	Fixed Portion	-		0.15	-
(ii)	High Speed Diesel	Litres		To be proposed by the bidder (Acceptable range 0.32 to 0.35)	Monthly Statistical Bulletin, Pakistan Bureau of Statistics / Pakistan State Oil
(iii)	Labour	Per Day		To be proposed by the bidder (Acceptable range 0.18 to 0.20)	Monthly Statistical Bulletin, Pakistan Bureau of Statistics GOP
(iv)	All types of Steel	Per Ton		To be proposed by the bidder (Acceptable range 0.13 to 0.15)	Monthly Statistical Bulletin, Pakistan Bureau of Statistics GOP
(v)	Cement	Per Bag		To be proposed by the bidder (Acceptable range 0.14 to 0.15)	Monthly Statistical Bulletin, Pakistan Bureau of Statistics GOP
		Total		1.000 [Sum of (ii), (iii), (iv) and (v) shall not exceed 0.85]	

Note:


- 1. Base prices of Specified Material shall be as of actually prevailing market on the base date notified by the Engineer with the approval of the Employer after the award of works. The Base Date means the date 28 days prior to the deadline for the bid submission.
- 2. The basic material prices are meant to be ex-factory prices and inclusive all kinds of taxes and duties that can be levied at source.
- 3. Adjustment of increase/ decrease shall only be admissible for the materials listed above.
- 4. All amounts shall be in Pakistani Rupees.
- 5. Value of work done for escalation purpose shall be value of permanent works (excluding bill for General items and Provisional sums)
- 6. The proposed weightages of bidders exceeding the upper limit shall not be permitted.
- 7. All amounts in Pak Rupees Only.

4-8 Section 4: Bidding Forms

Table B - Foreign Currency Payment

Name of Currency:

[Insert name of currency. If the bidder wishes to quote in more than one foreign currency, this table should be repeated for each foreign currency such as #1, #2 and #3..]

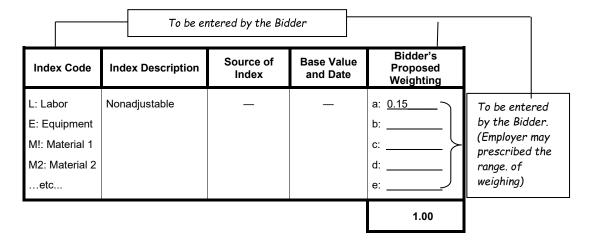

- Notes -

- As per GCC 1.1.3.1, "Base Date" means the date 28 days prior to the latest date for submission of the bid.
- For a given currency, the "Source of Index" should be issued or published within the country to which the currency relates
- Tables of Adjustment Data shall only be included if prices are to be quoted as adjustable prices in accordance with ITB 14.5.

Bid Security Bank Guarantee

[Bank's name, and address of issuing branch or office]4

Beneficiary: [Name and address of the Employer]	
Date:	
Bid Security No.:	
•	

We have been informed that [name of the Bidder] (hereinafter called "the Bidder") has sub-litted to you its bid dated [please specify] (hereinafter called "the Bid") for the execution for Bids No. [please specify] ("the IFB").

Furthermore, we understand that, according to your condition it is stop be supported by a bid guarantee.

At the request of the Bidder, we [name of bank] here vevo by undertake to pay you any sum or sums not exceeding in total an amount of [amount in works] [undertake to pay you any sum or sums not exceeding in total an amount of [amount in works] [undertake to pay you any sum or sums not exceeding in total an amount of [amount in works] [undertake to pay you any sum or sums not exceeding in total an amount of [amount in works] [undertake to pay you any sum or sums not exceeding in total an amount of [amount in works] [undertake to pay you any sum or sums not exceeding in total an amount of [amount in works] [undertake to pay you any sum or sums not exceeding in total an amount of [amount in works] [undertake to pay you any sum or sums not exceeding in total an amount of [amount in works] [undertake to pay you any sum or sums not exceeding in total an amount of [amount in works] [undertake to pay you any sum or sums not exceeding in total an amount of [amount in works] [undertake to pay you any sum or sum or sum of [amount in works] [undertake to pay you any sum or sum or sum of [amount in works] [undertake to pay you any sum or sum or sum of [amount in works] [undertake to pay you any sum or sum of [amount in works] [undertake to pay you any sum or sum of [amount in works] [undertake to pay you any sum or sum of [amount in works] [undertake to pay you any sum or sum of [amount in works] [undertake to pay you any sum or sum of [amount in works] [undertake to pay you any sum or sum of [amount in works] [undertake to pay you any sum or sum of [amount in works] [undertake to pay you any sum or sum of [amount in works] [undertake to pay you any sum or sum of [amount in works] [undertake to pay you any sum or sum of [amount in works] [undertake to pay you any sum or sum of [amount in works] [undertake to pay you any sum or sum of [amount in works] [undertake to pay you any sum or sum of [amount in works] [undertake to pay you any sum or sum or sum of [amount in works] [undertake to pay you any sum or sum or sum or sum o

- (a) has withdrawn its Bid during the brid of bid validity specified by the Bidder in the Letter of Bid; or
- (b) does not accept the corline corline in accordance with the Instructions to Bidders (hereinafter "the ITB");
- having see notified of the acceptance of its Bid by the Employer during the period of bid validity, (i) ail or r uses to execute the Contract Agreement, or (ii) fails or refuses to furnish the security, in accordance with the ITB, or (iii) fails or refuses to furnish a domestic nce security, if required.

This guarantee will expire (a) if the Bidder is the successful Bidder, upon our receipt of copies of the Contract Agreement signed by the Bidder and the Performance Security issued to you upon the instruction of the Bidder; or (b) if the Bidder is not the successful Bidder, upon the earlier of (i) our receipt of a copy of your notification to the Bidder of the name of the successful Bidder, or (ii) 28 days after the expiration of the Bidder's bid.

Consequently, any demand for payment under this guarantee must be received by us at the office indicated above on or before that date.

This guarantee is subject to the Uniform Rules for Demand Guarantees (URDG) 2010 Revision, ICC Publication No. 758.⁵

[Authorized signature(s) and bank's seal (where appropriate)]

All italicized text is for use in preparing this form and shall be deleted from the final document.

Or the employer may use "Uniform Rules for Demand Guarantees (URDG), ICC Publication No. 458 as appropriate.

4-10 Section 4: Bidding Forms

Bid-Securing Declaration

Date: [insert date (as day, month and year)]
Bid No.: [insert number of bidding process]

Alternative No.: [insert identification No if this is a bid for an alternative]

To: [insert complete name of the Employer]

We, the undersigned, declare that:

We understand that, according to your conditions, Bids must be supported by a Bid-Securing Declaration.

We accept that we will automatically be suspended from being eligible for bidding in any contract with the Borrower for the period of time of [insert number of years as indicated in ITB 19.2 of the BDS] starting on the date that we receive a notification from the Employer, if we are in breach of our obligation(s) under the bid conditions, because we

- (a) have withdrawn our Bid during the period of bid validity specified in the Letter of Bid; or
- (b) do not accept the correction of errors in accordance with the Instructions to Bidders (hereinafter "the ITB"); or
- (c) having been notified of the acceptance of our Bid by the Employer during the period of bid validity, (i) fail or refuse to execute the Contract, if required; or (ii) fail or refuse to furnish the Performance Security, in accordance with the ITB; or (iii) fail or refuse to furnish a domestic preference security, if required.

We understand this Bid-Securing Declaration shall expire if we are not the successful Bidder, upon the earlier of (i) our receipt of your notification to us of the name of the successful Bidder; or (ii) 28 days after the expiration of our Bid.

Signed: [insert signature of person whose name and capacity are shown]				
In the capacity of [insert legal capacity of person signing the Bid-Securing Declaration]				
Name: [insert complete name of person signing the Bid-Securing Declaration]				
Duly authorized to sign the bid for and on behalf of [insert complete name of the Bidder]				
Dated on,[insert date of signing]				
Corporate Seal [where appropriate]				

AFFILIATE COMPANY GUARANTEE

Name of Contract/Contract No.:				
Name and Address of Employer:				
[together with successors and assigns].				
We have been informed that [name of Contractor] (he the above-referenced Contract in response to your its offer to be supported by an affiliate company guaranteed to be supported to	reinafter called the "Contractor") subnitting an offer for nvitation, and that the conditions of our vitation require trantee.			
irrevocably and unconditionally guarantee to you, a the Contract, we will make available to the Contractor required for the Contractor's satisfactory performan with the Contractor, to ensuring a satisfactory performan				
If the Contractor fails to so perform its obligations in the Employer against and from all dames, arise from any such failure for which is contractor.	ial ties and comply with the Contract, we will indemnify and expenses (including legal fees and expenses) which is liable to the Employer under the Contract.			
This guarantee shall come into it can deffect when the Contract comes into full force and effect. If the Contract does not come into full force and effect within a year of the date of this guarantee, or if you demonstrate that you do not intend to enter into the Contract with the Contractor, this guarantee shall be voi and ineffective. The uarantee shall continue in full force and effect until all the Contractor's obligations and liabilities under the Contract have been discharged, when this guarantee shall expire and shall be returned to us, and we like the contract with the Contractor of the date of this guarantee shall be returned to the contract with the Contractor, this guarantee shall be returned to us, and we like the contract with the Contractor of the date of this guarantee, or if you demonstrate that you do not intend to enter into the Contract with the Contractor, this guarantee shall be voided in the contract of the contract with the Contractor, this guarantee shall be voided in the contract with the Contractor, this guarantee shall be voided in the contract of the contract of the contract with the Contractor, this guarantee shall be voided in the contract with the Contractor, the contractor of the contra				
the Contractor from time to time. We hereby authore the due performance of which and compliance with we Our obligations and liabilities under this guarantee indulgence whatsoever by the Employer to the Cort	the Contract as amended or varied by the Employer and prize them to agree on any such amendment or variation, which by the Contractor are likewise guaranteed hereunder. It is also be discharged by any allowance of time or other itractor, or by any variation or suspension of the works to ents to the Contract or to the constitution of the Contractor with or without our knowledge or consent.			
Contract and any dispute under this guarantee sha	he same country (or other jurisdiction) that governs the II be finally settled under the [Rules or Arbitration provided in rantee may be assigned subject only to the provisions for			
Signed by: [signature]	Signed by: [signature]			
[name]	[name]			
[position in parent/subsidiary company] Date:	[position in parent/subsidiary company]			

-- Note --

If permitted in accordance with ITB 38.2 of the BDS, the Bidder shall provide the Affiliate Company Guarantee Form filled out and signed by each subsidiary, parent entity or affiliate that the Bidder submits for consideration of the Employer in determining its qualifications.

4-12 Section 4: Bidding Forms

Bill of Quantities

B. Preamble

1. The Bill of Quantities shall be read in conjunction with the Conditions of Contract, Specifications and Drawings.

- 2. The quantities given in the Bill of Quantities are estimated and provisional and are given to provide a common basis for bidding. The basis of payment will be the actual quantities of work executed as per specifications & drawings and measured by the Contractor and verified by the Engineer and valued at the rates and prices entered in the priced Bill of Quantities, where applicable, and otherwise at such rates and prices as the Engineer may fix as per the Contract.
- 3. The rates and prices entered in the priced Bill of Quantities shall, except as otherwise provided under the Contract include all costs of Contractor's plant, labour, supervision, materials, execution, insurance, profit, taxes and duties, as applicable in the Borrower's Country (modified from time to time) together with all general risks, liabilities and obligations set out or implied in the Contract. Furthermore, all duties, taxes and other levies payable by the Contractor under the Contract, or for any other cause, as on the date 28 days prior to deadline for submission of Bids, shall be included in the rates and prices and the total Bid Price submitted by the Bidder.
- 4. A rate or price shall be entered against each item in the priced Bill of Quantities, whether quantities are stated or not. The cost of items against which the Contractor will have failed to enter a rate or price shall be deemed to be covered by other rates and prices entered in the Bill of Quantities. The units and rates in figures entered into the Bill of Quantities should be typewritten or if written by hand, must be in print form. Bill of Quantities not presented accordingly may be considered nonresponsive.
- 5. The whole cost of complying with the provisions of the Contract shall be included in the items provided in the priced Bill of Quantities, and where no items are provided, the cost shall be deemed to be distributed among the rates and prices entered for the related items of the Works such as Employer's requirement in Section 6 of the Bidding Documents including Engineer's Laboratory along with equipment and its running expense, survey equipment and their maintenance for entire project life, Environment Management Plan (EMP), Resettlement Plan etc.
- 6. General directions and descriptions of works and materials are not necessarily repeated not summarized in the Bill of Quantities. Reference to the relevant sections of the Contract documentation shall be made before entering prices against each item in the priced Bill of Quantities.
- 7. Provisional sums included and so designated in the Bill of Quantities shall be expended in whole or in part at the direction and discretion of the Engineer and the Employer in accordance with Conditions of Contract.
- 8. Note: The bid price is inclusive of all Environmental, Health and Safety management and compliance cost.

B. Work Items

- Bill of Quantities (BOQs) are attached.
- 2. Bidders shall Price the Bill of Quantities in Pakistani Rupees Only.

Financial Situation

Form FIN – 3: Availability of Financial Resources

Bidders must demonstrate sufficient financial resources, usually comprising of Working Capital supplemented by credit line statements or overdraft facilities and others to meet the Bidder's financial requirements for

- (a) its current contract commitments, and
- (b) the subject contract.

In case of a Joint Venture, each Joint Venture Partner must fill out this form separately and provide the Joint Venture Partner's name:

Joint Venture Partner:	

	Financial Resources					
No.	Source of financing	Amount (PKR or \$ equivalent)				
1	Working Capital (to be taken from FIN - 1)					
2	Credit Line ^a					
3	Other Financial Resources					
	Total Available Financial Resources					

To be substantiated by a letter from the bank issuing the line of credit (i) project specific; (ii) address to the Client; (iii) shall be issued within last 03 month; (iv) it should be confirmed by the concerned bank(s); (v) it should be unconditional; and (vi) it must be for the complete duration of the Project).

4-14 Section 4: Bidding Forms

Form FIN - 4: Financial Requirement for Current Contract Commitments

Bidders (or each Joint Venture partner) should provide information on their current commitments on all contracts that have been awarded, or for which a letter of intent or acceptance has been received, or for contracts approaching completion, but for which an unqualified, full completion certificate has yet to be issued.

In case of a Joint Venture, each Joint Venture Partner must fill out this form separately and provide the Joint Venture Partner's name:

Joint Venture Partner:					

Current Contract Commitments

No.	Name of Contract	Employer's Contact (Address, Tel, Fax)	Contract Completion Date	Outstanding Contract Value (X) ^a	Remaining Contract Period in months (Y) ^b	Monthly Financial Resources Requirement (X / Y)	
1							
2							
3							
4							
	Total Monthly Financial Requirements for Current Contract Commitments PKR or \$ equivalent						

Remaining outstanding contract values to be calculated from 28 days prior to the bid submission deadline (PKR or \$ equivalent based on the foreign exchange rate as of the same date).

b Remaining contract period to be calculated from 28 days prior to bid submission deadline.

Form FIN - 5: Self-Assessment Tool for Bidder's Compliance to Financial Resources (Criterion 2.1 of Section 3)

This form requires the same information submitted in Forms FIN - 3 and FIN - 4. All conditions of "Available Financial Resources Net of CCC ≥ Requirement for the Subject Contract" must be satisfied to qualify.

Form FIN - 5A: For Single Entities

For Single Entities: (A)	Total Available Financial Resources from FIN – 3 (B)	Total Monthly Financial Requirement for Current Contract Commitments (CCC) from FIN – 4 (C)	Available Financial Resources Net of CCC D = (B - C)	Requirement for the Subject Contract (E)	Results: Yes or No [D must be greater than or equal to E] (F)
(Name of Bidder)					

Form FIN - 5B: For Joint Ventures

For Joint Ventures: (A)	Total Available Financial Resources from FIN – 3 (B)	Total Monthly Financial Requirement for Current Contract Commitments (CCC) from FIN – 4 (C)	Available Financial Resources Net of CCC D = (B - C)	Requirement for the Subject Contract (E)	Results: Yes or No [D must be greater than or equal to E] (F)
One Partner:					
(Name of Partner)					
Each Partner:					
(Name of Partner 1)					
(Name of Partner 2)					
(Name of Partner 3)					
All partners combined	∑ D = Sum of available financial resources net of current contract commitments for all partners		ΣD =		

- Note -

Form FIN - 5 is made available for use by the bidder as a self-assessment tool, and by the Employer as an evaluation work sheet, to determine compliance with the financial resources requirement as stated in 2.1. Failure to submit Form FIN - 5 by the Bidder shall not lead to bid rejection.

4-16 Section 4: Bidding Forms

Technical Proposal

Joint Venture Agreement (in case of JV) in accordance with ITB 11.2

Personnel

Equipment

Site Organization

Method Statement

Mobilization Schedule

Construction Schedule

Environmental, Health and Safety Management Plan (EHSMP)

Environmental, Health and Safety Code of Conduct

Other Documents in accordance with ITB 11.1(h) of Section 2-Bid Data Sheet,

Personnel

Form PER - 1: Proposed Personnel

Bidder should provide the details of the proposed personnel and their experience record in the relevant Information Forms below for each candidate:

1.	Title of position
	Name
2.	Title of position
	Name
3.	Title of position
	Name
4.	Title of position
	Name
5.	Title of position
	Name
6.	Title of position
	Name
etc.	Title of position
	Name

-- Note --

All titles of positions will be as listed in Section 6 (Employer's Requirements).

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Form PER - 2: Resumé of Proposed Personnel

The Bidder shall provide all the information requested below. Use one form for each position.

Date of birth					
Place of Birth					
Citizenship					
ID number					
Name of employer					
Contact (manager / personnel officer)					
E-mail					
Years with present employer					

Summarize professional experience in reverse chronological order. Indicate particular technical and managerial experience relevant to the project.

From	То	Company/Project/Position/Relevant Technical and Management Experience

Equipment

Form EQU: Equipment

The Bidder shall provide adequate information and details to demonstrate clearly that it has the capability to meet the equipment requirements indicated in Section 6 (Employer's Requirements), using the Forms below. A separate Form shall be prepared for each item of equipment listed, or for alternative equipment proposed by the Bidder.

Equipment Information	Name of manufactu	rer		Model and power rating	
	Capacity			Year of manufacture	
Current Status	Current location				
	Details of current co				
Source	Indicate source of t	he equipment			
	☐ Owned	Rented	Leased	☐ Specially manufactured	
	ng information for	equipment ov	vned by the l	Ridder	
Owner			med by and i	Diduei.	
	Name of owner			Jiddel.	
	Name of owner Address of owner			Judei.	
				Contact name and title	
	Address of owner Telephone Fax			Contact name and title Telex	
Agreements	Address of owner Telephone Fax			Contact name and title	
Agreements	Address of owner Telephone Fax			Contact name and title Telex	

4-20 Section 4: Bidding Forms

Joint Venture Agreement in accordance with ITB 11.2:

The Joint Venture Agreement or a Letter of Intent to execute a Joint Venture Agreement in the event of the successful Bid, shall include the following:

- (a) All partners shall be jointly and severally liable;
- (b) The lead partner shall be clearly identified and nominated;
- (c) The financial share of each partner shall be clearly stated;
- (d) Corresponding to the financial share of each partner, the roles and responsibilities of each partner shall also be specified in conformance with requirement of Works stated in the Method Statement; and
- (e) Any other requirements as per the applicable law.

In case a letter of intent to execute the Joint Venture Agreement is submitted by the Bidder at the time of submission of the Bid, the Bidder shall be bound to submit a duly executed Joint Venture Agreement to the Employer immediately after the issuance of Letter of Acceptance but not later than 28 days after the issuance of the same. Such Joint Venture Agreement, thus submitted by the successful Bidder must contained the information postulated above. Failure to comply with this condition may lead to the rejection of Bid and forfeiture of Bid Security and/or Bid Securing Declaration, as the case may be.

Site Organization

[Note: Evaluation of the Bidder's Site Organization will include an assessment of the Bidder's capacity to mobilize key personnel for the Contract consistent with its proposal regarding work methods, scheduling, and material sourcing in sufficient detail and fully in accordance with the requirements stipulated in Section 6 (Employer's Requirements).]

Method Statement

The bidder **shall** provide detailed Method Statement of executing the project. The bidder shall also indicate the machinery to be used and key personnel showing their responsibilities.

In case of a JV, the Method Statement **shall** include clear delineation of activities / roles to be performed by each JV partner consistent with the indicated JV share in the JV Agreement.

Mobilization Schedule

The Mobilization Schedule should reflect the no-objection request and approval step for Site-Specific Environmental, Health and Safety Management Plan as per Contract Conditions.

Bidder shall provide mobilization Schedule conforming with the requirement of condition of contract Clause 14.2.

Construction Schedule

[Note: Evaluation of the Bidder's Construction Schedule will include an assessment of the Bidder's technical capacity to mobilize equipment for the Contract consistent with its proposal regarding work methods, scheduling, and material sourcing in sufficient detail and fully in accordance with the requirements stipulated in Section 6 (Work's Requirements).

Bidders must provide their Construction Schedule on primavera / MS project or equivalent by allocating the equipment and other resources, critical activities must be identified.]

Environmental, Health and Safety Management Plan (EHSMP)⁶

The Bidder shall submit an outline Environmental, Health and Safety Management Plan (EHSMP) commensurate with the risks and impacts of the proposed works and activities These strategies and plans shall describe in detail the actions, materials, equipment, management processes etc. that will be implemented by the Contractor, and its subcontractors.

In developing these strategies and plans, the Bidder shall have regard to the EHS provisions of the contract and EHS risks including those as may be more fully described in Section 6 (Employers' Requirements).

-

⁶ For projects categorized as Category C for environment for which no EMP has been prepared, this subsection should be omitted.

4-22 Section 4: Bidding Forms

Environmental, Health and Safety Code of Conduct

Environmental, Health and Safety Code of Conduct for Contractor's Personnel Form

Note to Bidder

The minimum content of the EHS Code of Conduct form as set out by the Employer shall not be substantially modified. However, the Bidder may add requirements as appropriate, including to take into account Contract-specific issues/risks.

The Bidder shall initial and submit the EHS Code of Conduct form as part of its bid.

ENVIRONMENTAL, HEALTH AND SAFETY CODE OF CONDUCT FOR CONTRACTOR'S PERSONNEL

We are the Contractor, [enter name of Contractor]. We have signed a contract with [enter name of Employer] for [enter description of the Works]. These Works will be carried out at [enter the Site and other locations where the Works will be carried out]. Our contract requires us to implement measures to address environmental, health and safety risks related to the Works.

This EHS Code of Conduct is part of our measures to deal with environmental, health and safety risks related to the Works. It applies to all our staff, labourers and other employees at the Works Site or other places where the Works are being carried out. It also applies to the personnel of each subcontractor and any other personnel assisting us in the execution of the Works. All such persons are referred to as "Contractor's Personnel" and are subject to this EHS Code of Conduct.

This EHS Code of Conduct identifies the behavior that we require from all Contractor's Personnel.

Our workplace is an environment where unsafe, offensive, abusive or violent behavior will not be tolerated and where all persons should feel comfortable raising issues or concerns without fear of retaliation.

REQUIRED CONDUCT

Contractor's Personnel shall:

- 1. carry out his/her duties competently and diligently;
- 2. comply with this EHS Code of Conduct and all applicable laws, regulations and other requirements, including requirements to protect the health, safety and well-being of other Contractor's Personnel and any other person;
- 3. maintain a safe working environment including by:
 - (a) ensuring that workplaces, machinery, equipment and processes under each person's control are safe and without risk to health:
 - (b) wearing required personal protective equipment;
 - (c) using appropriate measures relating to chemical, physical and biological substances and agents; and
 - (d) following applicable emergency operating procedures.
- report work situations that he/she believes are not safe or healthy and remove himself/herself from a work situation which he/she reasonably believes presents an imminent and serious danger to his/her life or health;
- 5. treat other people with respect, and not discriminate against specific groups such as women, people with disabilities, migrant workers or children;

- 6. report violations of this EHS Code of Conduct; and
- not retaliate against any person who reports violations of this EHS Code of Conduct, whether to us or the Employer, or who makes use of the grievance mechanism for Contractor's Personnel or the project's Grievance Redress Mechanism.

RAISING CONCERNS

If any person observes behavior that he/she believes may represent a violation of this EHS Code of Conduct, or that otherwise concerns him/her, he/she should raise the issue promptly. This can be done by call [] to reach the Contractor's hotline (*if any*) and leave a message.

The person's identity will be kept confidential, unless reporting of allegations is mandated by the country law. Anonymous complaints or allegations may also be submitted and will be given all due and appropriate consideration. We take seriously all reports of possible misconduct and will investigate and take appropriate action. We will provide warm referrals to service providers that may help support the person who experienced the alleged incident, as appropriate.

CONSEQUENCES OF VIOLATING THE ENVIRONMENTAL, HEALTH AND SAFETY CODE OF CONDUCT

Any violation of this EHS Code of Conduct by Contractor's Personnel may result in serious consequences, up to and including termination and possible referral to legal authorities.

FOR CONTRACTOR'S PERSONNEL:

I have received a copy of this EHS Code of Conduct written in a language that I comprehend. I understand that if I have any questions about this EHS Code of Conduct, I can contact [enter name of Contractor's contact person(s) with relevant experience)] requesting an explanation.

Name of Contractor's Personnel: [insert name]
Signature:
Date: (day month year):
Countersignature of authorized representative of the Contractor:
Signature:
Date: (day month year):

4-24 Section 4: Bidding Forms

Updating of Bidder's Qualification

The Bidder shall update the information given during the corresponding prequalification exercise to demonstrate that he continues to meet the criteria used at the time of prequalification regarding

- (a) Eligibility
- (b) Historical Contract Nonperformance
- (c) Financial Situation
 - (i) Historical Financial Performance
 - (ii) Average Annual Construction Turnover

For this purpose, the Bidder shall use the relevant forms included in this Section.

Form ELI - 1: Bidder's Information Sheet

		Bidder's Information	
		Information of the Bidder	If the Bidder is a subsidiary or branch, information of any parent company/companies
	Full legal name(s)		
Names	Full trading name(s) (if any)		
	Registered address(es)		
Addresses	Trading address(es)		
	Postal address(es) (if different from trading address)		
Type of organ	ization		
Country of constitution/ir ion	ncorporation/registrat		
Year of consti registration	tution/incorporation/		
Corporate or registration number			
In case of a Joname of each	oint Venture, legal partner		
	prized representative dephone number(s), fax address)		

Attached are copies of the following documents:

- 1) In case of a single entity, articles of incorporation or constitution and company incorporation/registration of the legal entity named above, in accordance with ITB 4.1 and ITB 4.2.
- 2) Authorization to represent the firm or Joint Venture named above, in accordance with ITB 20.2.
- 3) In case of a Joint Venture, a letter of intent to form a Joint Venture or Joint Venture agreement, in accordance with ITB 4.1.
- 4) In case of a government-owned enterprise, any additional documents not covered under 1 above required to comply with ITB 4.5.

4-26 Section 4: Bidding Forms

Form ELI - 2: Joint Venture Information Sheet

Each partner of the Joint Venture and Specialist Subcontractor must fill out this form separately.

Joint Venture / Specialist Subcontractor Information			
Bidder's legal name			
		Information of Joint Venture Partner or Specialist Subcontractor	If any Joint Venture Partner or Specialist Subcontractor is a subsidiary or branch, information of any parent company/companies
Names	Full Legal name(s)		
Names	Full trading name(s) (if any)		
	Registered address(es)		
Addresses	Trading address (es)		
	Postal address (es) (if different from trading address)		
Type of organization			
Country of constitution/incorporation/ registration			
Year of constitution/incorporation/ registration			
Corporate or registration number			
Joint Venture Partner's or Specialist Subcontractor's authorized representative information			
(name, address, telephone number(s), fax number(s), e-mail address)			

Attached are copies of the following documents:

- 1) Articles of incorporation or constitution and company incorporation/registration of the legal entity named above, in accordance with ITB 4.1 and ITB 4.2.
- 2) Authorization to represent the firm named above, in accordance with ITB 20.2.
- 3) In the case of a government-owned enterprise, documents establishing legal and financial autonomy and compliance with commercial law, in accordance with ITB 4.5.

Form CON - 1: Historical Contract Nonperformance

Each Bidder must fill out this form in accordance with Criterion 2.2(b) of Section 3 (Evaluation and Qualification Criteria) to describe any history of nonperforming contracts and pending litigation or arbitration formally commenced against it.

In case of a Joint Venture, each Joint Venture Partner must fill out this form separately and provide the Joint Venture Partner's name:

Joint Venture Partner: **Table 1: History of Nonperforming Contracts** Choose one of the following: No nonperforming contracts. Below is a description of nonperforming contracts involving the Bidder (or each Joint Venture partner if Bidder is a Joint Venture) Amount of Nonperformed Total Year Description Portion of Contract Contract (\$ Amount (\$ equivalent) equivalent) [insert amount] [insert **[insert** Contract Identification: [indicate complete contract name/number, and any amount] year] other identification] Name of Employer: [insert full name] Address of Employer: [insert street/city/country] Reason(s) for nonperformance: [indicate main reason(s)] **Table 2: Pending Litigation and Arbitration** Choose one of the following: No pending litigation, arbitration or any other material events impacting the net worth and/or liquidity of the bidder. Below is a description of all pending litigation, arbitration involving the Bidder or any other material events impacting the net worth and/or liquidity of the bidder (or each Joint Venture partner if Bidder is a Joint Venture). Value of Value of Pending **Matter in Dispute Pending Claim** Claim as a Year in \$ Equivalent Percentage of Net Worth [insert Contract Identification, as applicable: findicate complete contract [insert amount] [insert amount] year] name/number, and any other identification] Name of Employer, parties involved in the material events impacting the net worth and/or liquidity of the bidder: [insert full Address of Employer, parties involved in the material events impacting the net worth and/or liquidity of the bidder: [insert street/city/country] Matter of Dispute: [indicate full description of dispute] Party who initiated the dispute: [indicate "Employer" or "Contractor"] Status: [indicate status of dispute]

- Note -

Table 2 of this form shall only be included if Criterion 2.2(b) of Section 3 (Evaluation and Qualification Criteria) is applicable.

4-28 Section 4: Bidding Forms

Form CON - 2: EHS Performance Declaration

Each Bidder must fill out this form in accordance with Criterion 2.2.4 of Section 3 (Evaluation and Qualification Criteria).

In case of a Joint Venture, each Joint Venture Partner must fill out this form separately and provide the Joint Venture Partner's name:

Joint Venture Partner:

In case of a Specialist Subcontractors, each Specialist Subcontractor must fill out this form and provide the Specialist Subcontractor's name:

Specialist Subcontractor:

Environmental and Health and Safety Performance Declaration	n
accordance with Section 3 (Evaluation and Qualification Criter	ria

- □ **No suspension or termination of contract**: An employer has not suspended or terminated a contract and/or called the performance security for a contract for reasons related to Environmental or Health and Safety performance since the date specified in Section 3 (Evaluation and Qualification Criteria), Criterion 2.5.
- □ Declaration of suspension or termination of contract: The following contract(s) has/have been suspended or terminated and/or Performance Security called by an employer(s) for reasons related to Environmental or Health and Safety performance since the date specified in Section 3 (Evaluation and Qualification Criteria), Criterion 2.5. Details are described below:
- □ Declaration of request for replacement of Key Environment, Health and Safety Personnel: The following contract(s) has/have experienced a request by the Employer to replace Environmental, Health and Safety Personnel for reasons related to Environmental or Health and Safety performance since the date specified in Section 3 (Evaluation and Qualification Criteria), Criterion 2.5. Details are described below:
- □ Declaration of past fatality resulted from EHS issues on site: The following contract(s) has/have experienced a fatality resulted from EHS issues on site since the date specified in Section 3 (Evaluation and Qualification Criteria), Criterion 2.5. Details are described below:

Year	Suspended or terminated portion of contract	Contract Identification	Total Contract Amount (current value, currency, exchange rate and US\$ equivalent)
[insert year]	-	Contract Identification: [indicate complete contract name/ number, and any other identification]	[insert amount]
		Name of Employer: [insert full name]	
		Address of Employer: [insert street/city/country]	
		Reason(s) for suspension or termination: [indicate main reason(s) e.g. discharge over environmental limit, workers did not have required health and safety permits to undertake high risk work, work carried out was not adhered to approved construction methodology and quality control plan]	
[insert year]	-	Contract Identification: [indicate complete contract name/ number, and any other identification]	[insert amount]
		Name of Employer: [insert full name]	

		Address of Employer: [insert street/city/country]	
Reason(s) for suspension or termination: [indicate main reason(s)]			
		[list all applicable contracts]	
Performan	ce Security call	ed by an employer(s) for reasons related to EHS performa	ance
Year	Contract Iden	tification	Total Contract Amour (current value, currency exchange rate and US equivalent)
[insert year]	Contract Idention other identificat	fication: [indicate complete contract name/ number, and any tion]	[insert amount]
	Name of Emplo	oyer: [insert full name]	
	Address of Em	ployer: [insert street/city/country]	
	Reason(s) for suspension or termination: [indicate main reason(s) e.g. discharge over environmental limit, workers did not have required health and safety permits to undertake high risk work, work carried out was not adhered to approved construction methodology and quality control plan]		
Key EHS p	ersonnel replac	cement requested by the Employer for reasons related to	 EHS performance
Year	Contract Iden	tification and Reasons	Personnel replacement action and results
[insert year]	Contract Idention	fication: [indicate complete contract name/ number, and any tion]	[insert description]
	Name of Emplo	oyer: [insert full name]	
	Address of Em	ployer: [insert street/city/country]	
	Reason(s) for r		
	. =:	0"	
	to EHS issues o		
Year	Contract Iden	tification	Follow-on actions taken by the contractor
[insert year]	Contract Identification: [indicate complete contract name/ number, and any other identification]		[insert description]
	Name of Emplo	oyer: [insert full name]	
	Address of Em	ployer: [insert street/city/country]	
	Description of t	fatality event:	
	Causation:		
	l .		

4-30 Section 4: Bidding Forms

Form FIN - 1: Historical Financial Performance

Ead	ch B	idder must fill out t	his form.			
		of a Joint Venture enture Partner's na	e, each Joint Venture Part ame:	ner must fill out t	his form sep	earately and provide the
Joii	nt Ve	enture Partner:				
			Financial Data fo	r Previous	_ Years [Ph	(R or \$ Equivalent]
			Year 1:	Year 2:		Year:
			Information fro	om Balance She	et	
Tot	al A	ssets (TA)				
Tot	al L	iabilities (TL)				
Net	Wo	orth = TA – TL				
Cui	ren	t Assets (CA)				
Cui	ren	t Liabilities (CL)				
Wo CL	rkin	g Capital = CA -				
		ecent g Capital			of Joint Venture	ear and carried forward to FIN - es, to the corresponding Joint
			Information from	n Income Statem	nent	
Tot	al R	evenues				
Pro	fits	Before Taxes				
Pro	fits	After Taxes				
	Atta	•	ancial statements (balance she above, complying with the follow	•	ted notes and	income statements) for the last
	1)					reflect the standalone financial ent companies, subsidiaries, or
	2)	Historical financial sta	atements must be audited by a d	certified accountant.		
	3)	Historical financial sta	atements must be complete, incl	luding all notes to the	financial state	ments.
	4)		atements must correspond to ac e requested or accepted).	counting periods alre	eady completed	and audited (no statements for

Form FIN - 2: Average Annual Construction Turnover

Each Bidder must fill out this form.

The information supplied should be the Annual Turnover of the Bidder or each partner of a Joint Venture for the total certified payments received from the clients for contracts in progress or completed, converted to US dollars at the rate of exchange at the end of the period reported.

In case of a Joint Venture, each Joint Venture Partner must fill out this form separately and provide the Joint Venture Partner's name:

Joint Venture Partner:	

Annual Turnover Data for the Last Years (Construction only)				
Year	Amount Currency	Exchange Rate	PKR or \$ Equivalent	
	Average Annual			

Section 5: Eligible Countries

This section contains the list of eligible countries.

1.	Afghanistan	35.	Micronesia, Federated States of
2.	Armenia	36.	Mongolia
3.	Australia	37.	Myanmar
4.	Austria	38.	Nauru
5.	Azerbaijan	39.	Nepal
6.	Bangladesh	40.	The Netherlands
7.	Belgium	41.	New Zealand
8.	Bhutan	42.	Norway
9.	Brunei Darussalam	43.	Pakistan
10.	Cambodia	44.	Palau
11.	Canada	45.	Papua New Guinea
12.	China, People's Republic of	46.	Philippines
13.	Cook Islands	47.	Portugal
14.	Denmark	48.	Samoa
15.	Fiji	49.	Singapore
16.	Finland	50.	Solomon Islands
17.	France	51.	Spain
18.	Georgia	52.	Sri Lanka
19.	Germany	53.	Sweden
20.	Hong Kong, China	54.	Switzerland
21.	India	55.	Tajikistan
22.	Indonesia	56.	Taipei, China
23.	Ireland	57.	Thailand
24.	Italy	58.	Timor-Leste
25.	Japan	59.	Tonga
26.	Kazakhstan	60.	Turkey
27.	Kiribati	61.	Turkmenistan
28.	Korea, Republic of	62.	Tuvalu
29.	Kyrgyz Republic	63.	United Kingdom
30.	Lao People's Democratic Republic	64.	United States
31.	Luxembourg	65.	Uzbekistan
32.	Malaysia	66.	Vanuatu
33.	Maldives	67.	Viet Nam
34.	Marshall Islands	68.	Niue

Section 6: Employer's Requirements

This Section contains the Specifications, Drawings, Supplementary Information that describe the Works to be procured, Personnel Requirements, and Equipment Requirements.

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Bill of Quantities	

Specifications

(a) Specifications

2nd Biannual Market Rate System (MRS) 2022, Finance Department, Government of the Khyber Pakhtunkhwa, District DI Khan

Part A: Specifications

2nd Biannual Market Rate

2nd Biannual Market Rate
Department,
Finance Department,
Pakhtunkhwa,
System (MRS) 2022, Finance Pakhtunkhwa,
Finance Department,
Finance Department,
Finance Department,
Finance Department,
Finance Department,
Pakhtunkhwa,
System (MRS) 2022, Finance Department,
Finance Department

Environmental, Health and Safety Management Requirement

EMP Attached

Drawings Volume- II

Attached

Supplementary Information Regarding Works to Be Procured

Asian Development Bank (ADB) in collaboration with the Federal and Provincial Governments is funding the Rehabilitation and construction program of Emergency Flood Assistance Project.

The Khyber Pakhtunkhwa Irrigation output is strengthened, of Repair, Rehabilitation and Reconstruction of Irrigation Structure, Drainage System and Flood Protection Works Spreads in Province of Khyber Pakhtunkhwa

The package interventions lie in the District DI Khan of Khyber Pakhtunkhwa Province.

Standard Operation Procedures (SOPs) issued by Government of Pakistan from time to time, local regulations and guidance specific to COVID-19 prevention and controls, and worksite safety measures requirements that are deemed applicable to the contract, as well as the applicable international good practices on Health and Safety for the contract.

Site Specific Health and Safety Management Plan (SSHSMP)

Standard Operating Procedures (SOPs): All Standard Operating Procedures (SOPs) issued by the Government of Pakistan from time to time on COVID-19 prevention and controls, as well as workplace safety requirements, with international good practice guidelines [World Health Organization, Considerations for public health and social measures in the workplace in the context of COVID-19. Geneva. Available here: https://www.who.int/publications-detail/considerations-for-public-health-and-social-measures-in-the-workplace-in-the-context-of-covid-19] and SOPs (http://covid.gov.pk/) will be applicable.

Personnel Requirements

Using Form PER - 1 and PER - 2 in Section 4 (Bidding Forms), the Bidder must demonstrate that it has personnel who meet the following requirements:

No.	Position	Minimum Qualification	Total Work Experience (years)	Experience in Similar Work (years)
1	Project Manager	BE (Civil Engineering) or equivalent Professional qualification.	15	10
2	Deputy Project Engineer/Planning Engineer	BE (Civil Engineering) or equivalent Professional qualification	10	05
3	Site Engineers (05 Numbers)	BE (Civil Engineering) or equivalent Professional qualification.	06	04
4	Qualified / Experienced Surveyor	Diploma with surveying qualification or equivalent Professional qualification	07	05
5	Qualified Environment Specialist	M.Sc. (Environment.) or equivalent Professional qualification	07	05

Note- All Engineers whether foreign or local must be registered with Pakistan Engineering Council (PEC). Copy of Registration Certificate shall be required to be submitted to employer prior to starting any activity at site.

Using Form EXP-6 (PER-2) in Section 4 (Bidding Forms), the Bidder must demonstrate that it has EHS personnel who meet the following requirements:

Key Personnel as determined by the EMP and other safeguard management plans

Item No.	Position/ Specialization	Relevant academic qualifications	Minimum years of relevant work experience	Minimum time on-site (%FTE)
1	Qualified Health and Safety Expert	M.Sc. (Public Health Engineering) or equivalent Professional qualification	05	
2	Gender Specialist	Master's degree in relevant field	05	

Equipment Requirements

Using Form EQU in Section 4 (Bidding Forms), the Bidder must demonstrate that it has the key equipment listed below:

No.	Equipment Type and Characteristics	Minimum Number Required
1	Excavators	04
2	Bulldozers	02
3	Rollers/ Vibratory Rollers (all combination)	03
4	Loaders/ Shovel	01
5	Dump Trucks	08
6	Concrete Batching Plant	02
7	Concrete Pumps	04
8	Transit Mixers (All types)	06
9	Water Bowsers	02
10	Complete Set of Shuttering & scaffolding (Steel) 100 Sq.m	01
11	Air Compressors	06

Note: The bidder shall furnish on judicial stamp paper an undertaking after the signing of the contract stating that it shall bring the equipment mentioned here-in-above or more to successfully execute and complete the project within the completion period.

Bill of Quantities (BOQ)

Attached with the Bidding Document.

BILL OF QUANTITIES (BOQS) PACKAGE-3: EFAP/KPID/CW-03: REHABILITATION OF CANALS AND DRAINS, DISTRICT DI KHAN PAHARPUR IRRIGATION DIVISION

LOAN 4279-PAK(COL): EMERGENCY FLOOD ASSISTANCE PROJECT (KHYBER PAKHTUNKHWA IRRIGATION DEPARTMENT COMPONENT)

$\textbf{EFAP-KPID-} \ \textbf{CW-03:} \ \textbf{Rehabilitation} \ \textbf{of Canals and Drains, Paharpur Irrigation Division}$

SUMMARY OF BILLS

Bill.	Description	Amount (PKR)
No	<u> </u>	in Figures
A	WORKS - DRAINS	
1	Earthwork	
2	Vertical Brick Protection Works	
3	Rehabilitation Of Hydraulic Structures	
4	Reconstruction of Culverts	
5	Provision Of Stone Pitching	
	SUB-TOTAL (A)	
В	WORKS - CANALS	
6	Earthwork	
7	PCC Lining	
8	Concrete Side Protection	
9	Vertical Brick Protection Works	
10	Rehabilitation Of Road	
11	Monitoring Facilities	
12	Rehabilitation Of Hydraulic Structures	
13	Provision Of Stone Pitching	
	SUB-TOTAL (B)	
С	PROVISIONAL SUM	
1	ENVIRONMENTAL AND SOCIAL COST (Million)	2,330,000
	SUB-TOTAL (C)	
	TOTAL AMOUNT RS. (A+B+C)	
	IN MILLION	

LOAN 4279-PAK(COL): EMERGENCY FLOOD ASSISTANCE PROJECT (KHYBER PAKHTUNKHWA IRRIGATION DEPARTMENT COMPONENT) EFAP-KPID- CW-03: Rehabilitation of Canals and Drains, Paharpur Irrigation Division

Bill No.1: Earthwork

Item No.	Item# as per MRS	Description	Unit	Quantity	Unit Rate (PKR) in Figures	Unit Rate (PKR) in Words	Amount (PKR) in Figures		
1	03 54	Uprooting sarkanda growth and disposal within 50m	1000 Sft	15,499.84					
2a	03-72-b	Earthwork by mechanical means in drains and irrigation channels in DRY & WET soil dressed to designed section, grades profile/with excavated material, disposed off within 50 feet (15.2 m) lead and dressed as directed	1000 Cft	8,756.94					
2b	03-72-d	Earthwork by mechanical means in drains and irrigation channels in SLUSH soil dressed to designed section, grades profile/with excavated material, disposed off within 50 feet (15.2 m) lead and dressed as directed	1000 Cft	21,107.63					
2c	03-72-с	Earthwork by mechanical means in drains and irrigation channels in WET & SLUSH soil dressed to designed section, grades profile/with excavated material, disposed off within 50 feet (15.2 m) lead and dressed as directed	1000 Cft	5,632.01					
2d	03-72-g	Earthwork by mechanical means in drains and irrigation channels in UNDER WATER soil dressed to designed section, grades profile/with excavated material, disposed off within 50 feet (15.2 m) lead and dressed as directed	1000 Cft	20,823.54					
3	03-06-b	Embankment formation in ordinary soil & compaction by mechanical means at optimum moistures content to 90% max. modified AASHTO dry density (borrow area).	1000 Cft	167.62					
4	03-04-a	Bed clearance and dressing slopes of drains including removing of weeds and roots etc. Excavated material undressed within 15m	1000 Cft	684.86					
	Total								

LOAN 4279-PAK(COL): EMERGENCY FLOOD ASSISTANCE PROJECT (KHYBER PAKHTUNKHWA IRRIGATION DEPARTMENT COMPONENT)

EFAP-KPID- CW-03: Rehabilitation of Canals and Drains, Paharpur Irrigation Division

Bill No.2: Vertical Brick Protection Works

Item No.	Item# as per MRS	Description	Unit	Quantity	Unit Rate (PKR) in Figures	Unit Rate (PKR) in Words	Amount (PKR) in Figures
1		Earth excavation in irrigation channels/drains & disposal upto 25m. & dressing : in Ordinary Soil	1000 Cft	11.21			
2	06-48-j	Lean concrete for use as thin layer under neath footings with cylinder compressive strength of 1423 psi on 28 days	100 Cft	32.25			
3	07-04-a-02	1st class brick work in foundation and plinth in Cement, sand mortar 1:3	100 Cft	225.56			
4	11-08-b	Cement plaster 1:3, upto 20' height 1/2" thick	100 Sft	96.13			
5	06-05-f	Plain Cement Concrete including placing, compacting, finishing & curing (Ratio 1:2:4)	100 Cft	3.52			
6	03-67-с	Structural backfill using Common Material available at site.	1000 Cft	8.97			
			Total				

LOAN 4279-PAK(COL): EMERGENCY FLOOD ASSISTANCE PROJECT (KHYBER PAKHTUNKHWA IRRIGATION DEPARTMENT COMPONENT) EFAP-KPID- CW-03: Rehabilitation of Canals and Drains, Paharpur Irrigation Division

Bill No.3: Rehabilitation of Hydraulic Structures

Item No.	Item# as per MRS	Description	Unit	Quantity	Unit Rate (PKR) in Figures	Unit Rate (PKR) in Words	Amount (PKR) in Figures
3(b)	06-07-b- 03	RCC in raft foundation slab, base slab of column & ret. wall etc	100 Cft	0.83			
4	06-08-b	Supply & fabricate M.S. reinforcement for cement concrete (Hot rolled deformed bars Grade 60)	100 kg	3.71			
5 Supply & dump at site, without boat, including handling within 100m : Stone		100 Cft	0.00				
11	03-12-a	Earth excavation in irrigation channels/drains & disposal upto 25m. & dressing : in Ordinary Soil	1000 Cft	0.32			
13	07-04-a- 02	1st class brick work in foundation and plinth in Cement, sand mortar 1:3	100 Cft	2.67			
14	11-08-b	Cement plaster 1:3, upto 20' height 1/2" thick	100 Sft	14.82			
15	06-05-f	Plain Cement Concrete including placing, compacting, finishing & curing (Ratio 1:2:4)	100 Cft	0.22			
16	03-67-с	Structural backfill using Common Material available at site.	1000 Cft	0.22			
		Total					

LOAN 4279-PAK(COL): EMERGENCY FLOOD ASSISTANCE PROJECT (KHYBER PAKHTUNKHWA IRRIGATION DEPARTMENT COMPONENT) EFAP-KPID- CW-03: Rehabilitation of Canals and Drains, Paharpur Irrigation Division

Bill No.4: Reconstruction of Culverts

Item No.	Item# as per MRS	Description	Unit	Quantity	Unit Rate (PKR) in Figures	Unit Rate (PKR) in Words	Amount (PKR) in Figures
1	03-25-b	Excavation in foundation of building, bridges etc complete : in ordinary soil	1000 Cft	6.15			
2	06-05-i	Plain Cement Concrete including placing, compacting, finishing & curing (Ratio 1:4:8)	100 Cft	1.98			
3(a)	06-07-a- 03	RCC in roof slab, beam, column & other structural members, insitu or precast. (1:2:4)	100 Cft	17.06			
3(b)	06-07-b- 03	RCC in raft foundation slab, base slab of column & ret. wall etc	100 Cft	8.26			
4	06-08-b	Supply & fabricate M.S. reinforcement for cement concrete (Hot rolled deformed bars Grade 60)	100 kg	113.90			
5	19-15-a	Supply & dump at site, without boat, including handling within 100m : Stone	100 Cft	74.25			
6	16-65	Providing and Laying PVC pipe (b) 4" dia in foot path of bridge for utilities.	10 Rft	0.67			
7	16-09-a	Bitumenous Prime Coat	100 sft	3.06			
8	16-14-b	Asphaltic Wearing Course (Asphalt Batch Plant Hot Mixed) i/c Transportation and Finishing complete	100 Cft	9.17			
9	13-08-b	Bitumen coating to plastered / cement concrete surface : 14 Ibs. per 100 sft.	100 sft	8.15			
10	03-29-a	Compaction of earth with power road roller 95% to 100% max. mod. AASHTO dry density	1000 Cft	6.15			
	Total						

LOAN 4279-PAK(COL): EMERGENCY FLOOD ASSISTANCE PROJECT (KHYBER PAKHTUNKHWA IRRIGATION DEPARTMENT COMPONENT) EFAP-KPID- CW-03: Rehabilitation of Drains, Paharpur Irrigation Division

Bill No. 5: Provision of Stone Pitching

Item No.	Item# as per MRS	Description	Unit	Quantity	Unit Rate (PKR) in Figures	Unit Rate (PKR) in Words	Amount (PKR) in Figures		
1	03-12-a	Earth excavation in irrigation channels/drains & disposal upto 25m. & dressing : in Ordinary Soil	1000 Cft	311.05					
2	19-25	Providing and Laying stone pithcing/filling, dry hand packed in pitching & aprons	100 Cft	2,585.16					
3	19-28-a	Providing and laying stone pitching, for top layer only:- on slope	100 Cft	5,195.00					
4	19-28-b	Providing and laying stone pitching, for top layer only:- on level	100 Cft	985.50					
5	19-29-a	Providing and Laying stone or spawl filling : On slope	100 Cft	3,391.78					
6	19-29-b	Providing and Laying stone or spawl filling : On level	100 Cft	657.00					
7	06-48-j	Lean concrete for use as thin layer under neath footings with cylinder compressive strength of 1423 psi on 28 days	100 Cft	61.20					
8	06-44-b	PCC 1:3:6 in mass concrete less formwork using 40% boulders	100 Cft	786.56					
9	06-05-f	Plain Cement Concrete including placing, compacting, finishing & curing (Ratio 1:2:4)	100 Cft	638.49					
10	03-67-с	Structural backfill using Common Material available at site.	1000 Cft	3.92					
	Total								

Emergency Flood Assistance Project (EFAP)-KP

EFAP-KPID- CW-03: Rehabilitation of Canals and Drains, Paharpur Irrigation Division

Bill No. 6: Earthwork

Item No.	Item# as per MRS	Description	Unit	Quantity	Unit Rate (PKR) in Figures	Unit Rate (PKR) in Words	Amount (PKR) in Figures
1	1131160	Embankment formation in ordinary soil & compaction by mechanical means at optimum moistures content to 95% to 100% max. modified. AASHTO dry density (borrow area).	1000 Cft	165.53			
2	03-12-a	Earth excavation in irrigation channels/drains & disposal upto 25m. & dressing : in Ordinary Soil	1000 Cft	37.59			
	Total						

Emergency Flood Assistance Project (EFAP)-KP

EFAP-KPID- CW-03: Rehabilitation of Canals and Drains, Paharpur Irrigation Division

Bill No. 7: PCC Lining

Bill No. 7: PCC Lining								
Ite m No.	Item# as per MRS	Description	Unit	Quantity	Unit Rate (PKR) in Figures	Unit Rate (PKR) in Words	Amount (PKR) in Figures	
1	03-12-a	Earth excavation in irrigation channels/drains & disposal upto 25m. & dressing : in Ordinary Soil	1000 Cft	179.00				
2	03-06-a	Embankment formation in ordinary soil & compaction by mechanical means at optimum moistures content to 95% to 100% max. modified. AASHTO dry density (borrow area).	1000 Cft	563.51				
3	17-01-a	Formation, dressing and preparing sub-grade in Bed	100 Sft	1,433.71				
4	17-01-b	Formation, dressing and preparing sub-grade on slope	100 Sft	2,120.52				
5	17-04-a	1" thick plaster of cement, sand mortar 1:6 in Bed	100 Sft	1,447.63				
6	17-04-b	1" thick plaster of cement, sand mortar 1:6 on slope	100 Sft	2,147.72				
7	17-10-a-01	4" thick PCC lining, using washed screened & graded/curshed stone aggregate : in bed : Ratio 1:2:4	100 Cft	537.34				
8	17-10-b-01	4" thick PCC lining, using washed screened & graded/curshed stone aggregate : On slope : Ratio 1:2:4	100 Cft	715.19				
9	06-05-f	Plain Cement Concrete including placing, compacting, finishing & curing (Ratio 1:2:4)	100 Cft	61.47				
10	13-08-b	Bitumen coating to plastered / cement concrete surface: 14 lbs. per 100 sft.	100 Sft	201.24				
11	06-23	Fill expansion joints with bitumen, sand & saw dust in Ratio 1:2:2	Rft	38,041.75				
12	06-48-j	Lean concrete for use as thin layer under neath footings with cylinder compressive strength of 1423 psi on 28 days	100 Cft	1.58				
13	06-44-b	PCC 1:3:6 in mass concrete less formwork using 40% boulders	100 Cft	18.43				
	Total							

Emergency Flood Assistance Project (EFAP)-KP EFAP-KPID- CW-03: Rehabilitation of Canals and Drains, Paharpur Irrigation Division

Bill No. 8: Concrete Side Protection

Item No.	Item# as per MRS	Description	Unit	Quantity	Unit Rate (PKR) in Figures	Unit Rate (PKR) in Words	Amount (PKR) in Figures
1	03-12-a	Earth excavation in irrigation channels/drains & disposal upto 25m. & dressing : in Ordinary Soil	1000 Cft	142.10			
2	03-06-a	Embankment formation in ordinary soil & compaction by mechanical means at optimum moistures content to 95% to 100% max. modified. AASHTO dry density (borrow area).	1000 Cft	728.19			
3	17-01-a	Formation, dressing and preparing subgrade in Bed	100 Sft	437.68			
4	17-01-b	Formation, dressing and preparing subgrade on slope	100 Sft	1,315.33			
5	17-04-a	1" thick plaster of cement, sand mortar 1:6 in Bed	100 Sft	446.63			
6	17-04-b	1" thick plaster of cement, sand mortar 1:6 on slope	100 Sft	1,201.38			
7	17-10-a-01	4" thick PCC lining, using washed screened & graded/curshed stone aggregate: in bed: Ratio 1:2:4	100 Cft	118.98			
8	17-10-b-01	4" thick PCC lining, using washed screened & graded/curshed stone aggregate: On slope: Ratio 1:2:4	100 Cft	357.71			
9	06-48-j	Lean concrete for use as thin layer under neath footings with cylinder compressive strength of 1423 psi on 28 days	100 Cft	103.07			

Emergency Flood Assistance Project (EFAP)-KP

EFAP-KPID- CW-03: Rehabilitation of Canals and Drains, Paharpur Irrigation Division

Bill No. 8: Concrete Side Protection

Item No.	Item# as per MRS	Description	Unit	Quantity	Unit Rate (PKR) in Figures	Unit Rate (PKR) in Words	Amount (PKR) in Figures
10	07-07-a-02	1st class brick work other than building upto 10 ft. height : Cement, sand mortar 1:3	100 Cft	596.87			
11	11-08-b	Cement plaster 1:3, upto 20' height 1/2" thick	100 Sft	417.20			
12	06-05-f	Plain Cement Concrete including placing, compacting, finishing & curing (Ratio 1:2:4)	100 Cft	387.26			
13	13-08-b	Bitumen coating to plastered / cement concrete surface : 14 Ibs. per 100 sft.	100 Sft	243.90			
14	06-23	Fill expansion joints with bitumen, sand & saw dust in Ratio 1:2:2	Rft	12,498.61			
15	06-44-b	PCC 1:3:6 in mass concrete less formwork using 40% boulders	100 Cft	65.67			
			Total				

Emergency Flood Assistance Project (EFAP)-KP EFAP-KPID- CW-03: Rehabilitation of Canals and Drains, Paharpur Irrigation Division

Bill No. 9: Vertical Brick Protection Works

bill no. 9: Vertical brick Protection works							
Item No.	Item# as per MRS	Description	Unit	Quantity	Unit Rate (PKR) in Figures	Unit Rate (PKR) in Words	Amount (PKR) in Figures
1	113-17-9	Earth excavation in irrigation channels/drains & disposal upto 25m. & dressing : in Ordinary Soil	1000 Cft	89.18			
2	03-06-a	Embankment formation in ordinary soil & compaction by mechanical means at optimum moistures content to 95% to 100% max. modified. AASHTO dry density (borrow area).	1000 Cft	184.98			
3	ŭ	Lean concrete for use as thin layer under neath footings with cylinder compressive strength of 1423 psi on 28 days	100 Cft	76.64			
4	07-07-a-02	1st class brick work other than building upto 10 ft. height: Cement, sand mortar 1:3	100 Cft	496.29			
5	11-08-b	Cement plaster 1:3, upto 20' height 1/2" thick	100 Sft	217.91			
6	110-115-1	Plain Cement Concrete including placing, compacting, finishing & curing (Ratio 1:2:4)	100 Cft	9.34			
7	U3-67-C	Structural backfill using Common Material available at site.	1000 Cft	28.97			
	Total						

Emergency Flood Assistance Project (EFAP)-KP

EFAP-KPID- CW-03: Rehabilitation of Canals and Drains, Paharpur Irrigation Division

Bill No. 10: Rehabilitation of Road

Item No.	Item# as per MRS	Description	Unit	Quantity	Unit Rate (PKR) in Figures	Unit Rate (PKR) in Words	Amount (PKR) in Figures
1	03-12-a	Earth excavation in irrigation channels/drains & disposal upto 25m. & dressing: in Ordinary Soil	1000 Cft	1,100.311			
2	03-06-b	Embankment formation in ordinary soil & compaction by mechanical means at optimum moistures content to 90% max. modified AASHTO dry density (borrow area).	1000 Cft	81.325			
3	03-71-c-i	Subgrade Preparation on Existing Road ; Mod. AASHTO 95%	1000 Sft	444.231			
4	16-04-b	Granular Sub Base Using Crushed Stone Aggregate	100 Cft	1,999.768			
5	16-05-a	Aggregate Base Course	100 Cft	1,651.200			
6	16-09-a	Bitumenous Prime Coat	100 Sft	2,468.400			
7	16-14-b	Asphaltic Wearing Course (Asphalt Batch Plant Hot Mixed) i/c Transportation and Finishing complete	100 Cft	411.400			
	Total						

Emergency Flood Assistance Project (EFAP)-KP

EFAP-KPID- CW-03: Rehabilitation of Canals and Drains, Paharpur Irrigation Division

Bill No. 11 : Monitoring Facilities

Item No.	Item# as per MRS	Description	Unit	Quantity	Unit Rate (PKR) in Figures	Unit Rate (PKR) in Words	Amount (PKR) in Figures
1		Embankment formation in ordinary soil & compaction by mechanical means at optimum moistures content to 95% to 100% max. modified. AASHTO dry density (borrow area).	1000 Cft	435.16			
2		Providing and Laying shingle on top of bund, including handling of materials within 100 m.	100 Cft	1,539.00			
	Total						

Emergency Flood Assistance Project (EFAP)-KP EFAP-KPID- CW-03: Rehabilitation of Canals and Drains, Paharpur Irrigation Division

Bill No.12: Rehabilitation of Hydraulic Structures

Item No.	Item# as per MRS	Description	Unit	Quantity	Unit Rate (PKR) in Figures	Unit Rate (PKR) in Words	Amount (PKR) in Figures
1	4-20-b-ii	Demolition of existing damaged Bridge and placing of useful materials	100 Cft	21.45			
2	05-23	Cement Sand Mortar 1 : 4 (one Cement: 4 Sand)	100 Cft	1.93			
3	06-07-d-03	Reinforced cement concrete work as in dams, spillways, weirs, barrages, cross drainage works and other hydraulic structures using crushed stone aggregate (screening & washing) and coarse sand i/c costof all labour and material and finishing the exposed surface, cast in situ/precast excluding the cost of steel reinforcement and labour for bending binding also excludig cost of additives which have to be paid separately. (1:2:4)	100 Cft	22.86			
4	06-08-b	Supply & fabricate M.S. reinforcement for cement concrete (Hot rolled deformed bars Grade 60)	100 Kg	62.23			
	Total						

Engineer's Estimate Package-3(Canals)

Emergency Flood Assistance Project (EFAP)-KP

EFAP-KPID- CW-03: Rehabilitation of Canals and Drains, Paharpur Irrigation Division

Bill No. 13: Provision of Stone Pitching

Item No.	Item# as per MRS	Description	Unit	Quantity	Unit Rate (PKR) in Figures	Unit Rate (PKR) in Words	Amount (PKR) in Figures
1	03-12-a	Earth excavation in irrigation channels/drains & disposal upto 25m. & dressing : in Ordinary Soil	1000 Cft	70.67			
2	19-25	Providing and Laying stone pithcing/filling, dry hand packed in pitching & aprons	100 Cft	789.41			
3	19-28-a	Providing and laying stone pitching, for top layer only:- on slope	100 Cft	212.44			
4	19-28-b	Providing and laying stone pitching, for top layer only:- on level	100 Cft	87.00			
5	19-29-a	Providing and Laying stone or spawl filling : On slope	100 Cft	141.68			
6	19-29-b	Providing and Laying stone or spawl filling : On level	100 Cft	58.00			
7	06-48-j	Lean concrete for use as thin layer under neath footings with cylinder compressive strength of 1423 psi on 28 days	100 Cft	1.98			
8	06-44-b	PCC 1:3:6 in mass concrete less formwork using 40% boulders	100 Cft	29.21			
9	06-05-f	Plain Cement Concrete including placing, compacting, finishing & curing (Ratio 1:2:4)	100 Cft	34.29			
10	03-67-с	Structural backfill using Common Material available at site.	1000 Cft	0.27			
Total							

PACKAGE-3: EFAP/KPID/CW-03: REHABILITATION OF CANALS AND DRAINS, DISTRICT DI KHAN – PAHARPUR IRRIGATION DIVISION



EMERGENCY FLOOD ASSISTANCE PROJECT (EFAP) KHYBER PAKHTUNKHWA

Project Categorization Brief Sub-Project: Package 3 – Repair and Rehabilitation of Canals/Distributaries and Drains, Paharpur Irrigation Division

September 2023

Prepared for the Asian Development Bank (ADB)

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List of Acronyms

ADB	Asian Development Bank
EFAP	Emergency Flood Assistance Project
ESMF	Environmental and Social Management Framework
GBV	Gender Based Violence
GoP	Government of Pakistan
IP	Indigenous Peoples
IR	Involuntary Resettlement
JFPR	Japan Fund for Prosperous and Resilient Asia and the Pacific
JHA	Job Hazard Analysis
PDMA	Provincial Disaster Management Authority
PDNA	Post-Disaster Needs Assessment
PPE's	Personal Protective Equipment
SEA	Sexual Exploitation and Abuse
SH	Sexual Harassment
TBT	Tool Box Talks

1 PROJECT OVERVIEW

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- 1. Pakistan is a flood prone country and one of the ten countries most affected by climate change in the world. Flooding in Pakistan is primarily caused by heavy concentrated rainfall in the river catchments during the monsoon season which typically occurs from July through September. The floods are further supplemented by snowmelt/lake outbursts in upper snow covered reaches of the catchments. In the recent history, Pakistan witnessed unprecedented flooding in Khyber Pakhtunkhwa in 2010 and 2022. The occurrence of these flood events in upper most snow covered reaches of northern areas have proved that the climate change has severely impacted our region; 2022 flood was as a result of prolonged intense monsoon subsequent to unprecedented heat wave during April-Jun 2022 followed by intense rains experienced across the country and exposed our ill-planning towards adopting the climate resilient designs for irrigation as well as road infrastructure. The occurrence of these two rain-induced catastrophes within a span of just 13 years resulted in loss of life and major damages to irrigation and drainage infrastructure.
- 2. A post-disaster needs assessment (PDNA)² an effort led by the Government of Pakistan (GoP) and supported by a core team comprising Asian Development Bank (ADB), the European Union, United Nations (UN) agencies, and the Japan International Cooperation Agency with facilitation from the United Nations Development Programme and the World Bank was concluded on 28 October 2022, which provides the bases for the development of a disaster recovery framework and arrangements for effective, efficient and coordinated post-flood recovery and reconstruction plan. ADB with the assistance from the financiers Japan Fund for Prosperous and Resilient Asia and the Pacific (JFPR) has proposed emergency assistance to GoP through the Emergency Flood Assistance Project (EFAP). GoP and ADB agreed on financing of the total EFAP at \$531 million of which Irrigation Department of Khyber Pakhtunkhwa component is about \$62 million.
- 3. Total one hundred and forty-three (143) locations of south and north regions of Khyber Pakhtunkhwa have been identified to be taken up under the project on priority basis including seventy- nine (79) irrigation and drainage structures, sixty four (64) flood management infrastructures, and strengthening/re-sectioning of various protection embankments. For the ease of design and implementations, the project has been divided into the Packages and sub projects (schemes). To cover the South and North regions of Khyber Pakhtunkhwa, the project has been divided into 16 packages. Out of these 16 packages, 9 packages are allocated for the south region and 7 packages are allocated for the north region. South region primarily consists of canals and drains, including major canal systems like Chashma Right Bank Canal (CRBC) and Paharpur. On the other hand, the focus in the north region is mainly on flood protection works (FPWs). The map showing the work package detail is given as Figure 1.1.

¹ D. Eckstein, V. Kunzel, and L. Schafer. 2021. Global Climate Risk Index 2021: Who Suffers Most from Extreme Weather Events? Weather-Related Loss Events in 2019 and 2000–2019

² Government of Pakistan, Ministry of Planning, Development & Special Initiatives. 2022. Pakistan Floods 2022: Post-Disaster Needs Assessment. Islamabad.

EMERGENCY FLOOD ASSISTANCE PROJECT (EFAP) KHYBER PAKHTUNKHWA

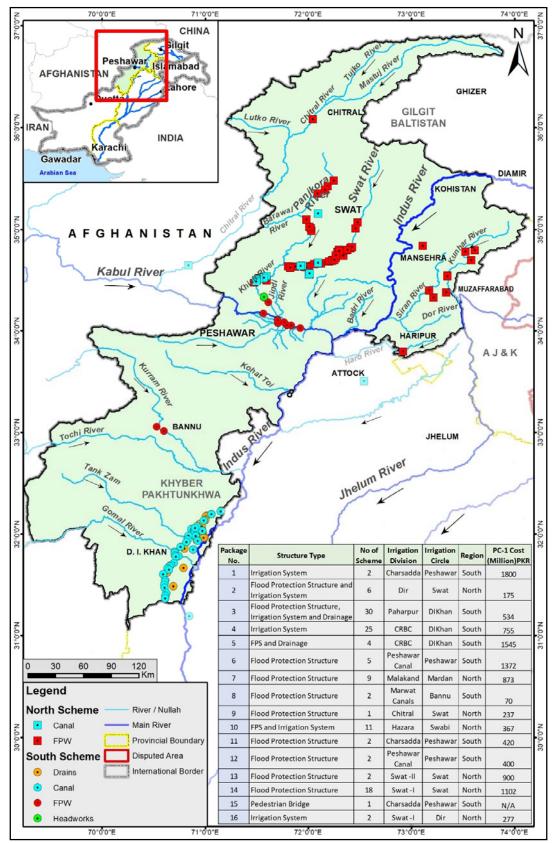


Figure 1.1: Map showing Locations under Different Packages

4. All the packages are categorized under different circles, and each package consists of a varying number of schemes. The area- wise package distribution is given in the pie chart below (Figure 1.2). The priority of the work packages is identified with the consent of client.

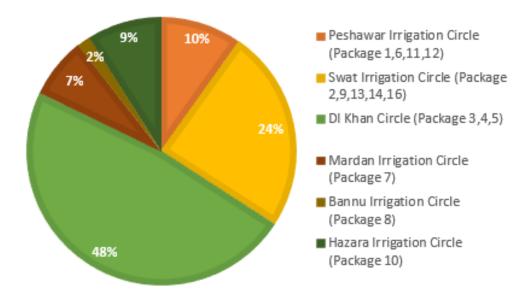


Figure 1.2: Pi-Chart Showing Percentage Weightage for Area Packages

5. This document is the project categorization document from an environmental and social safeguards perspective for the proposed Package-3: Repair and Rehabilitation of Canals and Drains, Paharpur Irrigation Division.

1.1 Sub-Projects Location

6. The current Package-3 falls in DI Khan Irrigation Circle (South Region) as shown in **Figure 1.3** and it involves the following rehabilitation works of Canals and Drains of Paharpur Irrigation Division:

A. Rehabilitation of Drains

- Rehabilitation of damaged / washed away Drains Section of Katgarh Branch Drain No. 3
- Rehabilitation of damaged / washed away Drains Section of Katgarh Branch Drain No. 4
- Rehabilitation of damaged / washed away Drains Section of Largi Drain No. 2
- Rehabilitation of damaged / washed away Drains Section of Largi Drain No. 1
- Rehabilitation of damaged / washed away Drains Section of Seed Farm Branch Drain
- Rehabilitation of damaged / washed away Drains Section of Bund Kurai Branch
 Drain
- Rehabilitation of damaged / washed away Drains Section of Bund Kurai Main Drain
- Rehabilitation of damaged / washed away Drains Section of Main Drain.

EMERGENCY FLOOD ASSISTANCE PROJECT (EFAP) KHYBER PAKHTUNKHWA

- Rehabilitation of damaged / washed away Drains Section of Girsal Drain
- Rehabilitation of damaged / washed away Drains Section of Girsal Pond Drain
- Rehabilitation of damaged / washed away Drains Section of Jabbarwala Drain
- Rehabilitation of damaged / washed away Drains Section of Ketch Drain
- Rehabilitation of damaged / washed away Drains Section of Bilot Creek Drain

B. Rehabilitation of Canals (Distributaries)

#

- Rehabilitation of damaged/washed away Canal Section of Disty # 2
- Rehabilitation of damaged/washed away Canal Section of Disty # 3
- Rehabilitation of damaged/washed away Canal Section of Girsal Minor
- Rehabilitation of damaged/washed away Canal Section of Girsal Feeder
- Rehabilitation of damaged/washed away Canal Section of Shah Kot Minor
- Rehabilitation of damaged/washed away Canal Section of Shah Kot Feeder
- Rehabilitation of damaged/washed away Canal Section of Band Kurai Minor
- Rehabilitation of damaged/washed away Canal Section of Band Kurai Branch
- Rehabilitation of damaged/washed away Canal Section of Ketch Minor
- Rehabilitation of damaged/washed away Canal Section of Paharpur disty
- Rehabilitation of damaged/washed away Canal Section of Old Paharpur canal (RD. 118500-122300)
- Rehabilitation of damaged/washed away Canal Section of Old Paharpur canal (RD. 130000-160000)
- Rehabilitation of damaged/washed away Canal Section of Civil Minor
- Rehabilitation of damaged/washed away Canal Section of Rakh disty
- Rehabilitation of damaged/washed away Canal Section of Kat Garh Minor
- Rehabilitation of damaged/washed away Canal Section of Bigwani Minor
- Rehabilitation of damaged/washed away Canal Section of Takarwah disty

The details of each subproject as mentioned above are shown in **Table 1.1**

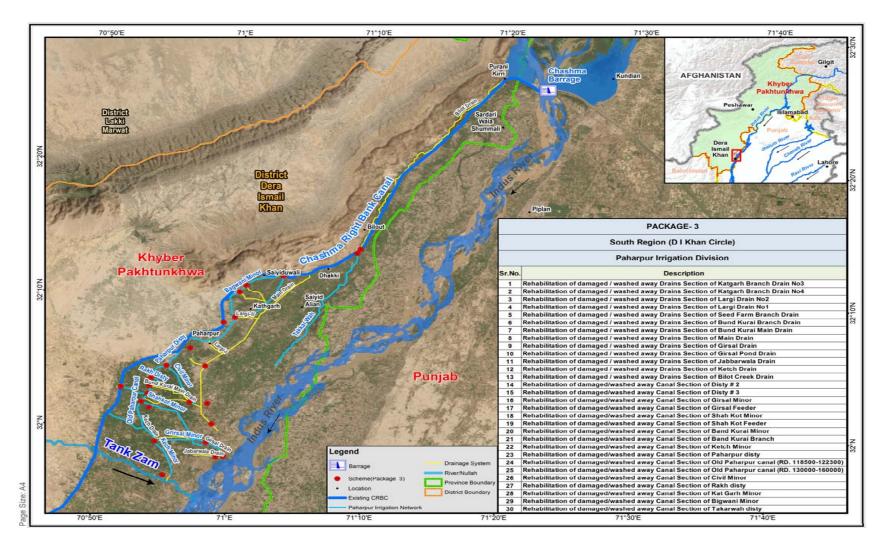


Figure 1.3: Location Map of Proposed Project#

1.2 Objectives of the subprojects

7. The core objective of these sub-projects is to rehabilitate the canals and drains affected by Floods within Paharpur Irrigation Division DI Khan. This rehabilitation work aims to reactivate the canals and distributaries, enabling the local inhabitants to access water for agricultural activities on their lands. The rehabilitation works on drains aims to protect the nearby communities from the floods.

1.3 Details of the sub-projects scope

Rehabilitation/ Repair of Drains

- 8. The flood event of 2022 revealed critical weaknesses within the drainage network of the Paharpur division. These vulnerabilities became evident as the drains were unable to cope with the overwhelming volume of floodwater, leading to breaches at various points along the network. The root causes of this issue can be attributed to both the inadequacy of the drainage system's capacity to handle such floods and the long-term neglect of regular annual operation and maintenance. Several critical issues contributed to the drainage network's diminished capacity are:
 - The drains have become heavily silted over time, reducing their water-carrying capacity and overall efficiency.
 - The presence of sarkanda and other vegetation within the drains further obstructed water flow, leading to overtopping during flooding events.
 - Bank erosion and damage in various sections of the drains
 - Soil removal from the banks and access roads of drains
 - Unauthorized cuts into the drain for draining excess water from fields poses significant challenges, including potential instability and flooding problems within the drainage network.
 - Confluence points within the drainage network were found to be improperly treated, impacting water flow and drainage efficiency.
 - Unauthorized paths created within the drains for crossing purposes pose a safety risk and disrupt the flow.
 - Encroachments were observed within the right-of-way of the drains (Largi drain), which need to be addressed to maintain clear channels.
 - Drains were being used as disposal points for solid waste, leading to environmental and sanitation concerns. (Largi drain)
- 9. Based on the findings from the condition survey of the project area, the proposed rehabilitation and protection works have been categorized into specific areas to address the identified damages effectively and include:
 - Case 1: Desilting and cleaning of drains
 - Case 2: Bank restoration of drains by earth compaction
 - Case 3 Construction of damaged portion of retaining walls
 - Restoration and provision of new stone pitching

The damaged drains have been rehabilitated according to the original designs as per approved L- section

Case 1: Desilting and Cleaning

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This case likely involves removal of accumulated silt and debris from the drains. Presence of accumulated silt, debris, heavy vegetation, and sarkanda in almost all the drains within the project area has been witnessed during the field reconnaissance visit as shown in **Figure 1.4.** The situation impedes the water flows and causing overflooding of the banks in heavy rain events. Therefore, it is essentially required to desilt and clean the drains and restore the original capacity of the drains.



Figure 1.4: Heavy Silt, Vegetation and Sarkanda in Drains

Case 2: Bank Restoration

Bank restoration has been proposed through earthen compaction to stabilize eroded or damaged banks. Earth compaction helps in preventing further erosion, reinforcing the structural integrity of the drains, and reduces the risk of breaches as shown in **Figure 1.5**.



Figure 1.5: Bank Restoration

Case 3: Brick Retaining Wall Side Protection

The retaining walls along the drains has been proposed in situations where existing walls are present at one side of drain only or washed away / damaged due to floods (Figure 1.6). This involves in constructing /rebuilding or repairing the damaged portions of the retaining walls to ensure they effectively support the banks and prevent erosion.

Retaining walls are relatively rigid walls used for supporting soil laterally so that it can be retained at different levels on the two sides. Retaining walls are structures designed to

restrain soil to a slope that it would not naturally keep to (typically a steep, near-vertical or vertical slope). They are used to bound soils between two different elevations often in areas of terrain possessing undesirable slopes or in areas where the landscape needs to be shaped severely and engineered for more specific purposes like hillside farming or roadway overpasses.





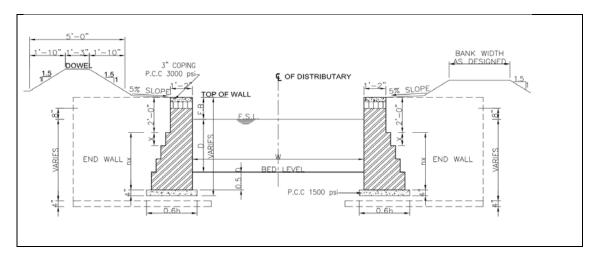


Figure 1.6: Brick Retaining Wall Side Protection

• Stone Side Protection

Stone pitching has been recommended especially downstream of hydraulic structures where erosive action is excessive. Proposed stone Pitching has 12 inches layer of revetments stone placed on a 6 inches spawl.

Pitching provides protection for canal/drain beds and side slopes adjoining the structures protection where the velocities are above 5 feet /sec or where the energy dissipation is involved or where the capacity and magnitude of the structure warrants the additional cost of stone pitching.



Package 3: Repair and Rehabilitation of Canals and Drains, Paharpur Irrigation Division EMERGENCY FLOOD ASSISTANCE PROJECT (EFAP) KHYBER PAKHTUNKHWA



Proposed Stone Pitching on US and DS of Hydraulic Structure







Proposed Stone Pitching at Confluence of Two (02) Drains

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Repair/Rehabilitation of Canals/Distributaries


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- 10. This proposed project focused on rehabilitation / restoration of distributaries / minors along with hydraulic structures of irrigation network. Following damages to the proposed project are observed:
 - Complete/partial washed away section of distributary lining due to entry of flood water;
 - Eroded and Weak distributary banks eroded due to erosion;
 - · Lining damaged in reaches due to overflowing water;

- Siltation and vegetation are quite common in distributaries and minors which causes overtopping in channels; and
- Hydraulic structures like bridges, culverts and fall structures have partial damages while, at some locations, complete demolition of structures.
- 11. Three (03) types of side protections have been proposed for the restoration of distributaries / minor prism.
 - Case 1: Brick Side Wall Protection
 - Case 2: Concrete Side Wall Protection
 - Case 3: Brick Retaining Wall Protection

Case 1: Brick Side Wall Protection


12. Brick side protection has been proposed to restore the prism of distributaries and minors that are damaged due to flood. The side protection has been proposed in those distributaries / minors that have already brick lining or unlined reaches where embayment in sections was also observed as shown in Figure 1.7.

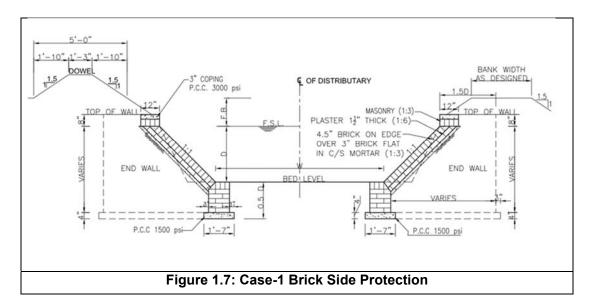

Case 2: Concrete Side Protection


- 13. Concrete side protection has been proposed for highly scoured reaches of the distributaries and minors where existing reaches have already concrete lining on both sides (Figure 1.8). The purpose of providing concrete side protection is to protect the distributaries/minor from erosion during the flood. Total length of concrete side protection provided is 149050 ft. Concrete side protection has further been divided in three (03) cases.
 - Case 2-A: Concrete Side Protection
 - Case 2-B: Concrete Side Protection with Side Wall (L/R)

- Case 2-C: Concrete Side Protection with Side Wall (L&R)

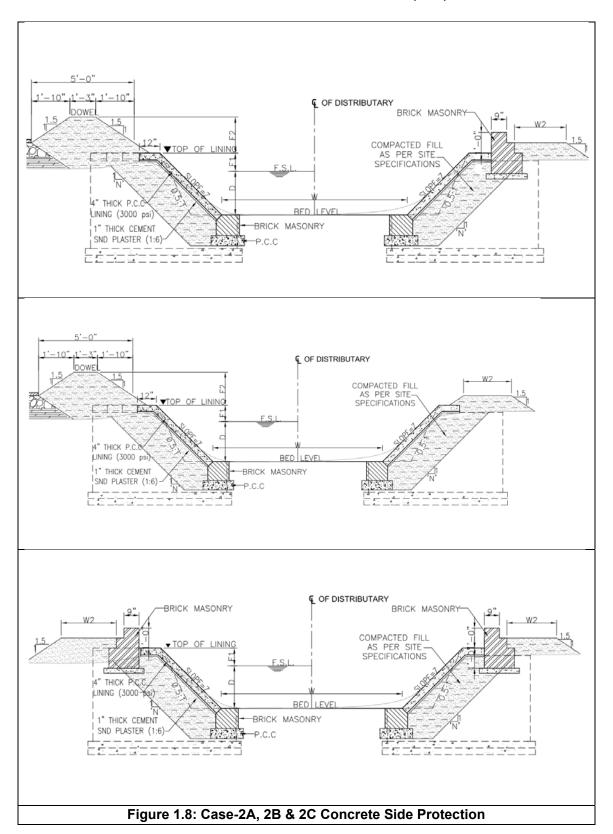


• Case 3: Concrete Lining

14. Existing distributaries and minors are concrete lined and have damages due to floods. Therefore, it has proposed to restore the prism of channel by providing concrete lining in damaged portions. The lining is provided with 4.0 inches thick concrete (1:2:4) over 1 inch thick 1:6 cement sand mortar placed on the moistened, compacted grade, as shown in Figure 1.9

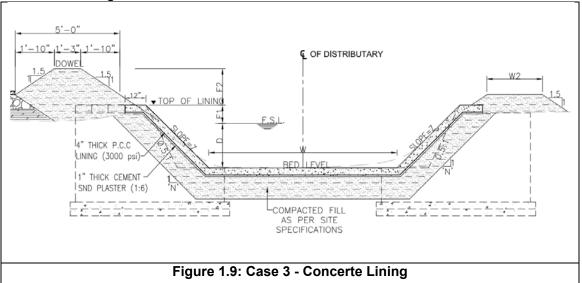


Case 4: Brick Retaining Wall Side Protection

15. The retaining walls provided in distributaries are washed away / damaged due to floods. At these locations, side walls have been designed and proposed to be re-constructed as shown in **Figure 1.10**. Retaining walls are relatively rigid walls used for supporting soil laterally so that it can be retained at different levels on the two sides. Retaining walls are structures designed to restrain soil to a slope that it would not naturally keep to (typically a steep, near-vertical or vertical slope). They are used to bound soils between two different elevations often in areas of terrain possessing undesirable slopes or in areas where the landscape needs to be shaped severely and engineered for more specific purposes like hillside farming or roadway overpasses.

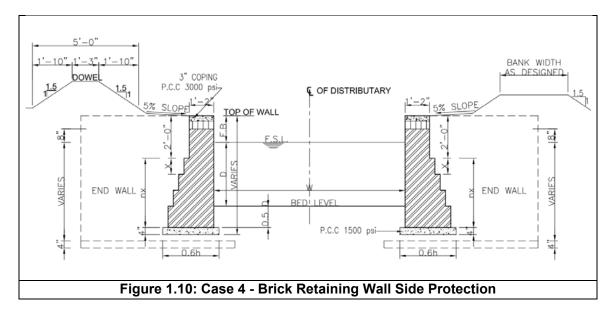

• Case 5: Stone Side Protection

- 16. Stone pitching has been recommended especially downstream of falls & bridges where erosive action is excessive (**Figure 1.11**). Stone Pitching used mostly are 12 inches to layer of revetments stone placed on a 4 inches layer of graded filter ($\frac{1}{2}$ " 2" over another 4 inches layer graded filter ($\frac{1}{8}$ $\frac{1}{2}$ "). The revetment stone consist of a quarried rock ranging in weight from 20 to 50 Kg with the voids filled by rock sprawl ranging in size from 2 inches to 4 inches.
- 17. Pitching consists as protection for distributary beds and side slopes adjoining the structures protection where the velocities are above 5 feet /sec or where the energy dissipation is involved or where the capacity and magnitude of the structure warrants the additional cost of stone pitching.

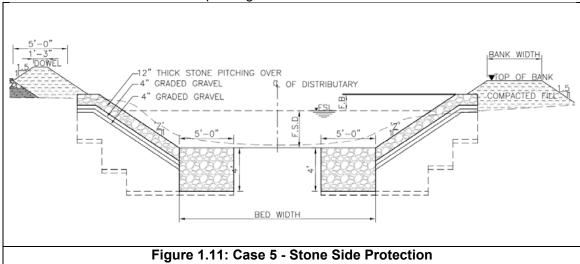

18. The rehabilitation woks of distributaries/canals and drains will serve the following purposes:

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- Providing a steady and controlled flow of water to the agricultural lands;
- Allowing farmers to efficiently distribute the water into their lands leading into increased agricultural yield and livelihood for farmers; and
- Managing water levels during periods of heavy rainfall, reducing the risk of inundation and damage to surrounding areas; and
- Cleaning and Desilting the drains to increase its flood carrying capacity.

19. Major Construction work/activities involve:

- Transportation of construction material;
- Restoration of distributary prism by brick/stone side protection;
- Restoration of lining of distributary;
- Construction of retaining walls;
- Restoration and provision of new stone pitching;
- Distributary bank restoration/raising; and
- Rehabilitation of patrol roads and culverts etc.
- 20. All works will be confined within existing Right of Way (ROW) of Irrigation department. Few environmental and social impacts are anticipated which will be temporary, short-term and localized limited to the construction phase and will primarily relate to noise, and air (dust) emissions, solid waste generation and disposal of wastewater, occupational and community health and safety. The cross section details of the proposed construction works are shown in **Figure 2.1-2.7.**

Table 1.1: Details of Sub-projects

				Location (Co	ordinates)			Case Wise	
Sr. No.	Name of Work	Village	Estimated Cost	Easting	Northing	RDs	Type of Rehabilitation Work	Proposed Rehabilitation Works	Length of Rehab Works (ft.)
					CANALS				
1.	Rehabilitation of damaged / washed away Drains Section of Katgarh Branch Drain No3	Kathgarh	24	71º00'53"	32º10'49"	1+000 2+460 4+108 10+500 12+556 15+115	Section Cleaning	-	17,575
2.	Rehabilitation of damaged / washed away Drains Section of Katgarh Branch Drain No4	Kathgarh	23.5	71º00'34"	32º10'10"	3+900 6+700 9+000 10+100	Section Cleaning	-	10,100
	Branch Brain No-					5+800	Section Restoration		
3.	Rehabilitation of damaged / washed	Daharpur	14	71º00'06"	32º08'24"	6+850 9+308	Section Cleaning		9,208
3.	away Drains Section of Largi Drain No2	Paharpur	14	71900 06	32°08 24"	7+070	Section Restoration	1 -	9,208
4.	Rehabilitation of damaged / washed away Drains Section of Largi	Paharpur	19	70º58'15"	32º06'34"	1+500 4+000 5+700 8+509	Section Cleaning	Case - 3: Brick Retaining Wall Side Protection	7,909

_				Location (Co	ordinates)		Type of	Case Wise	Length of
Sr. No.	Name of Work	Village	Estimated Cost	Easting	Northing	RDs	Rehabilitation Work	Proposed Rehabilitation Works	Rehab Works (ft.)
	Drain No1								
						5+800	Right Bank Protection		
						2+750 4+150	Left Bank Protection		
						0+000	Box Culvert Required		
5.	Rehabilitation of damaged / washed away Drains Section of Seed Farm Branch Drain	Rakh & Beeli	4	70º58'5.17"	32º04'39"	6+860	Section Cleaning	-	6,860
	Rehabilitation of damaged / washed away Drains					6+000 12+000 19+019	Section Cleaning	-	19,350
6.	Section of Bund Kurai Branch Drain	Bandkurai	39	70º55'56"	32º02'01"	19+019	Section Desilting		
						19+019- 18+689	Section Restoration		
	Rehabilitation of damaged / washed					23+500	Section Cleaning		
7.	away Drains Section of Bund Kurai Main Drain	Bandkurai	50	70°53'59"	32º03'00"	4+700 10+440 23+500	Section Restoration	-	25,300

				Location (Coordinates)			Type of	Case Wise	Length of
Sr. No.	Name of Work	Village	Estimated Cost	Easting	Northing	RDs	Rehabilitation Work	Proposed Rehabilitation Works	Rehab Works (ft.)
						2+750 4+450	Left Bank Protection		
						3+300	Right Bank protection		
						0+100 – 17+447	Section Cleaning		
8.	Rehabilitation of damaged / washed away Drains Section of Main Drain.	Awan , Lang Kher Shah & Bandkurai	45	71°02'47''	32°09'19"	8+500 42+900 49+500 55+200 61+000 64+500 69+000 78+187 84+000 93+000	Section Restoration	-	31,900
						14+000 14+050	Left Bank Protection		
						26+650	Section Restoration		
	Rehabilitation of					28+300	Box Culvert		
9.	damaged / washed away Drains Section of Girsal Drain	Dahotr & Sardarywala	14.5	70°54'32"	31º59'03"	26+662	Section Cleaning	-	26,662
10.	Rehabilitation of damaged / washed away Drains Section of Girsal Pond Drain	Dahotr & Kiri Niazi Wala	4.5	70 ⁰ 59'18"	31º58'27"	1+925	Section Cleaning	-	900

				Location (Co	ordinates)		Type of	Case Wise	Length of
Sr. No.	Name of Work	Village	Estimated Cost	Easting	Northing	RDs	Rehabilitation Work	Proposed Rehabilitation Works	Rehab Works (ft.)
	Rehabilitation of damaged / washed					10+590 26+000	Section Cleaning		
11.	away Drains Section of Jabbarwala Drain	Jabarwala & Mosakher	14	70º58'14"	31º57'56"	5+000 11+650	Bank Protection	-	21,900
12.	Rehabilitation of damaged / washed away Drains Section of Ketch Drain	Muqeem Shah, Girsal & Ketch	4	70º55'29"	31º57'45"	11+998 14+350 15+744 21+694 22+993 31+050 44+710 47+990 49+899 55+446	Section Cleaning	-	58,990
				70°54'37"	32º04'26"	31+130 58+996	Section Restoration		
13.	Rehabilitation of damaged / washed away Drains Section of Bilot Creek Drain	Bilot Shehr	9	71º11'36''	32º18'29"	24+000 44+000 64+000 80+000 103+000	Section Cleaning	Case - 3: Brick Retaining Wall Side Protection	103,105
						14+000	Retaining Wall		
				D	ISTRIBUTARI	ES			
14.	Rehabilitation of damaged/washed away Canal Section of Disty # 2	Band Kurai	15	70°52'59''	32º02'31"	4+554- 6+254	Concrete Lining	Case - 2 : Concrete Lining	3,400
15.	Rehabilitation of damaged/washed away Canal Section	Kech	34	70°53'39''	31º59'51"	0+040 4+575	Brick side protection	Case - 3: Brick Retaining Wall Side Protection	10,330

				Location (Co	ordinates)		Type of	Case Wise	Length of	
Sr. No.	Name of Work	Village	Estimated Cost	Easting	Northing	RDs	Rehabilitation Work	Proposed Rehabilitation Works	Rehab Works (ft.)	
	of Disty # 3					8+550	Road Rehabilitation	Case - 2 : Concrete Lining		
						11+750	Concrete PCC Lining			
	Rehabilitation of					4+400	Brick side protection	Case - 3 : Brick		
16.	damaged/washed away Canal Section of Girsal Feeder	Girsal	5.5	70°53'59''	31º59'39"	5+675 6+550	Brick side protection and Road Rehabilitation	Retaining Wall Side Protection	450	
17.	Rehabilitation of damaged/washed away Canal Section of Girsal Minor	Girsal	14	70°57'25''	31º59'00"	2+220 4+920 7+915 8+325 12+375 17+500	Road Restoration	Case - 2 : Concrete Lining	7710	
						16+225	Concrete PCC Lining			
	Rehabilitation of damaged/washed					2+675 4+335 4+590 5+065 6+500 8+250 13+250	Road Rehabilitation	Case - 1B-1C- 1D: Concrete		
18.	away Canal Section of Shah Kot Minor	Shah Kot	32.5	70°57'02''	31º59'46"	3+175 5+140 6+125 6+925 9+475	Concrete Side Protection	Side Protection with Side Wall (L&R)	8,110	

				Location (Co	ordinates)		Type of	Case Wise	Length of	
Sr. No.	Name of Work	Village	Estimated Cost	Easting	Northing	RDs	Rehabilitation Work	Proposed Rehabilitation Works	Rehab Works (ft.)	
						14+650 18+435 21+025 22+935 23+170 24+015 24+315 26+015 27+135	Road Rehabilitation + Concrete Side Protection With Side Wall			
						18+600 18+950 20+000	Raising Wall			
19.	Rehabilitation of damaged/washed away Canal Section of Shah Kot Feeder	Shah Kot	10	70°57'24''	31º59'11"	0+050 0+100 2+750 3+250	Brick side protection	Case - 3 : Brick Retaining Wall Side Protection	700	
	Rehabilitation of					4+700 11+550 13+550	Concrete Lining	Case - 1A :		
20.	damaged/washed away Canal Section of Band Kurai Minor	Band Kurai	18.5	70°53'53''	32º02'26"	6+550	Concrete Side Protection With side walls	Concrete Side Protection Case - 2:	6,450	
						10+275	Bank Restoration	Concrete Lining		
21.	Rehabilitation of damaged/washed away Canal Section	Band Kurai	9	70°53'53''	32º02'26"	0+200 1+650 2+595	Concrete Side Protection With side walls	Case - 1A : Concrete Side Protection Case - 1C:	1,450	
21.	of Band Kurai Branch	Danu Kurdi	3	10-33 33	32002 20	0+800	Concrete Lining	Concrete Side Protection Case - 2: Concrete Lining	1,450	
22.	Rehabilitation of	Ketch	6			0+550	Concrete Side	Case - 1A :	2,640	

				Location (Co	ordinates)		Type of	Case Wise	Length of
Sr. No.	Name of Work	Village	Estimated Cost	Easting	Northing	RDs	Rehabilitation Work	Proposed Rehabilitation Works	Rehab Works (ft.)
	damaged/washed away Canal Section of Ketch Minor			70 ⁰ 53'45''	31º59'53"	2+620 4+000 5+700	Protection With side walls	Concrete Side Protection Case - 2:	
						9+100 11+050	Concrete Lining	Concrete Lining	
						14+500	Bank Restoration		
23.	Rehabilitation of damaged/washed away Canal Section of Paharpur disty	Paharpur	22.5	70°57'01''	32°06'42"	12+950 13+700 25+950 28+000 28+975 37+750 39+400 39+560 43+700	Concrete Side Protection With Both side walls	Case - 1A : Concrete Side Protection Case - 1C: Concrete Side Protection Case - 2:	2,400
						39+400 40+100 43+765	Road Rehabilitation	Concrete Lining	
	Rehabilitation of damaged/washed					120+070	Brick Retaining Wall		
24.	away Canal Section of Old Paharpur canal (RD. 118500- 122300)	Band Kurai	17.5	70°53'51"	32°02'26''	119+075 120+320	Road Restoration	Case - 2 : Brick Retaining Wall Side Protection	1,270
	Rehabilitation of					130+000	Rehabilitation of Head Regulator		
25.	damaged/washed away Canal Section of Old Paharpur	Band Kurai	17.5	70°53'27''	32°01'51''	132+200 136+590 138+650	Road Rehabilitation	-	3,700

				Location (Co	ation (Coordinates)		Type of	Case Wise	Length of
Sr. No.	Name of Work	Village	Estimated Cost	Easting	Northing	RDs	Rehabilitation Work	Proposed Rehabilitation Works	Rehab Works (ft.)
	canal (RD. 130000- 160000)					138+850 139+050 141+750 148+650			
						3+025	Concrete Lining		
	Rehabilitation of					5+950 8+520 14+250	Concrete Side Protection	Case -1C: Concrete Side	
26.	damaged/washed away Canal Section of Civil Minor	Dabotar	33	70°56'55''	32°02'22"	6+425 7+195 10+240 12+340 15+595 17+750 18+350 19+565 19+755	Road Rehabilitation	Protection with Side Wall Case - 2:Concrete Lining	3,510
27.	Rehabilitation of damaged/washed away Canal Section of Rakh disty	Rakh	9.5	70°55'41''	32°02'59''	3+090 4+025 5+055 5+875 5+945 6+165 6+850 9+035	Concrete Lining and Bank restoration	Case - 2: Concrete Lining	330
28.	Rehabilitation of damaged/washed away Canal Section of Kat Garh Minor	Kat Garh	9.5	71°01'38''	32°08'48''	5+885 6+500 8+450 10+500	Concrete Side Protection	Case -2C : Concrete Side Protection Case -	700
29.						16+150 18+600	Concrete Lining	3:Concrete Lining	
30.	Rehabilitation of	Bigwani	6.5	71 °01'46"	32°11'18"	3+825	Road	-	270

				Location (Co	ordinates)		Type of	Case Wise	Length of
Sr. No.	Name of Work	Village	Estimated Cost	Easting	Northing	RDs	Rehabilitation Work	Proposed Rehabilitation Works	Rehab Works (ft.)
	damaged/washed away Canal Section of Bigwani Minor					4+325 5+025 12+910	Restoration		
31.	Rehabilitation of damaged/washed away Canal Section of Takarwah disty	Takarwah	9	71 °06'08''	32 °08'30"	8+450 8+650 8+850 11+840 13+730 14+515 15+125 21+683 23+200 23+800 25+955 29+375	Concrete Side Protection Brick Retaining	Case - 2B : Concreprotection 2C: Concrete Side Side Wall (L&R) Case - 4: Brick Reprotection 4,645	Case - Protection with

2 Anticipated Environmental and Social Impacts

21. The proposed sub-projects have been visited and assessed for anticipated environmental and social impacts during construction phase. In operation phase, the distributaries will provide water to the nearby communities for agriculture purposes and the drains will act as a flood carrier channels and save the nearby communities from the floods.

2.1 Positive Socio-Economic and Environmental Impacts of Sub-projects

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- 22. Following are the anticipated positive socio-economic and environmental impacts:
 - Improves the agricultural productivity by ensuring a consistent and controlled water supply to agricultural lands;
 - Enhances food security for the local communities;
 - Creates employment opportunities in agriculture and related sectors, boosting incomes for farmers and supporting rural livelihoods; and
 - Manages excessive water during heavy rainfall or flooding, mitigating the risk of flood damage to crops, infrastructure, and communities.

2.2 Anticipated Adverse Environmental and Social Impacts

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23. From an environmental and social perspective, the sub-projects are likely to have small and limited-scale potential adverse impacts. The anticipated environmental and social impacts and mitigation measures related to the proposed sub-projects are summarized in **Table 2.1**

Table 2.1: Anticipated Adverse Environmental and Social Impacts

		Environmental and Social Impacts
Sr.	Environmental and Social Impacts	Mitigation Measures
No		
1.	Climate Risks The construction activities of subproject can be affected due to the climate risks during the severe vulnerable conditions such as heat waves, heavy rains and floods.	 Reduce the working hours of workers during extreme hot environment and heat waves. Construction work will be started and planned considering the weather forecast and special attention will be required for monsoon season.
2.	Deterioration of surface water quality Construction activities and the wastewater including oil/chemical spills from the construction camps can contain harmful substances which may deteriorate the water quality of the disties.	 Campsites will be located at least 500m away from the distributary and settlement. No waste stream will be allowed to enter distributary and drain without treatment where it can affect downstream water quality and human health. Adequate sanitary facilities and drainage in the worker's camps will help to avoid this possibility. Construction materials will be properly covered and stored to prevent runoff of construction material and waste into the distributary and drain. The Erosion Control Blankets and Mats can be used to control the sediment runoff.
3.	Noise Pollution and Vibration Impact Noise and vibration is envisaged due to	- Construction Contractor will ensure that; (i) machinery is adequately silenced and (ii) machinery operations close to urban areas will

Package 3: Repair and Rehabilitation of Canals and Drains, Paharpur Irrigation Division EMERGENCY FLOOD ASSISTANCE PROJECT (EFAP) KHYBER PAKHTUNKHWA

Sr. No	Environmental and Social Impacts	Mitigation Measures
	general construction activities and machinery movement.	be restricted to day time only.
4.	Deterioration of Air Quality Dust will be generated due to the general construction activities and movement of construction vehicles in the proposed sub-project site.	 Dust control measures such as water spraying or dust suppressants will be used to reduce airborne dust particles. Temporary windbreaks and barriers such as temporary fences will be installed around the construction site to reduce the spread of dust to nearby residential areas and river body. Properly tuned vehicles and regular maintenance and inspection of vehicles must be ensured.
5.	Occupational Health and Safety Impacts Construction labor and construction staff hired during the construction period will be subject to occupational health and safety risks. Following risks are anticipated due to proposed project: Slip and trip Fall from height Struck-By and Caught-Between Vector borne diseases Eye and head injuries Noise and dust pollution Health issues with the workers/staff	 Construction contractor will ensure that Tool Box Talks (Tots) are conducted regularly. All the staff and Labor shall be provided with working personal protective equipment (PPE's). IFC-EHS guidelines (General Guidelines, Elevated and Overhead Work guidelines, Fall Protection guidelines, Fire, Control of chemical hazards guidelines) will be followed for Occupational Health and Safety. Occupational Health and Safety Plan will be prepared and implemented by Contractor(s). Contractor(s) will ensure that Job Hazard Analysis (JHA) is performed prior to commencing jobs.
6.	Community Health and Safety Increase risk of illicit behavior and crimes Increased risk of communicable diseases Conflicts between locals and workers related to religious, cultural or ethnic differences Child abuse, drug/substance abuse and Sexual Harassment (SH) and Sexual Exploitation and Abuse (SEA)	 Failure/ Collapse of banks during operation stage due to emergency situation such as flood/earthquake. A regular inspection and maintenance program will be ensured to identify and address any potential vulnerabilities or issues that could affect the wall during a flood. Flood warning systems must be ensured which will provide timely information about rising water levels or impending flood events. Work during construction as well as travelling during operation will be halted during such emergencies. Comprehensive emergency response plans in compliance with Provincial Disaster Management Authority (PDMA) specific to the flood events will be developed and updated regularly. Communicable disease associated with the influx of temporary construction labor which will be reduced by implementing Worker Code of Conduct, ensure minimum to no interaction of workers with local community, health awareness initiatives; immunization program and providing health service. Trainings will be given to construction workers, alongside the implementation of strict measures and punishments in case of any child abuse,

Sr. No	Environmental and Social Impacts	Mitigation Measures
7.	Soil Erosion and Contamination Construction activities and the use of construction machinery at the site will leads to soil erosion	drug/substance abuse and SEA/SH. - Best management practices will be adopted during construction which includes limiting earthmoving and minimizing soil disturbance. - Cordon off the designated area along the distributary as livestock exclusion zones to prevent direct access to the water. - Washing yards will be paved to avoid seepage of runoff from the yard. - Septic tanks of adequate capacities will be constructed for receiving and treating wastewater from all temporary worksite toilets and other facilities. The wastewater will not be discharged untreated onto the adjacent lands. - Erosion control measures will be adopted to prevent soil erosion and sediment runoff. - Dense vegetation along the banks of the distributaries and drains will act as a natural barrier and reduce the risk of soil erosion in future.
8.	Scouring of Canals/distributaries During construction, the slopes of the disty may be unstable due to loose soil or lack of proper compaction, making them susceptible to erosion and scouring.	- The contractor will identify the weak slope areas along the distributaries and drains and avoid the movement of vehicle as well as machinery along such areas.
9.	Clogging of Canals/ distributaries/drains Construction activities will lead to increase erosion and sediment runoff into the disty. The increase in accumulation of sediments in a disty will reduce the carrying capacity of disty and ultimately leads to clogging of disty.	 Construction materials will be properly covered and stored to prevent runoff of construction material and waste into the distributaries and drains. The stabilization of exposed soil areas will be ensured during the construction activities by using slope stabilization methods.
10.	Impacts on Flora, Fauna and Aquatic life There is no direct impact on flora and fauna. However, construction activities, stockpiling of material and the wastewater discharge including oil/chemical spills from the camps can contain harmful substances which may cause impact on aquatic life.	 Cutting of trees and shooting, hunting, trapping or poaching of animals and birds will totally be banned within the study area, so as to minimize indirect impact of flora and fauna. Storage of (construction) material confined to work sites. Direct discharge of wastewater into water body will be avoided. Construction materials will be properly covered and stored to prevent runoff of concrete additives and construction waste into the water body. Good housekeeping will further reduce the likelihood and severity of this impact. Restoring temporarily disturbed areas / land take to pre-construction conditions
11.	Social and Cultural Conflicts Use of local resources and products by the construction workers and	Local labor especially from nearby communities will be given preference for the construction works.

Sr. No	Environmental and Social Impacts	Mitigation Measures
	differences in cultural values may cause discomfort to local residents.	 Avoid use of local resources (especially community water supply sources) to reduce the social conflicts. Contractor will ensure the availability of drinking water (preferably potable water) at site. Strict implementation of Worker Code of Conduct will be ensured to eliminate such social and cultural issues.
12.	Child Labor and Gender Based Violence (GBV) The impact of child labor and gender based violence may arise during the construction stage of the sub-project.	 Child labor will be prohibited. It will be ensured that contractor will have its employment policy in accordance with relevant act and labor policies of Khyber Pakhtunkhwa and Pakistan. Provision related to GBV, SEA/SH will be incorporated worker's code of conduct. Trainings will be given to construction workers, alongside the implementation of strict measures and punishments in case of any sexual assaults, or GBV.

2.3 Recommendation

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- 24. The Khyber Pakhtunkhwa Environmental Assessment Rules, 2021 provides screening categories of the projects for which environmental assessment need to be conducted. As the proposed project does not involve the construction of new canal/channel, hence no environmental assessment is required as per the aforementioned regulations.
- 25. However, based on the review of the "Environmental and Social Management Framework" (ESMF) prepared for EFAP and "ADB SPS 2009", the proposed project has been classified as "Category C" based on the limited scope of work activities limiting in the existing ROW with no change in overall land use of the project area. The severity of expected E&S impacts is low. Some of the minimal impacts like occupational health and safety concerns, air and noise disturbance, social and cultural issues, child labor, GBV, SEA/SH are anticipated but will be mitigated via engineering as well as administrative controls and measures as stated above. The Rapid Environmental Assessment (REA) Checklist is annexed with the report.

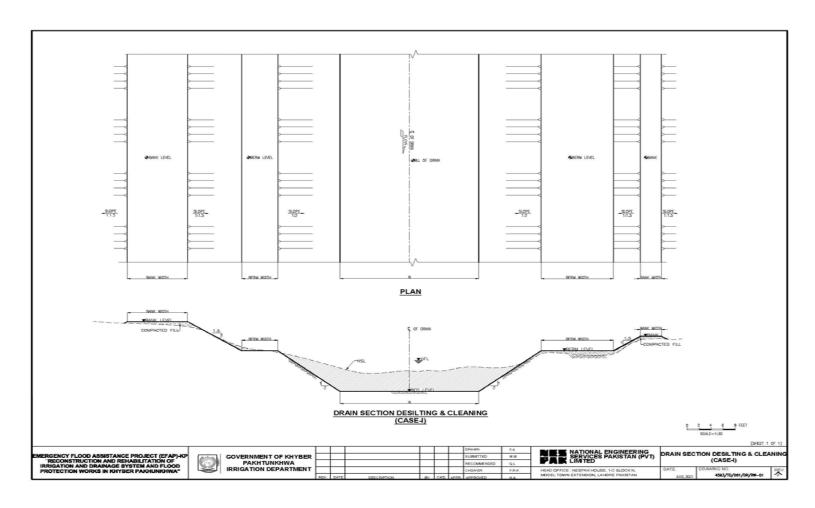


Figure 2.1: Typical Cross Section for Section Cleaning and Desilting of Drains

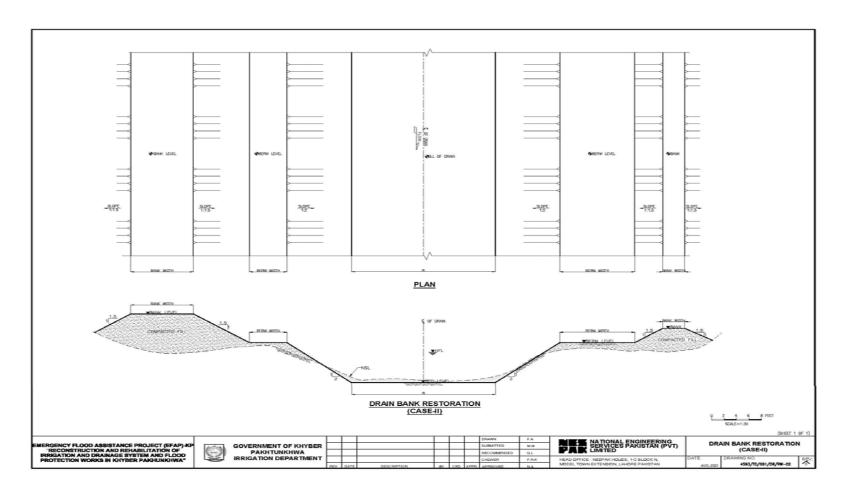


Figure 2.2: Typical Cross Section for Drain Bank Restoration

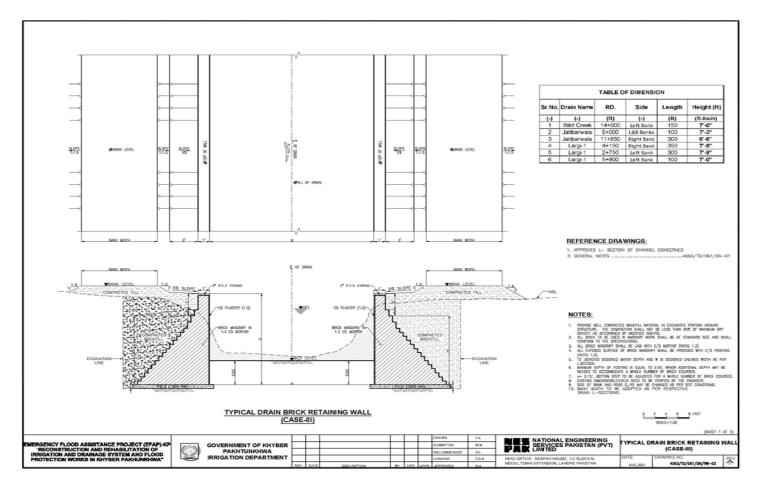


Figure 2.3: Typical Cross Section for Drain Bank Retaining Wall

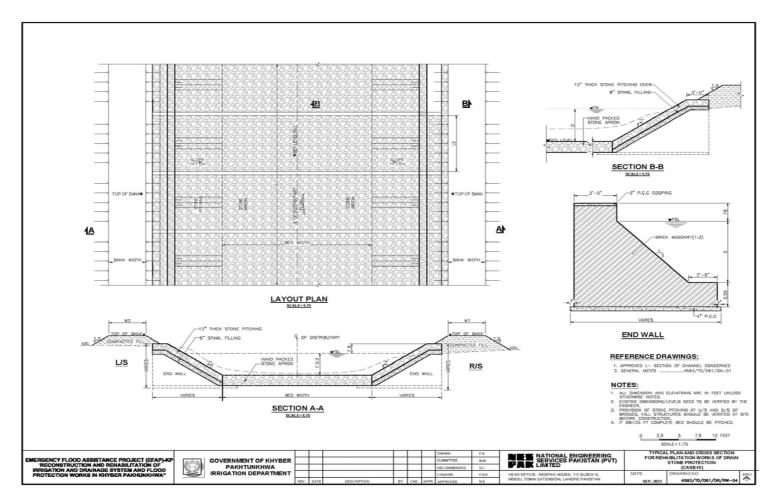


Figure 2.4: Typical Cross Section for Rehabilitation of Drains Stone Protection

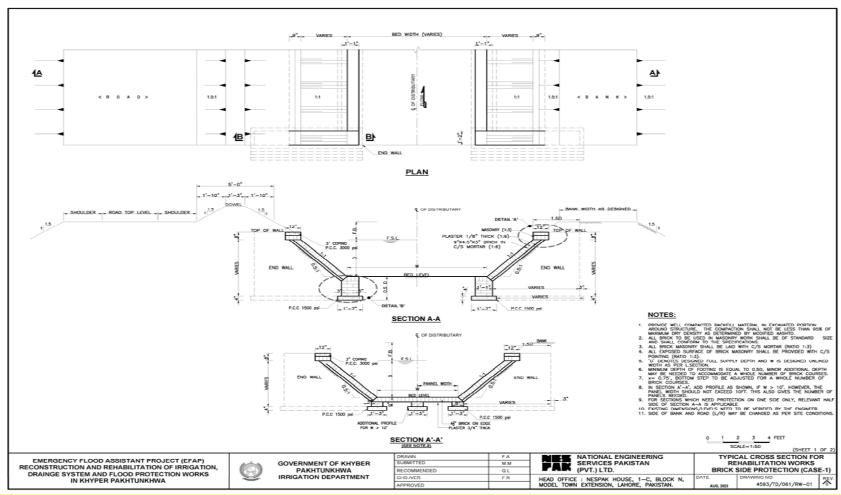


Figure 2.5: Typical Cross section for Rehabilitation works Brick Side Protection Wall

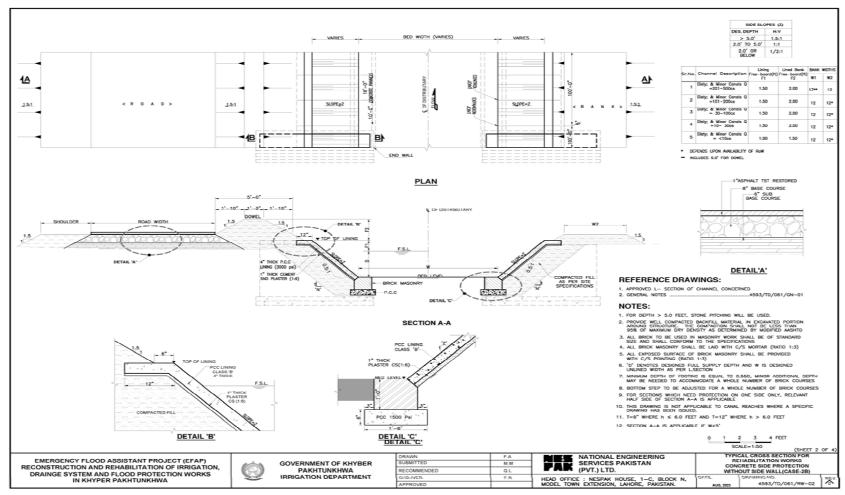


Figure 2.6: Typical Cross section for Rehabilitation work concrete side protection

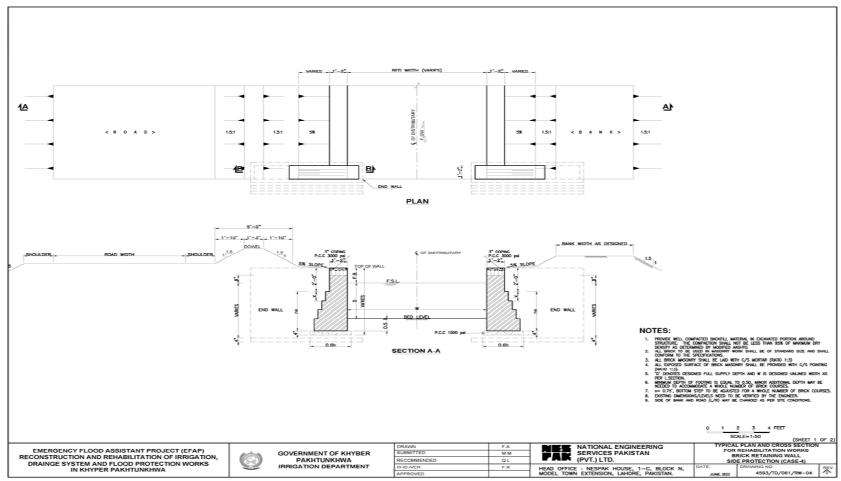


Figure 2.7: Typical Cross section for Rehabilitation work Brick Retaining Wall

ANNEXURES

ANNEXURE: RAPID ENVIRONMENTAL ASSESSMENT (REA) CHECKLIST

Instructions:

- (i) The project team completes this checklist to support the environmental classification of a project. It is to be attached to the environmental categorization form and submitted to the Safeguard Division (SDSS), for endorsement by the Director, SDSS and for approval by the Chief Compliance Officer.
- (ii) This checklist focuses on environmental issues and concerns. To ensure that social dimensions are adequately considered, refer also to ADB's: (a) checklists on involuntary resettlement and Indigenous peoples; (b) poverty reduction handbook; (c) staff guide to consultation and participation; and (d) gender checklists.
- (iii) Answer the questions assuming the "without mitigation" case. The purpose is to identify potential impacts. Use the "remarks" section to discuss any anticipated mitigation measures.

Country/ Project Title

Pakistan, Khyber Pakhtunkhwa, Emergency Flood Assistance Project (EFAP)

Package 3: Repair/Rehabilitation of Drains, Paharpur Irrigation Division DI Khan (For detail of work Refer Section 1)

Sector Division

Irrigation Sector, Central and West Asia Department (CWRD), Pakistan

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Project Brief

Package involves Repair/Rehabilitation of Drains Canal/Distributaries, Paharpur Irrigation Division DI Khan. This package includes thirty schemes/subprojects among which thirteen (13) are related to the rehabilitation of drains. The overview of the proposed package is provided in Table 1.1. This Package falls in DI Khan Irrigation Circle (south region). The construction work for Rehabilitation/Repair of Drains involves removal of Sakranda growth, Desilting, transportation of construction material, brick side protection and bank rising. All works are confined within existing Right of Way (ROW) of Irrigation department and there is no protected and notified cultural site within or near the vicinity of the project area. Few environmental and social impacts are anticipated which are temporary, short-term and localized limited to the construction phase and are primarily related to soil erosion, noise, and air (dust) emissions, solid waste generation and disposal of wastewater, occupational and community health and safety.

Screening Questions	Yes	No	Remarks
A. Project Siting			
Is the project area adjacent to or within any			
of the following environmentally sensitive			
areas?		,	
Cultural heritage site		V	No cultural heritage site is noted or
		,	reported within the project area.
Protected Area			No notified protected area falls adjacent
		,	to or within the project area.
Wetland			There is no notified wetland near the
		.1	project area.
Mangrove		V	There are no mangrove trees or forests located near to or in the vicinity of the
			project area.
Estuarine		V	There is no estuarine environment or
• Estuarine		V	an estuary located along the project
			area
Buffer zone of protected area		V	There is no notified buffer zone of the
Bullet Zolle of protected area		٧	protected area falls inside or near
			vicinity of project area.
Special area for protecting		V	There is no notified special area for
biodiversity		·	protecting biodiversity near the project
,			area
B. Potential Environmental Impacts			
Will the project cause		-	
Loss of precious ecological values (e.g.		V	No precious ecological values are
result of encroachment into forests/swamplands or historical /cultural			situated within or near the vicinity of the
buildings/areas, disruption of hydrology			project area. Hence no such impact is
of natural waterways, regional flooding,			envisaged.
and drainage hazards)?	,		
Conflicts in water supply rights and related social conflicts:			There might be pressure on the
related social conflicts;			drinking water source due to the
			construction workers/staff.
			This impact will be mitigated by:
			Avoid use of community water
			supply sources to reduce the social
			conflicts;
			Contractor will ensure the
			availability of drinking water
Improdiments to recoverage of recover	1		(preferably bottled water) at site.
 Impediments to movements of people and animals? 	\ \		The rehabilitation of banks and cleaning
and animals!			of may cause temporary hindrance to the pedestrian and animals crossing.
			the pedesthan and animals crossing.
			Construction activities will be properly
			planned and working on one section of
			a drain at a time will be prioritized to
			allow other sections to remain
			accessible for crossing.
			Construction activities will be scheduled

Screening Questions	Yes	No	Remarks
			during times when pedestrian and animal activity is relatively lower to minimize disturbance.
Potential ecological problems due to increased soil erosion and siltation, leading to decreased stream capacity?		√ 	No such impact is encountered as no precious vegetation is observed within the vicinity of the project area.
Insufficient drainage leading to salinity intrusion?		V	No such impact is envisaged as no movement of saltwater from coastal or marine environments into drain is observed.
Over pumping of ground water, leading to salinization and ground subsidence?		V	Over pumping of groundwater is not required for the construction activities, hence no impact related to salinization and ground subsidence is envisaged.
Impairment of downstream water quality and therefore, impairment of downstream beneficial uses of water?	1		This impact will be temporary and minor level in nature during the construction activities. Following risks are anticipated due to
			 Construction activities will lead to increase erosion and sediment runoff into the drains. The increase in accumulation of sediments in a drains may reduce the carrying capacity of drains and increase its maintenance cost;
			These impacts will be mitigated by avoiding direct discharge of wastewater into water body. Construction materials will be properly covered and stored to prevent runoff of concrete additives and construction waste into the drains. Good housekeeping will further reduce the likelihood and severity of this impact.
Dislocation or involuntary resettlement of people?		V	The construction activities are conducted within the RoW already owned by Irrigation department, hence no dislocation or involuntary resettlement of people are encountered.
Disproportionate impacts on the poor, women and children, Indigenous Peoples or other vulnerable groups?		1	The proposed project doesn't cause any disproportionate impacts on the poor, women and children and other

Sc	reening Questions	Yes	No	Remarks
				vulnerable groups. All of the construction activities are confined within the government land.
•	Potential social conflicts arising from land tenure and land use issues?		1	No land tenure and land use issue are arisen as the project area land is the property of Irrigation department.
•	Soil erosion before compaction and lining of canals?	√ 		Not applicable.
•	Noise from construction equipment?	V		Noise will be produced due to the operation of construction machinery and equipment.
				There are a variety of ways by which construction equipment and worksite noise can be controlled. The following is a list of ways to control noise level at the worksite of the proposed Project: Quieter Equipment Modifying Existing Old Equipment Barrier Protection Work Activity Scheduling Maintenance of machinery
•	Dust during construction?	V		Dust will be produced due to the construction activities. Minor impact of fugitive emission due to construction machinery is also anticipated.
				Temporary windbreaks and barriers such as temporary fences will be installed around the construction site to reduce the spread of dust to nearby residential areas including drains. Dust control measures such as water spraying or dust suppressants will be used to reduce airborne dust particles. Properly tuned vehicles will be used during the construction phase. Regular maintenance and inspection of vehicles must be ensured.
•	Waterlogging and soil salinization due to inadequate drainage and farm management?		V	If the construction activities such as cleaning and Desilting are not carried out without proper disposal of the removed silt or sediment, it can lead to blockages downstream causing

Sc	reening Questions	Yes	No	Remarks
				localized waterlogging and soil salinization.
				These impacts will be mitigated by ensuring proper disposal of sediments and silt removed during Desilting to prevent downstream blockages.
•	Leaching of soil nutrients and changes in soil characteristics due to excessive application of irrigation water?		1	No such impact is envisaged.
•	Reduction of downstream water supply during peak seasons?		V	No such impact is envisaged. As the construction activities may cause temporary impact on drains flow, but it may not be strong enough to reduce the downstream water supply significantly.
•	Soil pollution, polluted farm runoff and groundwater, and public health risks due to excessive application of fertilizers and pesticides?		1	Not applicable as no application of fertilizers and pesticides are involved.
•	Soil erosion (furrow, surface)?	√		 Earthworks for the construction of the bank will disturb the soil which will make the soil more susceptible to erosion. Construction activities and the use of construction machinery at the site will leads to soil erosion.
				Best management practices will be adopted during construction such as limiting soil disturbance, minimizing grading, and using erosion control measures during construction phase. Erosion control measures will be adopted to prevent soil erosion and sediment runoff. Dense vegetation along the banks of the drains will act as a natural barrier and reduce the risk of soil erosion in future.
•	Scouring of canals?		V	Not applicable
•	Clogging of canals by sediments?		V	Not applicable
•	Clogging of canals by weeds? Seawater intrusion into downstream		√ √	Not applicable Not applicable
•	freshwater systems?	,	٧	
•	Introduction of increase in incidence of waterborne or water related diseases?	V		The following impacts of the waterborne and water related disease will be temporary and minor level in nature during restoration work:

Screening Questions	Yes	No	Remarks
			 Health issues/disease (cholera, typhoid, diarrhea, dysentery, etc.) due to unsafe drinking water to worker/staff; Occurrence of water born and vector born disease (malaria, dengue, etc.) due to standing water near workplace.
			Reducing the impacts of vector borne diseases on long-term health effect of workers will be accomplished through implementation of diverse interventions aimed at eliminating the factors that lead to disease, which includes: Prevention of larval and adult propagation of vectors through sanitary improvements and elimination of breeding habitat at site by eliminating any unusable impounding of water.
Dangers to a safe and healthy working environment due to physical, chemical and biological hazards during project construction and operation?			Following risks are anticipated due to proposed project: Slip and trip Fall from height Struck-By and Caught-Between Vector borne diseases Eye and head injuries Noise and dust pollution Health Issues IFC-EHS guidelines (General Guidelines, Elevated and Overhead Work guidelines, Fall Protection guidelines, Control of chemical hazards guidelines) will be followed for Occupational Health and Safety.
Large population influx during project construction and operation that causes increased burden on social infrastructure and services (such as water supply and sanitation systems)		V	Local labor will be hired to minimize the impact on social infrastructure and services.
Social conflicts if workers from other regions or countries are hired?	V		Use of labor from areas other than local area might cause social conflicts which will be mitigated by using local skill (if available) and unskilled labor.
Risks to community health and safety due to the transport, storage, and use and/or disposal of materials such as explosives, fuel, and other chemicals during construction and operation?			Dust and noise generation from construction equipment and activities. This impact will be controlled by using fully tuned equipment and water sprinkling.

Screening Questions	Yes	No	Remarks
			Timely public notification on planned construction works, site barricading will reduce the community health and safety impacts. • The transport, storage and disposal of construction waste leads to air pollution and can create breeding ground for mosquitoes and other pests, increasing the risk of vector-borne diseases such as malaria and dengue. This impact will be mitigated by: • Covering construction waste during transport to prevent dust emissions and air pollution. • Safe disposal of construction waste in designated areas away from drains and residential areas need to be ensured. • Prevention of larval and adult propagation of vectors through sanitary improvements and avoiding the breeding habitat by eliminating any unusable impounding of water.
Community safety risks due to both accidental and natural hazards, especially where the structural elements or components of the project (e.g. irrigation dams) are accessible to members of the affected community or where the failure could result in injury to the community throughout project construction, operation and decommissioning?	V		 Communicable disease associated with the influx of temporary construction labor which will be reduced by implementing Worker Code of Conduct, ensure minimum to no interaction of workers with local community, health awareness initiatives; immunization program and providing health service; Failure/ Collapse of bank during operation stage due to emergency situation such as flood/earthquake. this impact will be mitigated by: A regular inspection and maintenance program will be ensured to identify and address any potential vulnerabilities or issues that could affect the disty during a flood; Flood warning systems must be ensured which will provide timely information about rising water levels or impending flood events. Work during construction as well as travelling during operation will be halted during such

Screening Questions	Yes	No	Remarks
			 emergencies; and Comprehensive emergency response plans in compliance with PDMA specific to the flood events will be developed and updated regularly; Communicable disease associated with the influx of temporary construction labor which will be reduced by implementing Worker Code of Conduct, ensure minimum to no interaction of workers with local community, health awareness initiatives; immunization program and providing health service. Trainings will be given to construction workers, alongside the implementation of strict measures and punishments in case of any child abuse, drug/substance abuse and SEA/SH.

Climate Change and Disaster Risk Questions The following questions are not for environmental categorization. They are included in this checklist to help identify potential climate and disaster risks.	Yes	No	The project area is prope to fleeb fleeds
Is the Project area subject to hazards such as earthquakes, floods, landslides, tropical cyclone winds, storm surges, tsunami or volcanic eruptions and climate changes?			The project area is prone to flash floods as it has already been affected by recent flood of 2022. Emergency response plan developed by PDMA specific to the flood events will be considered to mitigate the impact of these floods during construction activities. Reduce the work hours of workers during extreme hot environment and heat waves. Construction work will be started and planned considering the weather forecast and special attention will be required for monsoon season.
■ Could changes in temperature, precipitation, or extreme events patterns over the Project lifespan affect technical or financial sustainability (e.g., increased erosion or landslides could increase maintenance costs, permafrost melting or increased soil moisture content could affect sub-grade).	~		Yes, the increased precipitation rates or extreme events may affect the sustainability in terms of increased soil moisture and erosion subject to increased maintenance and associated cost. The design considerations with respect to recent extreme floods and climate change aspect will reduce the severity of this impact to negligible level.
• Are there any demographic or socio- economic aspects of the Project area that are already vulnerable (e.g., high incidence of marginalized populations, rural-urban migrants, illegal settlements, ethnic minorities, women or children)?		V	No such vulnerable demographic or socio-economic aspects are present in the vicinity or near the project area.
■ Could the Project potentially increase the climate or disaster vulnerability of the surrounding area (e.g., by encouraging settlement in areas that will be more affected by floods in the future, or encouraging settlement in earthquake zones)?		V	No, the proposed project doesn't increase the climate or disaster vulnerability of the surrounding area as it involves the restoration of irrigation channels.

Note: Hazards are potentially damaging physical events.

Assigned Proposed Category: As per the ADB SPS 2009 and criteria defined in ESMF of EFAP project, the subproject lies in Category C.

Justification:

Package 3 involves Repair/Rehabilitation of Drains and Canals/Distributaries, Paharpur Irrigation Division DI Khan. This package includes thirty schemes/subprojects. The construction work for Rehabilitation/Repair of Drains involves removal of Sakranda growth, Desilting, transportation of construction material, brick side protection and bank rising. The severity of

expected E&S impacts is low. Some of the minimal impacts like occupational health and safety concerns, air and noise disturbance, child labor, GBV, SEA/SH are anticipated but will be mitigated via engineering as well as administrative controls and measures as stated above. An ESMP will be prepared for the proposed package, which will be implemented during the construction of the proposed sub-projects for the environmental and social compliance in accordance with Local regulations and ADB SPS 2009.

Signatures:

ANNEXURE: RAPID ENVIRONMENTAL ASSESSMENT (REA) CHECKLIST

Instructions:

- (i) The project team completes this checklist to support the environmental classification of a project. It is to be attached to the environmental categorization form and submitted to the Safeguard Division (SDSS), for endorsement by the Director, SDSS and for approval by the Chief Compliance Officer.
- (ii) This checklist focuses on environmental issues and concerns. To ensure that social dimensions are adequately considered, refer also to ADB's: (a) checklists on involuntary resettlement and Indigenous peoples; (b) poverty reduction handbook; (c) staff guide to consultation and participation; and (d) gender checklists.
- (iii) Answer the questions assuming the "without mitigation" case. The purpose is to identify potential impacts. Use the "remarks" section to discuss any anticipated mitigation measures.

Country/ Project Title

Pakistan, Khyber Pakhtunkhwa, Emergency Flood Assistance Project (EFAP)

Package 3: Repair/Rehabilitation of Canals/Distributaries, Paharpur Irrigation Division DI Khan (For detail of work Refer Section 1)

Sector Division

Irrigation Sector, Central and West Asia Department (CWRD), Pakistan

#

Project Brief

Package involves Repair/Rehabilitation of Drains Canal/Distributaries, Paharpur Irrigation Division DI Khan. This package includes thirty schemes/subprojects among which seventeen (17) are related to the rehabilitation of canals/distributaries. The overview of the proposed package is provided in Table 1.1. This Package falls in DI Khan Irrigation Circle (south region). The construction work involves the Transportation of construction material, Restoration of distributary prism by brick side protection, Restoration of distributary lining, Construction of retaining walls, distributary bank restoration and Rehabilitation of patrol banks and culverts. All works are confined within existing Right of Way (ROW) of Irrigation department and there is no protected and notified cultural site within or near the vicinity of the project area. Few environmental and social impacts are anticipated which are temporary, short-term and localized limited to the construction phase and are primarily related to soil erosion, noise, and air (dust) emissions, solid waste generation and disposal of wastewater, occupational and community health and safety.

Screening Questions	Yes	No	Remarks
C. Project Siting			
Is the project area adjacent to or within any			
of the following environmentally sensitive			
areas?		,	
Cultural heritage site			No cultural heritage site is noted or
		,	reported within the project area.
Protected Area			No notified protected area falls adjacent
		,	to or within the project area.
Wetland		√	There is no notified wetland near the project area.
Mangrove		$\sqrt{}$	There are no mangrove trees or forests
			located near to or in the vicinity of the
			project area.
Estuarine		$\sqrt{}$	There is no estuarine environment or
			an estuary located along the project
			area
Buffer zone of protected area		√	There is no notified buffer zone of the
			protected area falls inside or near
			vicinity of project area.
Special area for protecting			There is no notified special area for
biodiversity			protecting biodiversity near the project
			area
D. Potential Environmental Impacts Will the project cause			
Loss of precious ecological values (e.g.		$\sqrt{}$	No precious ecological values are
result of encroachment into			situated within or near the vicinity of the
forests/swamplands or historical /cultural			project area. Hence no such impact is
buildings/areas, disruption of hydrology of natural waterways, regional flooding,			envisaged.
and drainage hazards)?			
Conflicts in water supply rights and	V		There might be pressure on the
related social conflicts;			drinking water source due to the
			construction workers/staff.
			This impact will be mitigated by:
			Avoid use of community water
			supply sources to reduce the social
			conflicts; Contractor will ensure the
			Contractor will ensure the availability of drinking water
			(preferably potable water) at site.
Impediments to movements of people	V		The rehabilitation of patrol roads and
and animals?			banks may cause temporary hindrance
			to the pedestrian and animals crossing.
			Temporary alternative routes will be
			identified and established for the
			pedestrians and animals to cross the
			distributaries.
			Construction activities will be properly
			planned and working on one section of

Screening Questions	Yes	No	Remarks
			a distributary at a time will be prioritized to allow other sections to remain accessible for crossing. Construction activities will be scheduled during times when pedestrian and animal activity is relatively lower to minimize disturbance.
Potential ecological problems due to increased soil erosion and siltation, leading to decreased stream capacity?		1	No such impact is encountered as no precious vegetation is observed within the vicinity of the project area.
Insufficient drainage leading to salinity intrusion?		√ ./	Not applicable as there is no anticipated impact on the drainage
Over pumping of ground water, leading to salinization and ground subsidence?		√	Over pumping of groundwater is not required for the construction activities, hence no impact related to salinization and ground subsidence is envisaged.
Impairment of downstream water quality and therefore, impairment of downstream beneficial uses of water?			This impact will be temporary and minor level in nature during the construction activities. Following risks are anticipated due to proposed project: Construction activities will lead to increase erosion and sediment runoff into the distributary. The increase in accumulation of sediments in a distributary may reduce the carrying capacity of distributary and increase its maintenance cost; Increase sediment runoff will increase the turbidity of water, making it unfit for potable purposes; These impacts will be mitigated by avoiding direct discharge of wastewater into water body. Construction materials will be properly covered and stored to prevent runoff of concrete additives and construction waste into the distributaries. Good housekeeping will further reduce the likelihood and severity of this impact.
Dislocation or involuntary resettlement of people?		V	The construction activities are conducted within the RoW already owned by Irrigation department, hence no dislocation or involuntary

Sc	reening Questions	Yes	No	Remarks
				resettlement of people are
	Diamenarianata imposts on the near		V	encountered. The proposed project doesn't cause
•	Disproportionate impacts on the poor, women and children, Indigenous Peoples or other vulnerable groups?		V	any disproportionate impacts on the poor, women and children and other vulnerable groups. All of the construction activities are confined within the government land.
•	Potential social conflicts arising from land tenure and land use issues?		V	No land tenure and land use issue are arisen as the project area land is the property of Irrigation department.
•	Soil erosion before compaction and lining of canals?	V		During construction activities, soil disturbance can expose loose soil that is susceptible to erosion.
				This impact can be mitigated by adopting best management practices during construction which includes limiting earthmoving and minimizing soil disturbance.
•	Noise from construction equipment?	V		Noise will be produced due to the operation of construction machinery and equipment.
				There are a variety of ways by which construction equipment and worksite noise can be controlled. The following is a list of ways to control noise level at the worksite of the proposed Project: Quieter Equipment Modifying Existing Old Equipment Barrier Protection Work Activity Scheduling Maintenance of machinery
•	Dust during construction?	V		Dust will be produced due to the construction activities. Minor impact of fugitive emission due to construction machinery is also anticipated.
				Temporary windbreaks and barriers such as temporary fences will be installed around the construction site to reduce the spread of dust to nearby residential areas including distributary. Dust control measures such as water spraying or dust suppressants will be used to reduce airborne dust particles. Properly tuned vehicles will be used during the construction phase. Regular

Screening Questions	Yes	No	Remarks
			maintenance and inspection of vehicles will be ensured.
Waterlogging and soil salinization due to inadequate drainage and farm management?		V	Not applicable as the proposed project involves rehabilitation works of distributaries which doesn't cause any impact on waterlogging and soil salinization.
Leaching of soil nutrients and changes in soil characteristics due to excessive application of irrigation water?		1	No such impact is envisaged.
Reduction of downstream water supply during peak seasons?		√	No such impact is envisaged. As the construction activities may cause temporary impact on distributaries flow, but it may not be strong enough to reduce the downstream water supply significantly.
Soil pollution, polluted farm runoff and groundwater, and public health risks due to excessive application of fertilizers and pesticides?		1	Not applicable as no application of fertilizers and pesticides are involved.
Soil erosion (furrow, surface)?	V		 Earthworks for the construction of the bank will disturb the soil which will make the soil more susceptible to erosion. Construction activities and the use of construction machinery at the site will leads to soil erosion. The distributary is continuously accessed by the livestock for drinking and bathing. Their repeated entry from the distributary edges are leading to bank destabilization, which causes the edges to collapse and erosion of the soil.
			Best management practices will be adopted during construction such as limiting soil disturbance, minimizing grading, and using erosion control measures during construction phase. Cordon off the designated area along the distributary as livestock exclusion zones to prevent direct access to the water. Erosion control measures will be adopted to prevent soil erosion and sediment runoff. Dense vegetation along the banks of the distributary will act as a natural barrier and reduce the risk of soil erosion in future.
Scouring of canals?	V		During construction, the slopes of the distributary may be unstable due to loose soil or lack of proper compaction,

Scr	eening Questions	Yes	No	Remarks
				making them susceptible to erosion and scouring.
				To mitigate this impact, the contractor is identifying the weak slope areas along the distributary and avoiding the movement of vehicle as well as machinery along such areas.
•	Clogging of canals by sediments?	V		Construction activities will lead to increase erosion and sediment runoff into the distributary. The increase in accumulation of sediments in a distributary will reduce the carrying capacity of distributary and ultimately leads to clogging of distributary. Construction materials will be properly
				covered and stored to prevent runoff of construction material and waste into the distributary. The stabilization of exposed soil areas will be ensured during the construction activities by using slope stabilization methods
•	Clogging of canals by weeds?		√ 	This impact is not envisaged as the construction activities will be carried out to remove the weeds from the distributaries, which ultimately prevents clogging of canals and distributaries.
•	Seawater intrusion into downstream freshwater systems?		√ √	No such impact is encountered as no marine, sea is present near the vicinity of the proposed project, hence no sea water intrusion into the distributaries and canals are observed.
•	Introduction of increase in incidence of waterborne or water related diseases?	V		The following impacts of the waterborne and water related disease will be temporary and minor level in nature during restoration work of:
				 Health issues/disease (cholera, typhoid, diarrhea, dysentery, etc.) due to unsafe drinking water to worker/staff; Occurrence of water born and vector born disease (malaria, dengue, etc.) due to standing water near workplace.
				Reducing the impacts of vector borne diseases on long-term health effect of workers will be accomplished through implementation of diverse interventions

Screening Questions	Yes	No	Remarks
			aimed at eliminating the factors that lead to disease, which includes: Prevention of larval and adult propagation of vectors through sanitary improvements and elimination of breeding habitat at site by eliminating any unusable impounding of water.
Dangers to a safe and healthy working environment due to physical, chemical and biological hazards during project construction and operation?	V		Following risks are anticipated due to proposed project: Slip and trip Fall from height Struck-By and Caught-Between Vector borne diseases Eye and head injuries Noise and dust pollution Health Issues IFC-EHS guidelines (General Guidelines, Elevated and Overhead Work guidelines, Fall Protection guidelines, Control of chemical hazards guidelines) will be followed for Occupational Health and Safety.
Large population influx during project construction and operation that causes increased burden on social infrastructure and services (such as water supply and sanitation systems)		V	Local labor will be hired to minimize the impact on social infrastructure and services.
Social conflicts if workers from other regions or countries are hired?	V		Use of labor from areas other than local area might cause social conflicts which will be mitigated by using local skill (if available) and unskilled labor.
Risks to community health and safety due to the transport, storage, and use and/or disposal of materials such as explosives, fuel, and other chemicals during construction and operation?	V		Dust and noise generation from construction equipment and activities. This impact will be controlled by using fully tuned equipment and water sprinkling. Timely public notification on planned construction works, site barricading will reduce the community health and safety impacts. The transport, storage and disposal of construction waste leads to air pollution and can create breeding ground for mosquitoes and other pests, increasing the risk of vector-borne diseases such as malaria and dengue.

Screening Questions	Yes	No	Remarks
			This impact will be mitigated by: Covering construction waste during transport to prevent dust emissions and air pollution. Safe disposal of construction waste in designated areas away from disty and residential areas need to be ensured. Prevention of larval and adult propagation of vectors through sanitary improvements and avoiding the breeding habitat by eliminating any unusable impounding of water.
Community safety risks due to both accidental and natural hazards, especially where the structural elements or components of the project (e.g. irrigation dams) are accessible to members of the affected community or where the failure could result in injury to the community throughout project construction, operation and decommissioning?	V		 Communicable disease associated with the influx of temporary construction labor which will be reduced by implementing Worker Code of Conduct, ensure minimum to no interaction of workers with local community, health awareness initiatives; immunization program and providing health service; Failure/ Collapse of bank during operation stage due to emergency situation such as flood/earthquake. this impact will be mitigated by: A regular inspection and maintenance program will be ensured to identify and address any potential vulnerabilities or issues that could affect the disty during a flood; Flood warning systems must be ensured which will provide timely information about rising water levels or impending flood events. Work during construction as well as travelling during operation will be halted during such emergencies; and Comprehensive emergency response plans in compliance with PDMA specific to the flood events will be developed and updated regularly; Communicable disease associated with the influx of temporary construction labor which will be reduced by implementing Worker Code of Conduct, ensure minimum to no interaction of workers with local

Screening Questions	Yes	No	Remarks
			community, health awareness initiatives; immunization program and providing health service. Trainings will be given to construction workers, alongside the implementation of strict measures and punishments in case of any child abuse, drug/substance abuse and SEA/SH.

Climate Change and Disaster Risk Questions The following questions are not for environmental categorization. They are included in this checklist to help identify potential climate and disaster risks.	Yes	No	REMARKS The project area is prone to flash floods
Is the Project area subject to hazards such as earthquakes, floods, landslides, tropical cyclone winds, storm surges, tsunami or volcanic eruptions and climate changes?	V		as it has already been affected by recent flood of 2022. Emergency response plan developed by PDMA specific to the flood events will be considered to mitigate the impact of these floods during construction activities. Reduce the work hours of workers during extreme hot environment and heat waves. Construction work will be started and planned considering the weather forecast and special attention will be required for monsoon season.
■ Could changes in temperature, precipitation, or extreme events patterns over the Project lifespan affect technical or financial sustainability (e.g., increased erosion or landslides could increase maintenance costs, permafrost melting or increased soil moisture content could affect sub-grade).	V		Yes, the increased precipitation rates or extreme events may affect the sustainability in terms of increased soil moisture and erosion subject to increased maintenance and associated cost. The design considerations with respect to recent extreme floods and climate change aspect will reduce the severity of this impact to negligible level.
• Are there any demographic or socio- economic aspects of the Project area that are already vulnerable (e.g., high incidence of marginalized populations, rural-urban migrants, illegal settlements, ethnic minorities, women or children)?		V	No such vulnerable demographic or socio-economic aspects are present in the vicinity or near the project area.
■ Could the Project potentially increase the climate or disaster vulnerability of the surrounding area (e.g., by encouraging settlement in areas that will be more affected by floods in the future, or encouraging settlement in earthquake zones)?		V	No, the proposed project doesn't increase the climate or disaster vulnerability of the surrounding area as it involves the restoration of irrigation channels.

Note: Hazards are potentially damaging physical events.

Assigned Proposed Category: As per the ADB SPS 2009 and criteria defined in ESMF of EFAP project, the subproject lies in Category C.

Justification:

Package 3 involves Repair/Rehabilitation of Drains and Canals/Distributaries, Paharpur Irrigation Division DI Khan. This package includes thirty schemes/subprojects. The construction work involves the Transportation of construction material, Restoration of distributary prism by brick side protection, Restoration of distributary lining, Construction of retaining walls,

distributary bank restoration and Rehabilitation of patrol banks and culverts. The severity of expected E&S impacts is low. Some of the minimal impacts like occupational health and safety concerns, air and noise disturbance, child labor, GBV, SEA/SH are anticipated but will be mitigated via engineering as well as administrative controls and measures as stated above. An ESMP will be prepared for the proposed package, which will be implemented during the construction of the proposed sub-projects for the environmental and social compliance in accordance with Local regulations and ADB SPS 2009.

Signatures:

INVOLUNTARY RESETTLEMENT IMPACT CATEGORIZATION

Date: 22-09-2023

			Date: 22-09-2023	
A. Instructions (i) The project team completes and subm (ii) The classification of a project is a cont change, the Sector Division submits a ner reference. (iii) In addition, the project team may prop Director. HCS projects are a subset of ca and generally interrelated potential social	tinuing process. If there is a chang w form and requests for recategor cose in the comments section that tegory A projects that ADB deems	e in the project components and/o ization, and approval by OSPT Dir the project is highly complex and	or site that may result in category rector. The old form is attached for sensitive (HCS), for approval by OSPT	
B. Project Data				
Country/Project No./Project Title	: Pakistan, Khyber Pakh	ntunkhwa, Emergency Flood As	ssistance Project (EFAP)	
		of Drains Paharpur Irrigation D		
Department/ Division Processing Stage	: Central and West Asia	Department (CWRD), Pakista	<u>n</u>	
Modality	:			
[] Project Loan	oan []Financial Interme [✓]Emergency Assi []Other financir	stance [] Grant	rporate Finance	
C. Involuntary Resettlement Categ	ory			
[✓] New	[] Recategorization — Pre	evious Category []		
□ Category A	□ Category B	Category B ⊠ Category C □ Catego		
D. Comments				
Project Team Comments:		OSFG Comments:		
E. Approval				
Proposed by:		Reviewed by:		
Project Team Leader, (CWRD, Pakis Date:	itan)	Social Development Special Date:	alist (Safeguards), OSFG	
Social Development Specialist, (CWI Date:	RD, Pakistan)			
Endorsed by:		Approved by:	Highly Complex and	
Director, (CWRD, Pakistan)		Bruce Dunn, Director, OSF		
Date:		Date:	Project	

¹For Results-Based Lending (RBL) modality, please refer to the <u>Staff Instruction on Business Processes for RBL for Programs</u> issued on 17 March 2021. The <u>supplemental checklist</u> needs to be submitted to OSPT for confirmation of eligible activities under the RBL program by OSPT Director.

Involuntary Resettlement Impact Categorization Checklist

Probable Involuntary Resettlement Effects	Yes	No	Not Known	Remarks
Involuntary Acquisition of Land				
1. Will there be land acquisition?		\ \ \ \ \ \ \ \ \ \ \ \ \ \ \ \ \ \ \		No land acquisition and resettlement is involved as the rehabilitation/repair of drains will be carried out within the existing ROW owned by Irrigation department.
2. Is the site for land acquisition known?		√		Not Applicable as no land acquisition is involved in the respective rehabilitation work.
3. Is the ownership status and current usage of land to be acquired known?		√		Same as above
4. Will easement be utilized within an existing Right of Way (ROW)?		√		No easement will be disturbed
5. Will there be loss of shelter and residential land due to land acquisition?		√		No loss of shelter is involved.
6. Will there be loss of agricultural and other productive assets due to land acquisition?		√		No loss of agricultural and other productive assets as no land acquisition is involved.
7. Will there be losses of crops, trees, and fixed assets due to land acquisition?		√		No loss of crops, trees, and fixed assets as no land acquisition is involved
8. Will there be loss of businesses or enterprises due to land acquisition?		√		No loss of businesses or enterprises as no land acquisition is involved.
9. Will there be loss of income sources and means of livelihoods due to land acquisition?		√		No loss of income sources and means of livelihoods as no land acquisition is involved
Involuntary restrictions on land use or on access to le	egally d	esignat	ed parks a	and protected areas
10. Will people lose access to natural resources, communal facilities, and services?		✓		There will be no impact on such resources and services as the rehabilitation work will be carried out in the existing ROW.
11. If land use is changed, will it have an adverse impact on social and economic activities?		✓		No change is occurred in existing land use.
12. Will access to land and resources owned communally or by the state be restricted?		✓		There will be no restriction on such resources as the rehabilitation works will be carried out within existing ROW owned by Irrigation Department. Therefore, no impact is envisaged on the current land use.
Information on Displaced Persons:	1	1	1	1
Any estimate of the likely number of persons that will be of likely numbers of	displaced	d by the	Project?	[∕] No [] Yes
Are any of them poor, female-heads of households, or vul Are any displaced persons from indigenous or ethnic mine			rty risks?	[/] No [] Yes [/] No [] Yes

Note: The project team may attach additional information on the project, as necessary.

INDIGENOUS PEOPLES IMPACT CATEGORIZATION

Date: 22-09-2023

A. Instructions							
(ii) The classification of a project is							
ii) The project team indicates if the project requires broad community support (BCS) of Indigenous Peoples communities. BCS is required when roject activities involve: (a) commercial development of the cultural resources and knowledge of indigenous peoples; (b) physical displacement from raditional or customary lands; and (c) commercial development of natural resources within customary lands under use that would impact the velihoods or the cultural, ceremonial, or spiritual use that define the identity and community of indigenous peoples. v) In addition, the project team may propose in the comments section that the project is highly complex and sensitive (HCS), for approval by OSPT Director. HCS projects are a subset of category A projects that ADB deems to be highly risky or contentious or involve serious and multidimensional and generally interrelated potential social and/or environmental impacts.							
B. Project Data							
Country/Project No./Project T	itle : Pakistan, Khyber F	Pakhtunkhwa, Emergency Floo	d Assistance Project (EFAP)				
		air of Drains Paharpur Irrigation					
Department/ Division	: Central and West A	Asia Department (CWRD), Pal	kistan				
Processing Stage Modality	: <u> </u>		-				
	[√] Eme		neral Corporate Finance ant				
C. Indigenous Peoples Cate		i ilitarioling modalities					
[∕] New	[] Recategorization	— Previous Category []					
☐ Category A	☐ Category B	☑ Category C	☐ Category FI				
D. Project requires the broa affected Indigenous Peor		[] Yes	[] No				
E. Comments							
Project Team Comments:		OSFG Comments:					
F. Approval							
Proposed by:		Reviewed by:					
Project Team Leader, (CWRD, Pa Date:	akistan)	Social Development Specialis Date:	t (Safeguards), OSFG				
Social Development Specialist, (CDate:	WRD, Pakistan)						
Endorsed by:		Approved by:	Highly Complex and Sensitive Project				
Director, (CWRD, Pakistan) Date:		Bruce Dunn, Director, OSFG Date:					

² For Results-Based Lending (RBL) modality, please refer to the <u>Staff Instruction on Business Processes for RBL for Programs</u> issued on 17 March 2021. The <u>supplemental checklist</u> needs to be submitted to OSPT for confirmation of eligible activities under the RBL program by OSPT Director.

Indigenous Peoples Impact Screening Checklist

KEY CONCERNS (Please provide elaborations on the Remarks column)	YES	NO	NOT KNOWN	Remarks
A. Indigenous Peoples Identification				
Are there socio-cultural groups present in or use the project area who may be considered as "tribes" (hill tribes, schedules tribes, tribal peoples), "minorities" (ethnic or national minorities), or "indigenous communities" in the project area?		~		As per the definition of ADB SPS 2009 about "indigenous communities" there are no indigenous people in the sub-project area.
2. Are there national or local laws or policies as well as anthropological researches/studies that consider these groups present in or using the project area as belonging to "ethnic minorities", scheduled tribes, tribal peoples, national minorities, or cultural communities?		√		No IPs exist in the sub- project area
3. Do such groups self-identify as being part of a distinct social and cultural group?		✓		Not Applicable
4. Do such groups maintain collective attachments to distinct habitats or ancestral territories and/or to the natural resources in these habitats and territories?		√		Not Applicable
5. Do such groups maintain cultural, economic, social, and political institutions distinct from the dominant society and culture?		√		Not Applicable
6. Do such groups speak a distinct language or dialect?		✓		Not Applicable
7. Has such groups been historically, socially, and economically marginalized, disempowered, excluded, and/or discriminated against?		√		Not Applicable
8. Are such groups represented as "Indigenous Peoples" or as "ethnic minorities" or "scheduled tribes" or "tribal populations" in any formal decision-making bodies at the national or local levels?		√		Not Applicable
B. Identification of Potential Impacts				
Will the project directly or indirectly benefit or target Indigenous Peoples?		✓		Not Applicable as no IPs exists
10. Will the project directly or indirectly affect Indigenous Peoples' traditional socio-cultural and belief practices? (e.g. child-rearing, health, education, arts, and governance)		√		Not Applicable
11. Will the project affect the livelihood systems of Indigenous Peoples? (e.g., food production system, natural resource management, crafts and trade, employment status)		√		Not Applicable
12. Will the project be in an area (land or territory) occupied, owned, or used by Indigenous Peoples, and/or claimed as ancestral domain?		√		Not Applicable
C. Identification of Special Requirements Will the project activities include:				

KEY CONCERNS (Please provide elaborations on the Remarks column)	YES	NO	NOT KNOWN	Remarks
13. Commercial development of the cultural resources and knowledge of Indigenous Peoples?		✓		Not Applicable
14. Physical displacement from traditional or customary lands?		✓		Not Applicable
15. Commercial development of natural resources (such as minerals, hydrocarbons, forests, water, hunting or fishing grounds) within customary lands under use that would impact the livelihoods or the cultural, ceremonial, spiritual uses that define the identity and community of Indigenous Peoples?		✓		Not Applicable
16. Establishing legal recognition of rights to lands and territories that are traditionally owned or customarily used, occupied, or claimed by Indigenous Peoples?		√		Not Applicable
17. Acquisition of lands that are traditionally owned or customarily used, occupied, or claimed by Indigenous Peoples?		√		Not Applicable

D. Anticipated project impacts on Indigenous Peoples

	Project component/ activity/ output	Anticipated positive effect	Anticipated negative effect
1.	Removal of Sakranda growth	N/A	N/A
2.	Desilting	N/A	N/A
3.	Transportation of construction material	N/A	N/A
4.	Side protection	N/A	N/A
5.	Bank rising	N/A	N/A
6.	Stone Pitching	N/A	N/A

Note: The project team may attach additional information on the project, as necessary.

INVOLUNTARY RESETTLEMENT IMPACT CATEGORIZATION

			Date: 22-09-2023
A. Instructions (i) The project team completes and submit (ii) The classification of a project is a control change, the Sector Division submits a new reference. (iii) In addition, the project team may propriector. HCS projects are a subset of call and generally interrelated potential social	cinuing process. If there is a chang w form and requests for recategori cose in the comments section that tegory A projects that ADB deems	e in the project components and/o ization, and approval by OSPT Dir the project is highly complex and s	or site that may result in category ector. The old form is attached for sensitive (HCS), for approval by OSPT
B. Project Data			
Country/Project No./Project Title Department/ Division Processing Stage Modality [] Project Loan [] Program Loan [] Sector Loan [] MFF [] Results-based lending3	Rehabilitation/Repair of Khan Central and West Asia	Department (CWRD), Pakistal diary [] General Col stance [] Grant	our Irrigation Division, District DI
C. Involuntary Resettlement Categ	ory		
[✓] New	[] Recategorization — Pre	evious Category []	T
□ Category A	□ Category B	⊠ Category C	□ Category FI
D. Comments			
Project Team Comments:		OSFG Comments:	
E. Approval			
Proposed by:		Reviewed by:	
Project Team Leader, (CWRD, Pakis Date:	itan)	Social Development Special Date:	llist (Safeguards), OSFG
Social Development Specialist, (CWI) Date:	RD, Pakistan)		
Endorsed by:		Approved by:	Highly Complex and
Director, (CWRD, Pakistan)		Bruce Dunn, Director, OSF	G Sensitive
Date:		Date:	Project

³For Results-Based Lending (RBL) modality, please refer to the <u>Staff Instruction on Business Processes for RBL for Programs</u> issued on 17 March 2021. The <u>supplemental checklist</u> needs to be submitted to OSPT for confirmation of eligible activities under the RBL program by OSPT Director.

Involuntary Resettlement Impact Categorization Checklist

Probable Involuntary Resettlement Effects	Yes	No	Not Known	Remarks		
Involuntary Acquisition of Land		10				
Will there be land acquisition?		\		No land acquisition and resettlement is involved as the rehabilitation/repair of distributaries will be carried out within the existing ROW owned by Irrigation department.		
2. Is the site for land acquisition known?		√		Not Applicable as no land acquisition is involved in the respective rehabilitation work.		
3. Is the ownership status and current usage of land to be acquired known?		√		Same as above		
4. Will easement be utilized within an existing Right of Way (ROW)?		√		No easement will be disturbed		
5. Will there be loss of shelter and residential land due to land acquisition?		✓		No loss of shelter is involved.		
6. Will there be loss of agricultural and other productive assets due to land acquisition?		√		No loss of agricultural and other productive assets as no land acquisition is involved.		
7. Will there be losses of crops, trees, and fixed assets due to land acquisition?		√		No loss of crops, trees, and fixed assets as no land acquisition is involved.		
8. Will there be loss of businesses or enterprises due to land acquisition?		√		No loss of businesses or enterprises as no land acquisition is involved.		
9. Will there be loss of income sources and means of livelihoods due to land acquisition?		✓		No loss of income sources and means of livelihoods as no land acquisition is involved		
Involuntary restrictions on land use or on access to le	gally d	esignat	ed parks a	nd protected areas		
10. Will people lose access to natural resources, communal facilities, and services?		✓		There will be no impact on such resources and services as the rehabilitation work will be carried out within the existing ROW.		
11. If land use is changed, will it have an adverse impact on social and economic activities?		✓		No change is occurred in existing land use.		
12. Will access to land and resources owned communally or by the state be restricted?		✓		There will be no restriction on such resources as the rehabilitation works will be carried out within existing ROW owned by Irrigation Department. Therefore, no impact is envisaged on the current land use.		
Information on Displaced Persons:						
Any estimate of the likely number of persons that will be d If yes, approximately how many?N/A	isplaced	by the	Project?	[✓] No [] Yes		
	Are any of them poor, female-heads of households, or vulnerable to poverty risks? [✓] No [] Yes					

Note: The project team may attach additional information on the project, as necessary.

INDIGENOUS PEOPLES IMPACT CATEGORIZATION

Date: 22-09-2023

A. Instructions							
(ii) The classification of a project is							
The project team indicates if the project requires broad community support (BCS) of Indigenous Peoples communities. BCS is required when project activities involve: (a) commercial development of the cultural resources and knowledge of indigenous peoples; (b) physical displacement from raditional or customary lands; and (c) commercial development of natural resources within customary lands under use that would impact the velihoods or the cultural, ceremonial, or spiritual use that define the identity and community of indigenous peoples. (v) In addition, the project team may propose in the comments section that the project is highly complex and sensitive (HCS), for approval by OSPT Director. HCS projects are a subset of category A projects that ADB deems to be highly risky or contentious or involve serious and multidimensional and generally interrelated potential social and/or environmental impacts.							
B. Project Data	olar ana/or onvironmental impacto.						
Country/Project No./Project	Γitle : Pakistan, Khyber F	Pakhtunkhwa, Emergency Floc	d Assistance Project (EFAP)				
	District DI Khan	air of Canals/Distributaries Pa					
Department/ Division	: Central and West A	Asia Department (CWRD), Pak	kistan				
Processing Stage	<u> </u>						
Modality : [] Project Loan [] Program Loan [] Financial Intermediary [] General Corporate Finance							
[] Sector Loan		,	ant				
[] Results-based lending ⁴ [] Other financing modalities							
C. Indigenous Peoples Cate	gory						
[√] New	Recategorization	— Previous Category []					
☐ Category A	☐ Category B	☑ Category C	□ Category FI				
D. Project requires the broa affected Indigenous Peo		[] Yes	[] No				
E. Comments							
Project Team Comments:		OSFG Comments:					
F. Approval							
Proposed by:		Reviewed by:					
Project Team Leader, (CWRD, Polate:	akistan)	Social Development Specialis Date:	t (Safeguards), OSFG				
Social Development Specialist, (CWRD, Pakistan) Date:							
Endorsed by:		Approved by:	Highly Complex and Sensitive Project				
Director, (CWRD, Pakistan)		Bruce Dunn, Director, OSFG	-				
Date:		Date:					

⁴ For Results-Based Lending (RBL) modality, please refer to the <u>Staff Instruction on Business Processes for RBL for Programs</u> issued on 17 March 2021. The <u>supplemental checklist</u> needs to be submitted to OSPT for confirmation of eligible activities under the RBL program by OSPT Director.

Indigenous Peoples Impact Screening Checklist

KEY CONCERNS (Please provide elaborations on the Remarks column)	YES	NO	NOT KNOWN	Remarks
B. Indigenous Peoples Identification				
Are there socio-cultural groups present in or use the project area who may be considered as "tribes" (hill tribes, schedules tribes, tribal peoples), "minorities" (ethnic or national minorities), or "indigenous communities" in the project area?		~		As per the definition of ADB SPS 2009 about "indigenous communities" there are no indigenous people in the sub-project area.
2. Are there national or local laws or policies as well as anthropological researches/studies that consider these groups present in or using the project area as belonging to "ethnic minorities", scheduled tribes, tribal peoples, national minorities, or cultural communities?		√		No IPs exist in the sub- project area
3. Do such groups self-identify as being part of a distinct social and cultural group?		✓		Not Applicable
4. Do such groups maintain collective attachments to distinct habitats or ancestral territories and/or to the natural resources in these habitats and territories?		√		Not Applicable
5. Do such groups maintain cultural, economic, social, and political institutions distinct from the dominant society and culture?		✓		Not Applicable
6. Do such groups speak a distinct language or dialect?		✓		Not Applicable
7. Has such groups been historically, socially, and economically marginalized, disempowered, excluded, and/or discriminated against?		√		Not Applicable
8. Are such groups represented as "Indigenous Peoples" or as "ethnic minorities" or "scheduled tribes" or "tribal populations" in any formal decision-making bodies at the national or local levels?		√		Not Applicable
B. Identification of Potential Impacts				
Will the project directly or indirectly benefit or target Indigenous Peoples?		✓		Not Applicable as no IPs exists
10. Will the project directly or indirectly affect Indigenous Peoples' traditional socio-cultural and belief practices? (e.g. child-rearing, health, education, arts, and governance)		√		Not Applicable
11. Will the project affect the livelihood systems of Indigenous Peoples? (e.g., food production system, natural resource management, crafts and trade, employment status)		✓		Not Applicable
12. Will the project be in an area (land or territory) occupied, owned, or used by Indigenous Peoples, and/or claimed as ancestral domain?		✓		Not Applicable
C. Identification of Special Requirements Will the project activities include:				

KEY CONCERNS (Please provide elaborations on the Remarks column)	YES	NO	NOT KNOWN	Remarks
13. Commercial development of the cultural resources and knowledge of Indigenous Peoples?		✓		Not Applicable
14. Physical displacement from traditional or customary lands?		✓		Not Applicable
15. Commercial development of natural resources (such as minerals, hydrocarbons, forests, water, hunting or fishing grounds) within customary lands under use that would impact the livelihoods or the cultural, ceremonial, spiritual uses that define the identity and community of Indigenous Peoples?		√		Not Applicable
16. Establishing legal recognition of rights to lands and territories that are traditionally owned or customarily used, occupied, or claimed by Indigenous Peoples?		√		Not Applicable
17. Acquisition of lands that are traditionally owned or customarily used, occupied, or claimed by Indigenous Peoples?		√		Not Applicable

D. Anticipated project impacts on Indigenous Peoples

Project component/ activity/ output	Anticipated positive effect	Anticipated negative effect
1. Transportation of construction material	N/A	N/A
Restoration of distributary prism by brick side protection	N/A	N/A
3. Restoration of distributary lining	N/A	N/A
Construction of retaining walls	N/A	N/A
5. Distributary bank restoration	N/A	N/A
Rehabilitation of patrol banks and culverts	N/A	N/A

Note: The project team may attach additional information on the project, as necessary.

PHOTOLOG





Rehabilitation of Katgarh Branch Drain No. 03





Rehabilitation of Katgarh Branch Drain No. 04





Rehabilitation of damaged / washed away Drains Section of Largi Drain No2





Rehabilitation of damaged / washed away Drains Section of Largi Drain No1





Rehabilitation of damaged / washed away Drains Section of Seed Farm Branch Drain





Rehabilitation of damaged / washed away Drains Section of Bund Kurai Branch Drain





Rehabilitation of damaged / washed away Drains Section of Bund Kurai Main Drain





Rehabilitation of damaged / washed away Drains Section of Main Drain





Rehabilitation of damaged / washed away Drains Section of Girsal Drain





Rehabilitation of damaged / washed away Drains Section of Girsal Pond Drain





Rehabilitation of damaged / washed away Drains Section of Jabbarwala Drain





Rehabilitation of damaged / washed away Drains Section of Ketch Drain



Dera Ismail Khan, Khyber Pakhtunkhwa, Pak Unnamed Road, Dera Ismail Khan, Khyber Pakhtunkhwa, Pakistan Lat 31.63306° Long 70.698402° 04/06/23 04:03 PM GMT +05:00

Rehabilitation of damaged / washed away Drains Section of Bilot Creek Drain





Rehabilitation of damaged/washed away Canal Section of Civil Minor





Rehabilitation of damaged/washed away Canal Section of Shah Kot Minor





Rehabilitation of damaged/washed away Canal Section of Shah Kot Feeder






Rehabilitation of damaged/washed away Canal Section of Paharpur disty





Rehabilitation of damaged/washed away Canal Section of Old Paharpur canal (RD. 130000-160000)



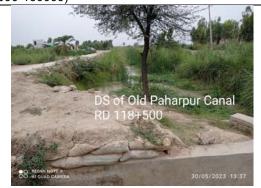

Rehabilitation of damaged/washed away Canal Section of Old Paharpur canal (RD. 118+500-122+300)





Rehabilitation of damaged/washed away Canal Section of Ketch Minor





Rehabilitation of damaged/washed away Canal Section of Kat Garh Minor





Rehabilitation of damaged/washed away Canal Section of Girsal Feeder

PACKAGE-3: EFAP/KPID/CW-03: REHABILITATION OF CANALS AND DRAINS, DISTRICT DI KHAN – PAHARPUR IRRIGATION DIVISION



EMERGENCY FLOOD ASSISTANCE PROJECT (EFAP) - KP "RECONSTRUCTION AND REHABILITATION OF IRRIGATION AND DRAINAGE SYSTEM AND FLOOD PROTECTIONWORKS IN KHYBER PAKHTUNKHWA"

ADB LOAN NO. 4279 PAK (COL)

FINAL DRAWIINGS (EFAP/KPID-CW-03)

REHABILITATION OF CANALS AND DRAINS IN PAHARPUR IRRIGATION DIVISION, DERA ISMAIL KHAN

OCTOBER 2023
















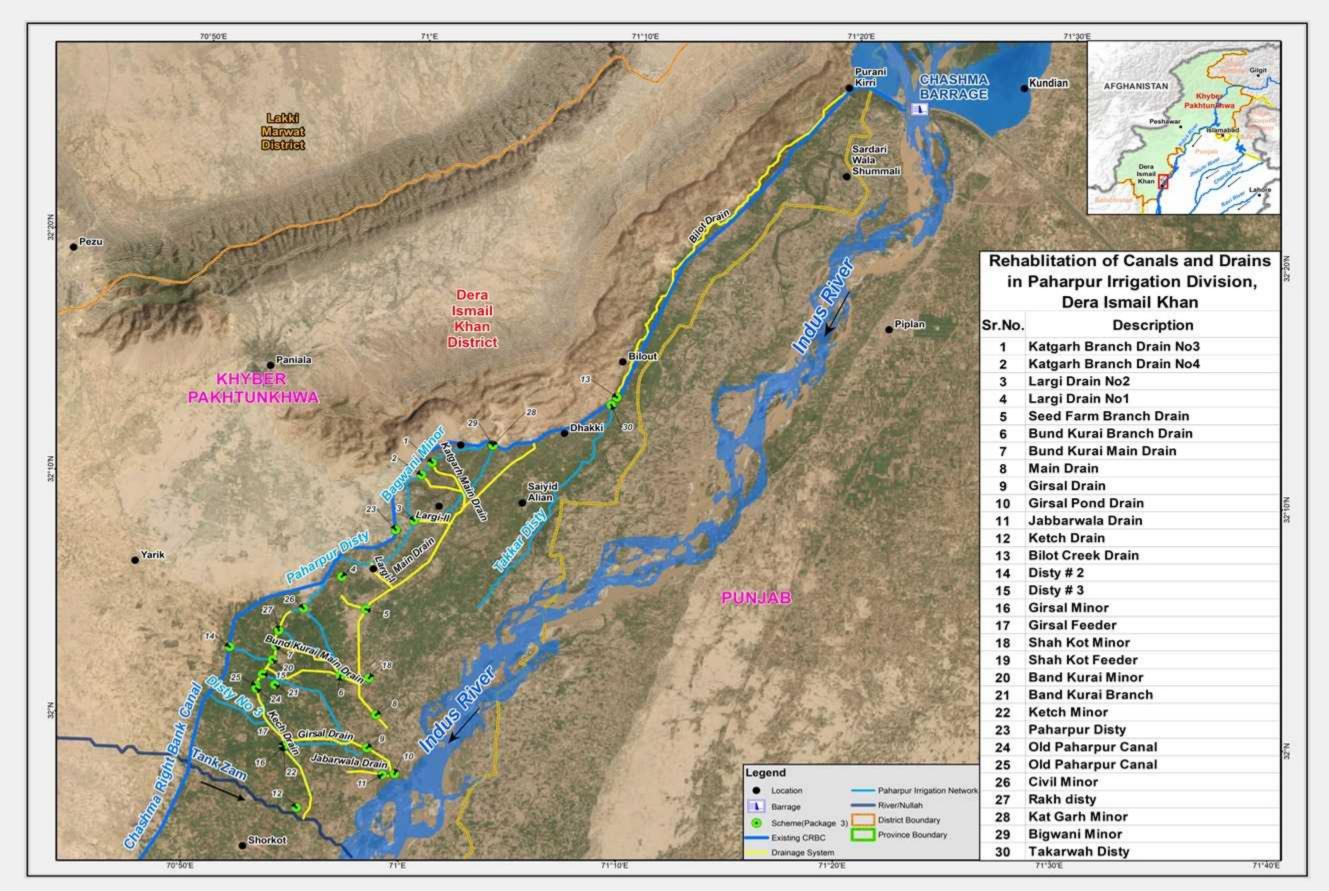

REHABILITATION WORKS OF DRAINS IN PAHARPUR IRRIGATION DIVISION DERA ISMAIL KHAN

LOCATION MAPS & TABLE OF DETAILS O F DRAINS 24 23 22 21 20 19 18 17 16 15 14

TABLE OF DIMENSIONS OF KETCH DRAIN

LOCATION MAP OF BILOT CREEK DRAIN

4593/TD/061

/LM-13

4593/TD/061 4593/TD/061

/TOD-12

4593/TD/061

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4593/TD/061 4593/TD/061

/TOD-11

L/LM-11 L/TOD-10

L/LM-12

LOCATION MAP OF KETCH DRAIN

TABLE OF DIMENSIONS OF JABBARWALA DRAIN

LOCATION MAP OF JABBARWALA DRAIN

TABLE OF DIMENSIONS OF GIRSAL POND DRAIN

TABLE OF DIMENSIONS OF BILOT CREEK DRAIN

12 11

10 9 ∞

13

TABLE OF DIMENSIONS OF BUND KURAI MAIN DRAIN

OCATION MAP OF BUND KURAI MAIN DRAIN

TABLE OF DIMENSIONS OF BUND KURAI BRANCH DRAIN

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4593/TD/061

L/LM-05

4593/TD/061

/TOD-05

4593/TD/061 4593/TD/061

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L/LM-04

TABLE OF DIMENSIONS OF SEED FARM BRANCH DRAIN

LOCATION MAP OF BUND KURAI BRANCH DRAIN

TABLE OF DIMENSIONS OF LARGAI DRAIN NO.1

OCATION MAP OF LARGAI DRAIN NO.1

LOCATION MAP OF SEED FARM BRANCH DRAIN

LOCATION MAP OF MAIN DRAIN

TABLE OF DIMENSIONS OF MAIN DRAIN

TABLE OF DIMENSIONS OF GIRSAL DRAIN

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4593/TD/061

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4593/TD/061

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4593/TD/061

OCATION MAP OF GIRSAL DRAIN

LOCATION MAP OF GIRSAL POND DRAIN

SR. NO.

5

6

TABLE OF DIMENSIONS OF LARGAI DRAIN NO.2

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4593/TD/061

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4593/TD/061

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LOCATION MAP OF LARGAI DRAIN NO.2

4

TABLE OF DIMENSIONS OF KATGARH BRANCH DRAIN NO.4

TABLE OF DIMENSIONS OF KATGARH BRANCH DRAIN NO.3

LOCATION MAP OF KATGARH BRANCH DRAIN NO.3

LIST OF LOCATION MAPS AND TODS FOR PROPOSED REHABILITATION WORKS OF DRAIN

DRAWING TITLE

LOT-1 DRAINS IN PAHARPUR IRRIGATION DIVISION DERA ISMAIL KHAN

LOCATION MAP OF KATGARH BRANCH DRAIN NO.4

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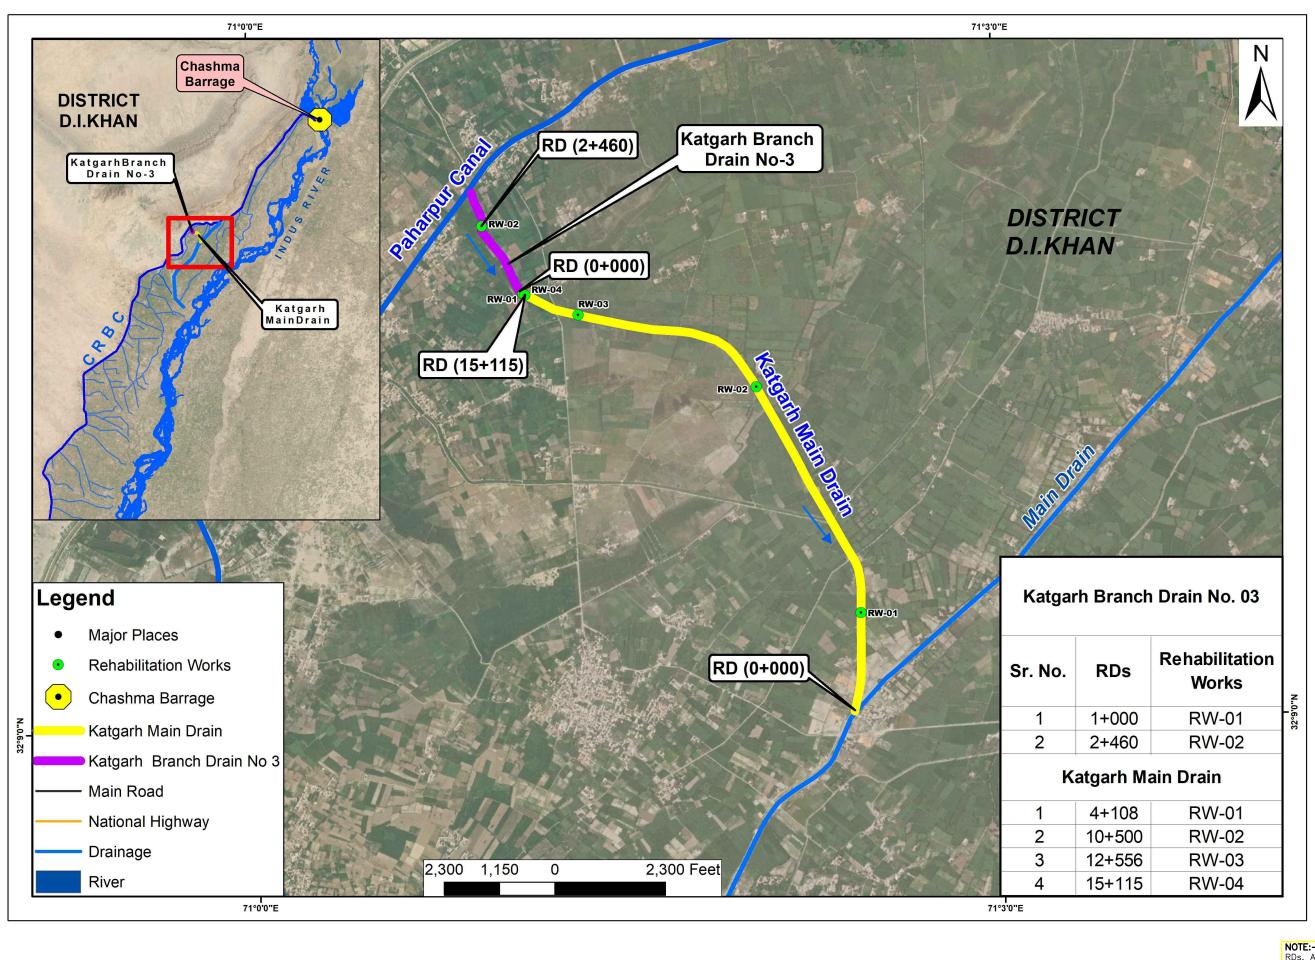
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NATIONAL ENGINEERING SERVICES PAKISTAN (PVT) HEAD OFFICE : NESPAK HOUSE, 1—C BLOCK N, MODEL TOWN EXTENSION, LAHORE PAKISTAN

LIST OF LOCATION MAPS AND TODS OF DRAINS

DATE AUG 2023 4593/TD/061/GN-01



EMERGENCY FLOOD ASSISTANCE PROJECT (EFAP)-KP "RECONSTRUCTION AND REHABILITATION OF **IRRIGATION AND DRAINAGE SYSTEM AND FLOOD** PROTECTION WORKS IN KHYBER PAKHUNKHWA"

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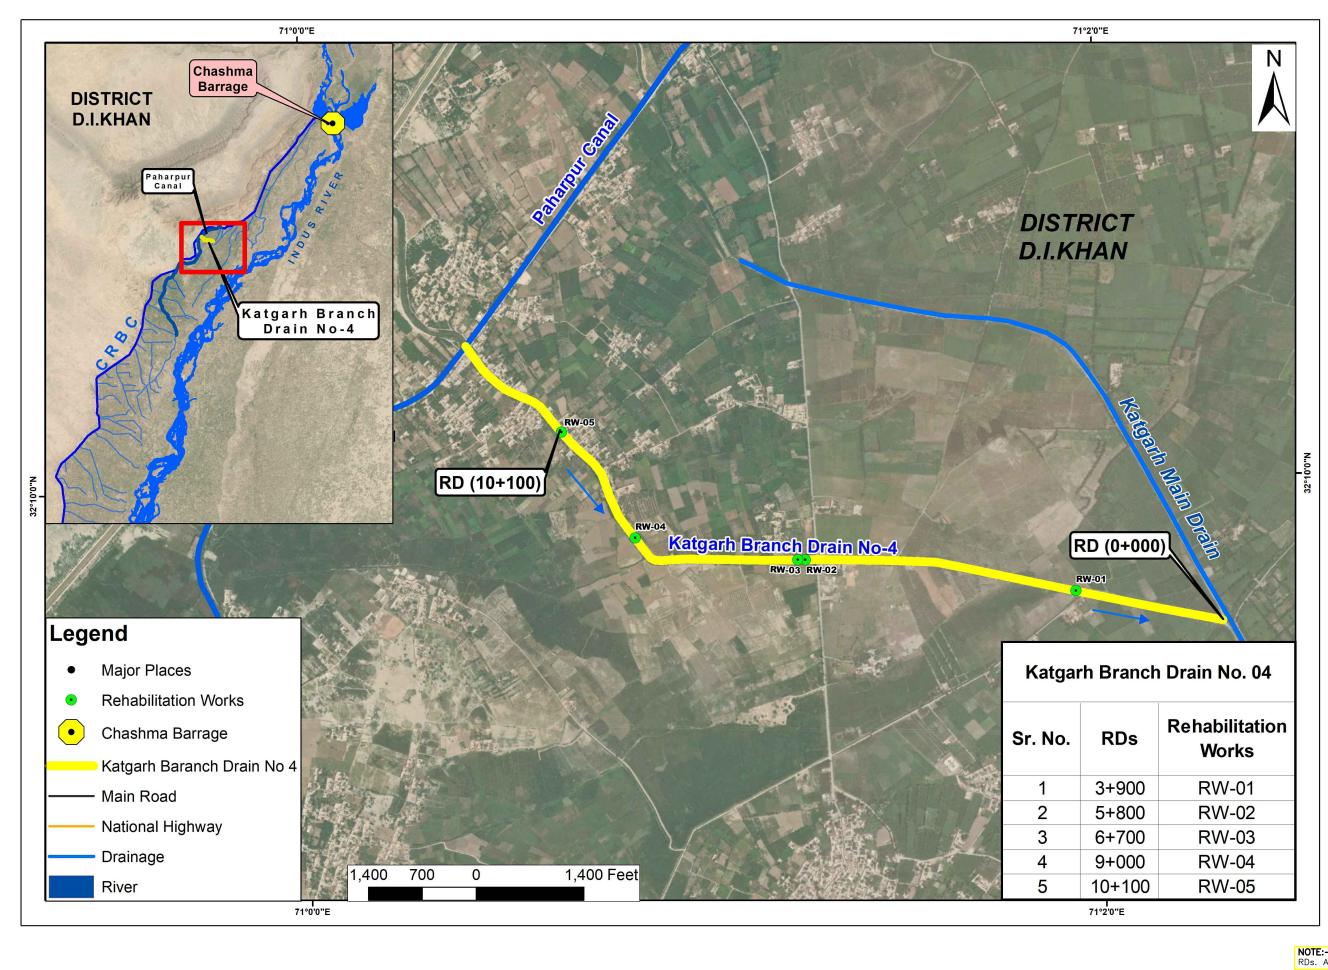
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NATIONAL ENGINEERING SERVICES PAKISTAN (PVT)

LOCATION MAP FOR REHABILITATION OF DAMAGED / WASHED AWAY DRAINS SECTION OF KATGARH BRANCH DRAIN NO-3

HEAD OFFICE: NESPAK HOUSE, 1-C BLOCK N, MODEL TOWN EXTENSION, LAHORE PAKISTAN

DRAWING NO. OCT, 2023



EMERGENCY FLOOD ASSISTANCE PROJECT (EFAP)-KP
"RECONSTRUCTION AND REHABILITATION OF
IRRIGATION AND DRAINAGE SYSTEM AND FLOOD
PROTECTION WORKS IN KHYBER PAKHUNKHWA"

GOVERNMENT OF KHYBER
PAKHTUNKHWA
IRRIGATION DEPARTMENT


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NATIONAL ENGINEERING SERVICES PAKISTAN (PVT)

LOCATION MAP FOR REHABILITATION OF DAMAGED / WASHED AWAY DRAINS SECTION OF KATGARH BRANCH DRAIN NO-4

HEAD OFFICE : NESPAK HOUSE, 1-C BLOCK N, MODEL TOWN EXTENSION, LAHORE PAKISTAN TE. DRAWING NO. 4593/T

wing no. 4593/TD/061/LM-02

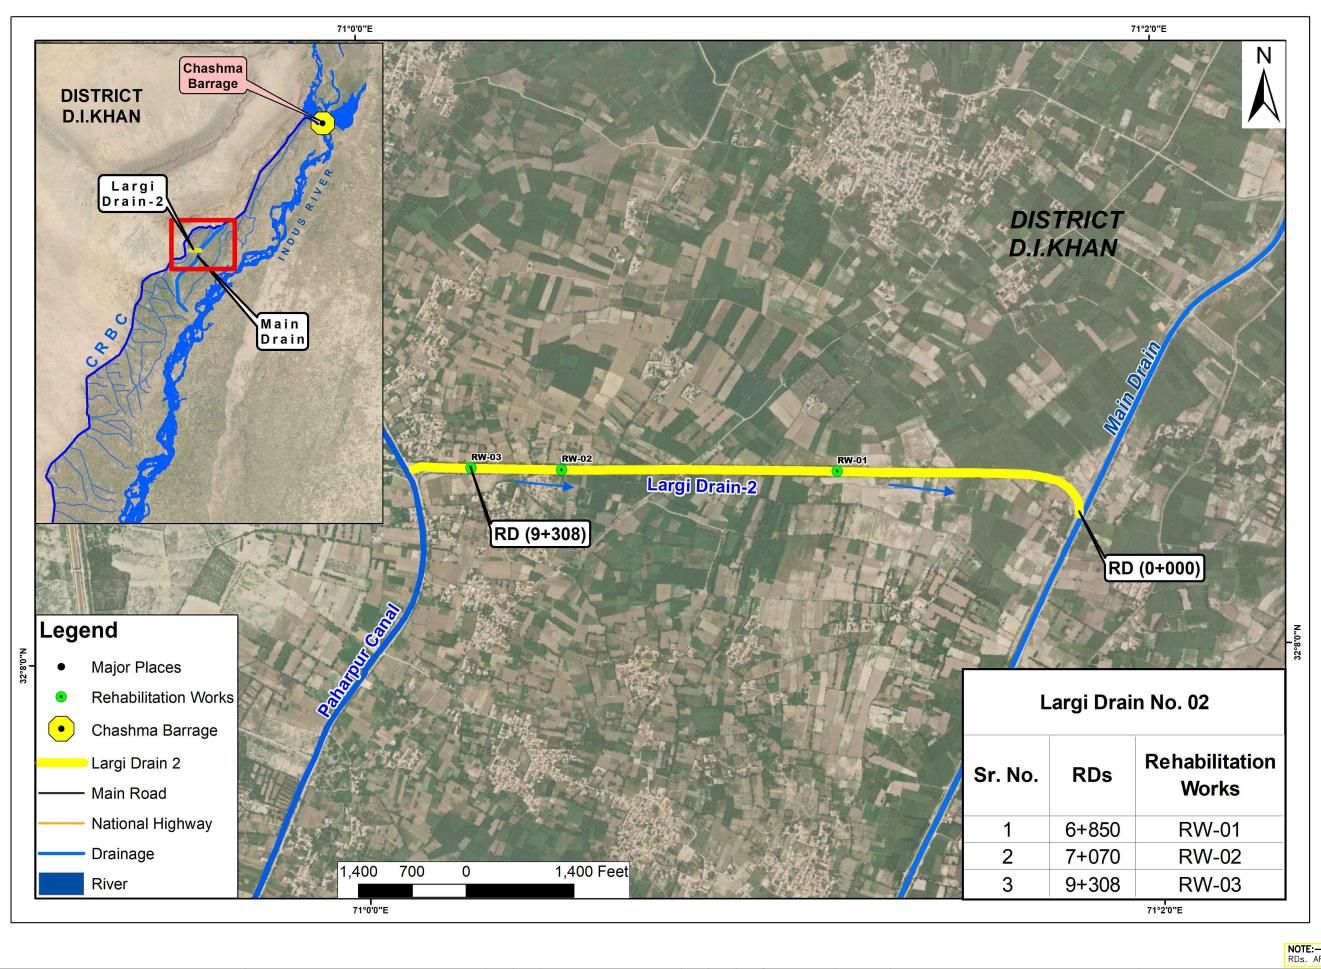

EMERGENCY FLOOD ASSISTANCE PROJECT (EFAP)-KP "RECONSTRUCTION AND REHABILITATION OF IRRIGATION AND DRAINAGE SYSTEM AND FLOOD PROTECTION WORKS IN KHYBER PAKHUNKHWA"


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						RECOMMENDED	Q.L
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REV.	DATE	DESCRIPTION	BY	CKD.	APPR.	APPROVED	N.A

NATIONAL ENGINEERING SERVICES PAKISTAN (PVT) LIMITED

LOCATION MAP FOR REHABILITATION OF DAMAGED / WASHED AWAY DRAINS SECTION OF LARGI DRAIN NO-2

HEAD OFFICE: NESPAK HOUSE, 1-C BLOCK N, MODEL TOWN EXTENSION, LAHORE PAKISTAN DRAWING NO.

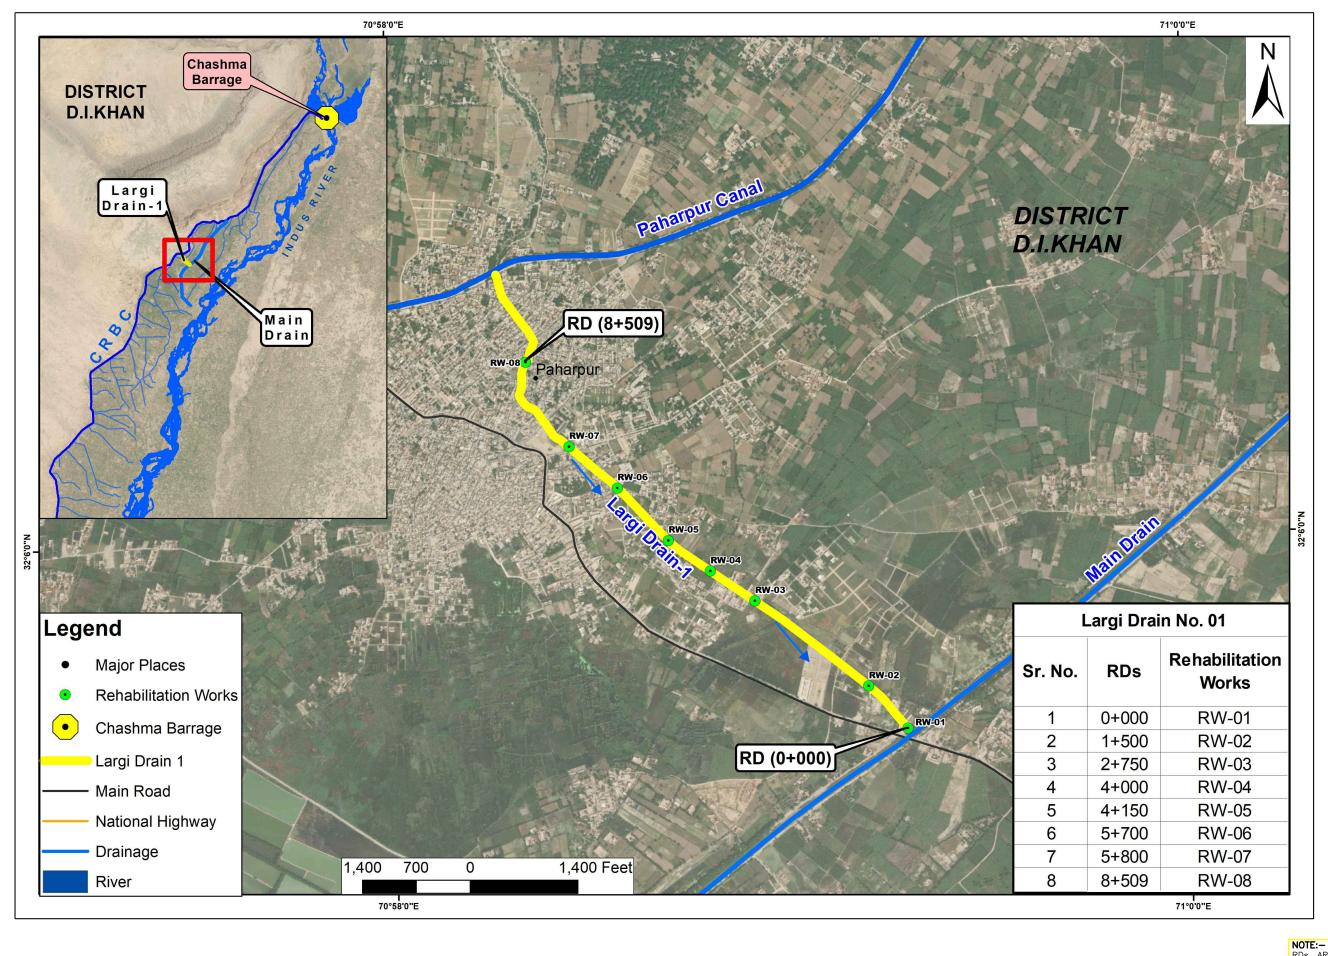

EMERGENCY FLOOD ASSISTANCE PROJECT (EFAP)-KP
"RECONSTRUCTION AND REHABILITATION OF
IRRIGATION AND DRAINAGE SYSTEM AND FLOOD
PROTECTION WORKS IN KHYBER PAKHUNKHWA"



GOVERNMENT OF KHYBER
PAKHTUNKHWA
IRRIGATION DEPARTMENT


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LOCATION MAP FOR REHABILITATION OF DAMAGED / WASHED AWAY DRAINS SECTION OF LARGI DRAIN NO-1

HEAD OFFICE : NESPAK HOUSE, 1-C BLOCK N,
MODEL TOWN EXTENSION, LAHORE PAKISTAN

E. DRAWING NO.



EMERGENCY FLOOD ASSISTANCE PROJECT (EFAP)-KP "RECONSTRUCTION AND REHABILITATION OF IRRIGATION AND DRAINAGE SYSTEM AND FLOOD PROTECTION WORKS IN KHYBER PAKHUNKHWA"
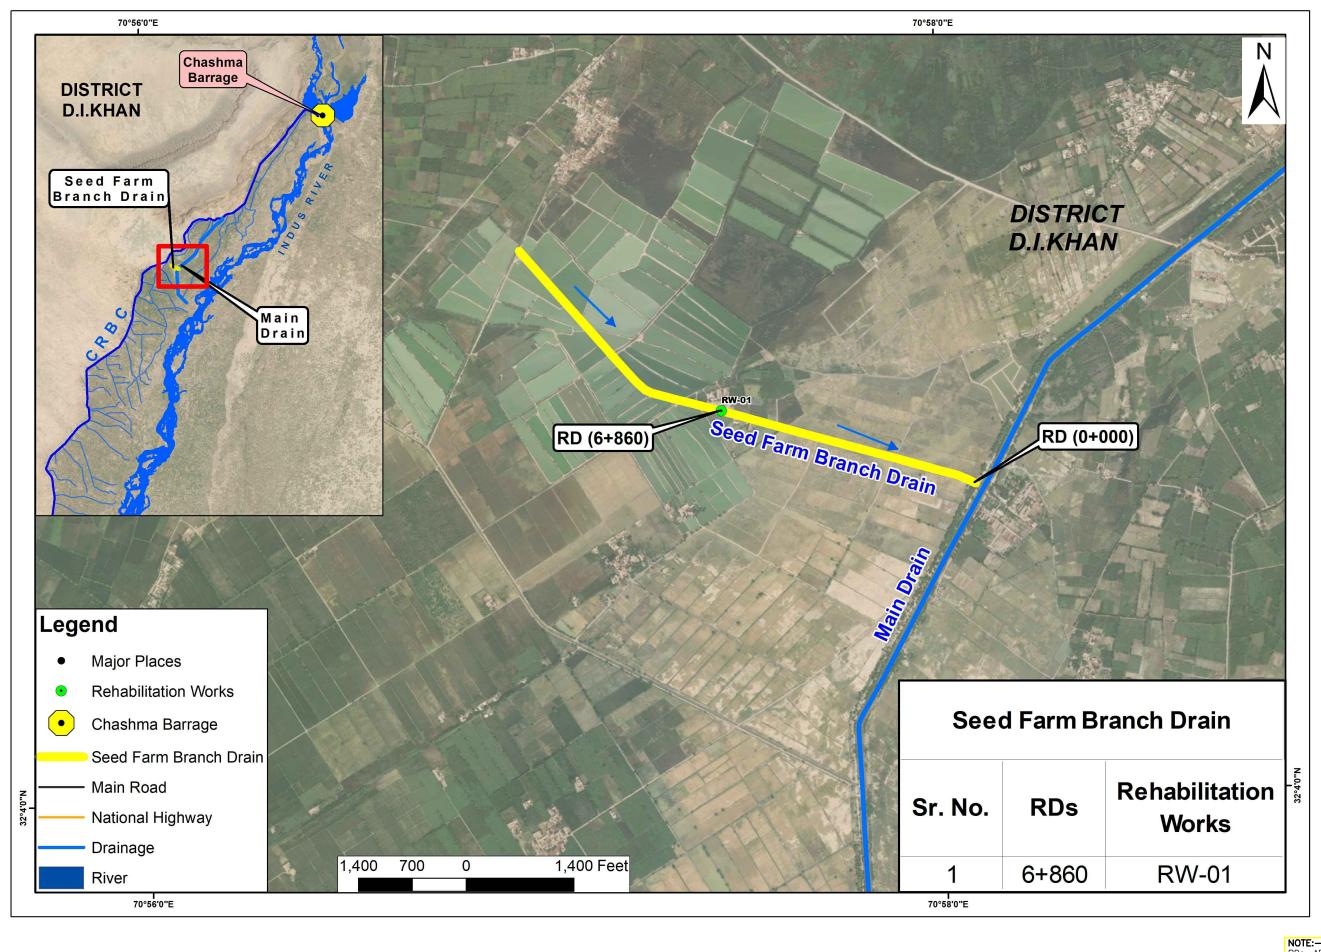
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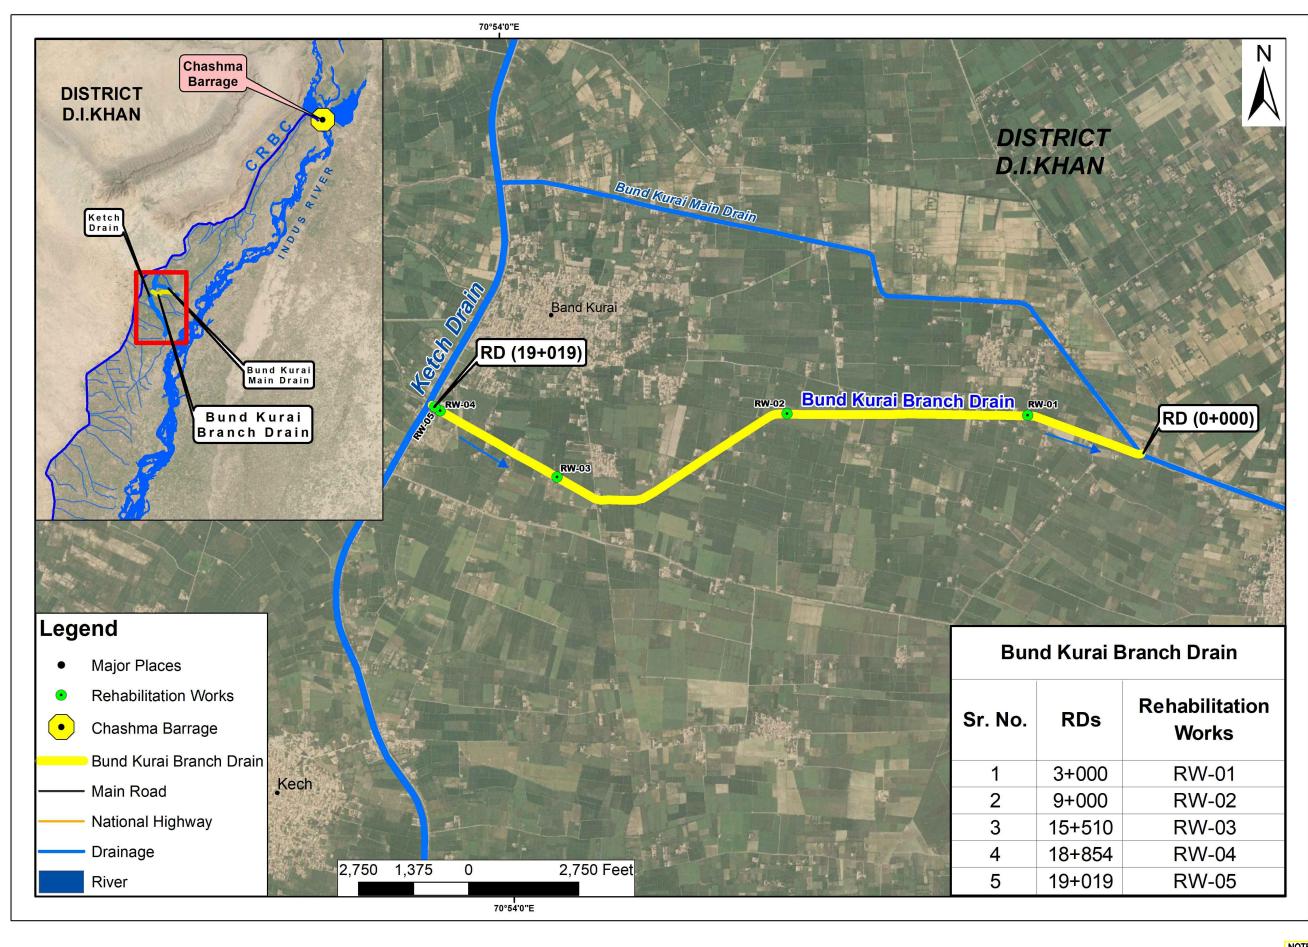
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	REV.	DATE	DESCRIPTION	BY	CKD.	APPR.	APPROVED	N.A



LOCATION MAP FOR REHABILITATION OF DAMAGED / WASHED AWAY DRAINS SECTION OF SEED FARM BRANCH DRAIN

HEAD OFFICE: NESPAK HOUSE, 1-C BLOCK N, MODEL TOWN EXTENSION, LAHORE PAKISTAN OCT, 2023

DRAWING NO.



EMERGENCY FLOOD ASSISTANCE PROJECT (EFAP)-KP
"RECONSTRUCTION AND REHABILITATION OF
IRRIGATION AND DRAINAGE SYSTEM AND FLOOD
PROTECTION WORKS IN KHYBER PAKHUNKHWA"




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LOCATION MAP FOR REHABILITATION OF DAMAGED / WASHED AWAY DRAINS SECTION OF BUND KURAI BRANCH DRAIN

HEAD OFFICE : NESPAK HOUSE, 1-C BLOCK N, MODEL TOWN EXTENSION, LAHORE PAKISTAN DRAWING NO. 4593/T



EMERGENCY FLOOD ASSISTANCE PROJECT (EFAP)-KP
"RECONSTRUCTION AND REHABILITATION OF
IRRIGATION AND DRAINAGE SYSTEM AND FLOOD
PROTECTION WORKS IN KHYBER PAKHUNKHWA"

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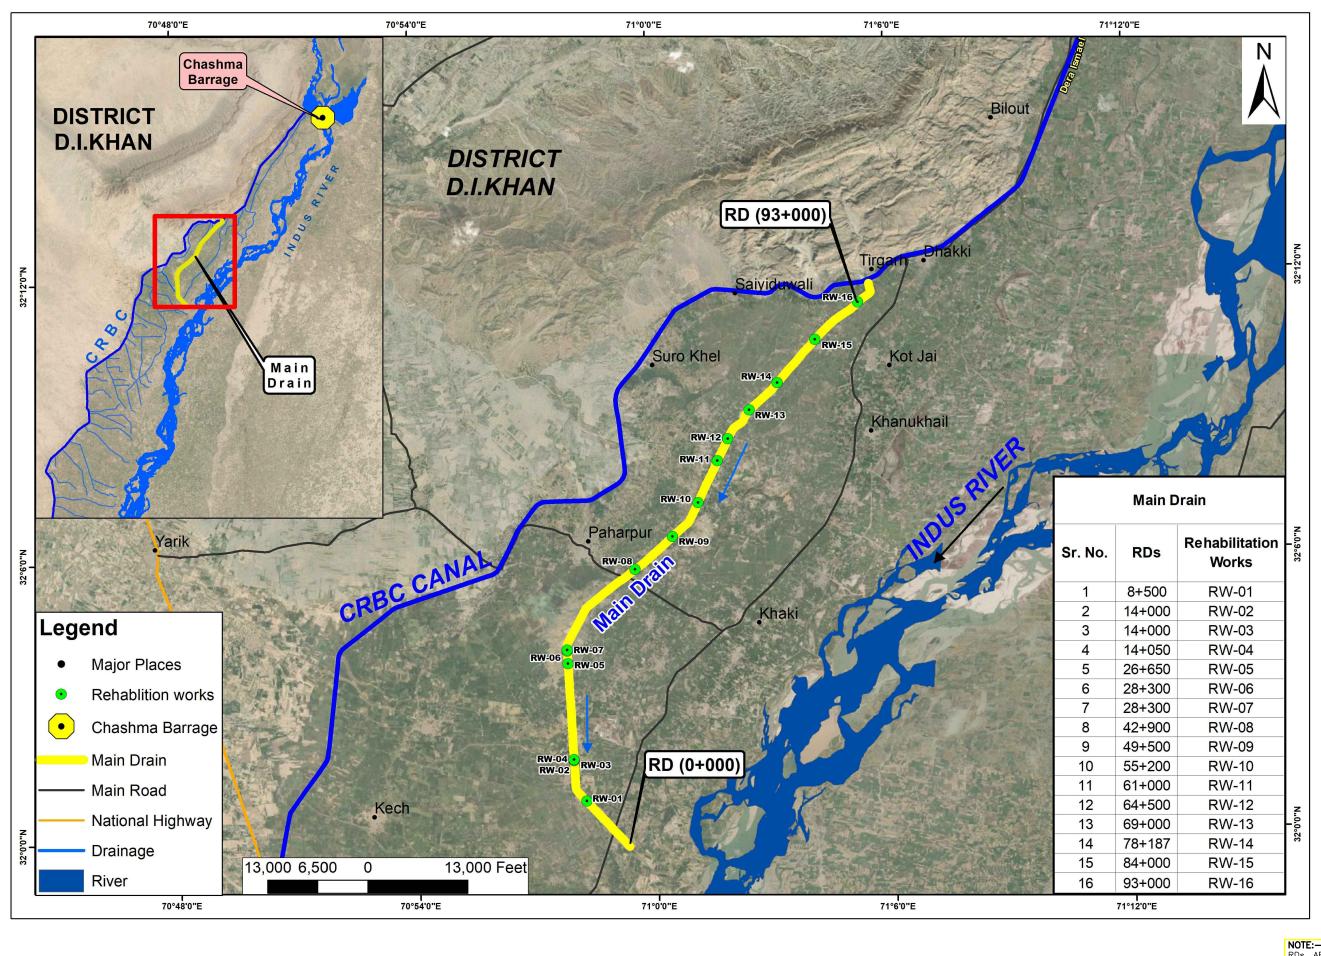
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IRRIGATION DEPARTMENT
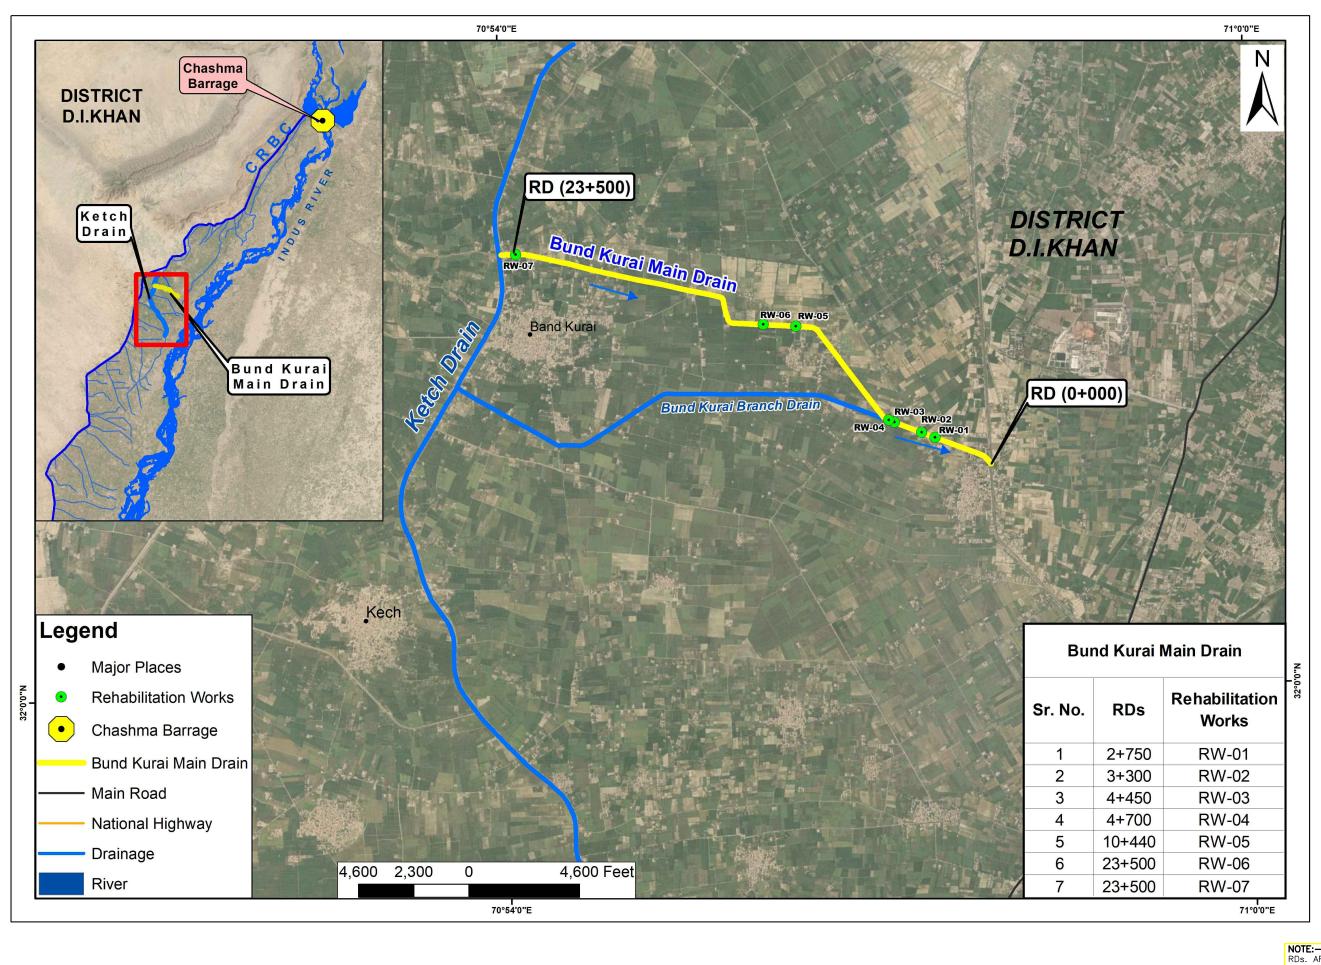
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NATIONAL ENGINEERING SERVICES PAKISTAN (PVT) LIMITED LOCATION MAP FOR REHABILITATION OF DAMAGED / WASHED AWAY DRAINS SECTION OF BUND KURAI MAIN DRAIN

HEAD OFFICE : NESPAK HOUSE, 1-C BLOCK N, MODEL TOWN EXTENSION, LAHORE PAKISTAN DATE. DRAWING NO. 4593/T

DRAWING NO. 4593/TD/061/LM-07



EMERGENCY FLOOD ASSISTANCE PROJECT (EFAP)-KP "RECONSTRUCTION AND REHABILITATION OF **IRRIGATION AND DRAINAGE SYSTEM AND FLOOD** PROTECTION WORKS IN KHYBER PAKHUNKHWA"

GOVERNMENT OF PAKHTUNKH **IRRIGATION DEPA**


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ARTMENT							CHD/VER	F.R.K
	REV.	DATE	DESCRIPTION	BY	CKD.	APPR.	APPROVED	N.A



HEAD OFFICE: NESPAK HOUSE, 1-C BLOCK N, MODEL TOWN EXTENSION, LAHORE PAKISTAN LOCATION MAP FOR REHABILITATION OF DAMAGED / WASHED AWAY DRAINS SECTION OF MAIN DRAIN

DRAWING NO. DATE.

4593/TD/061/LM-08 OCT, 2023

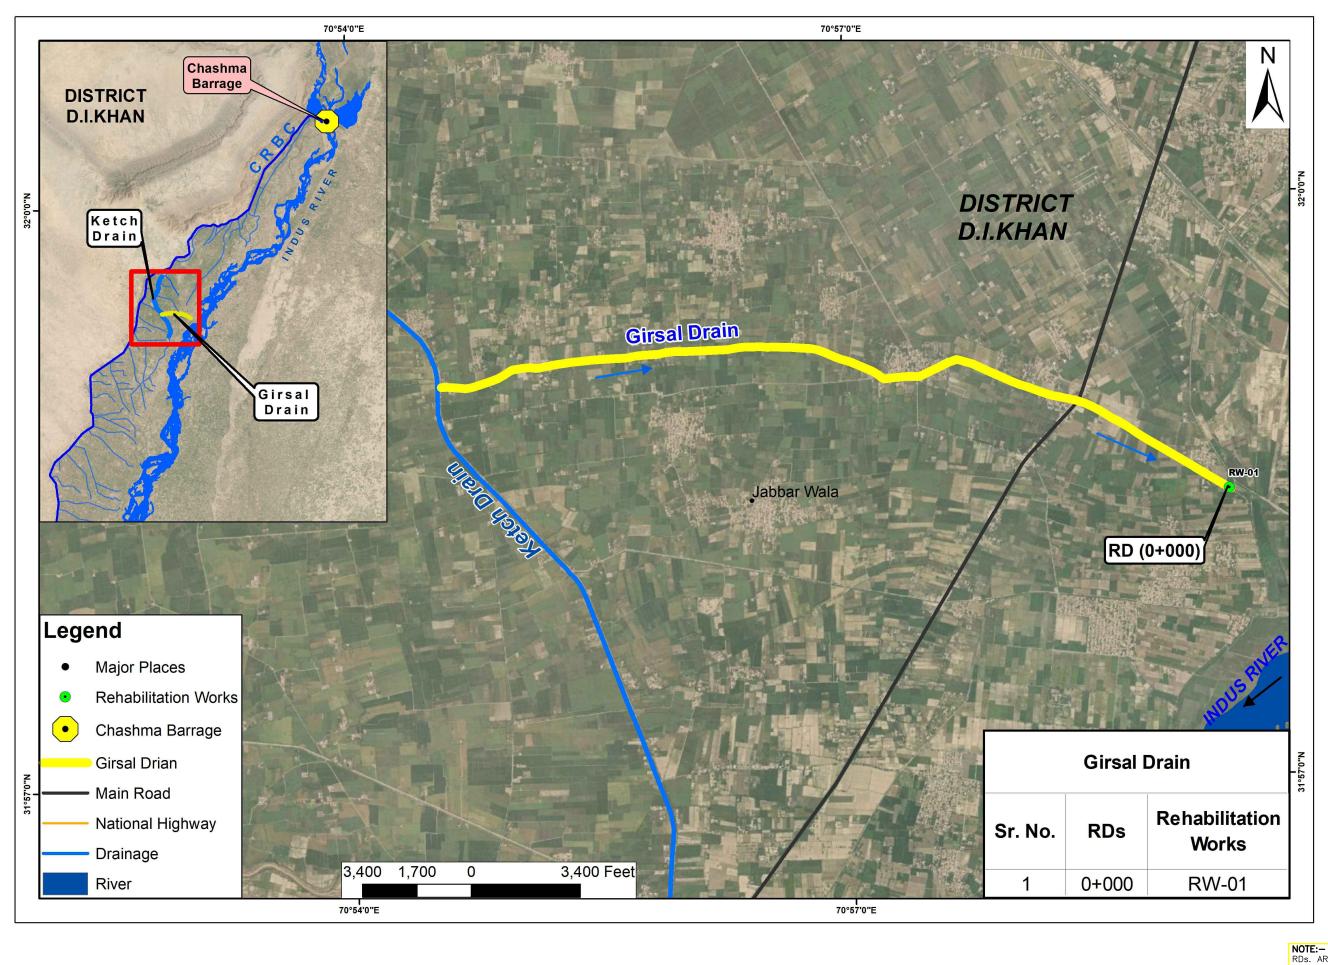

EMERGENCY FLOOD ASSISTANCE PROJECT (EFAP)-KP
"RECONSTRUCTION AND REHABILITATION OF
IRRIGATION AND DRAINAGE SYSTEM AND FLOOD
PROTECTION WORKS IN KHYBER PAKHUNKHWA"


GOVERNMENT PAKHTUI **IRRIGATION D**

							DRAWN	K.A
T OF KHYBER							SUBMITTED	M.M
INKHWA							RECOMMENDED	Q.L
DEPARTMENT							CHD/VER	F.R.K
	RFV.	DATE	DESCRIPTION	BY	CKD.	APPR.	APPROVED	N.A

NATIONAL ENGINEERING SERVICES PAKISTAN (PVT) LIMITED

LOCATION MAP FOR REHABILITATION OF DAMAGED / WASHED AWAY DRAINS SECTION OF GIRSAL DRAIN

HEAD OFFICE: NESPAK HOUSE, 1-C BLOCK N, MODEL TOWN EXTENSION, LAHORE PAKISTAN DRAWING NO.

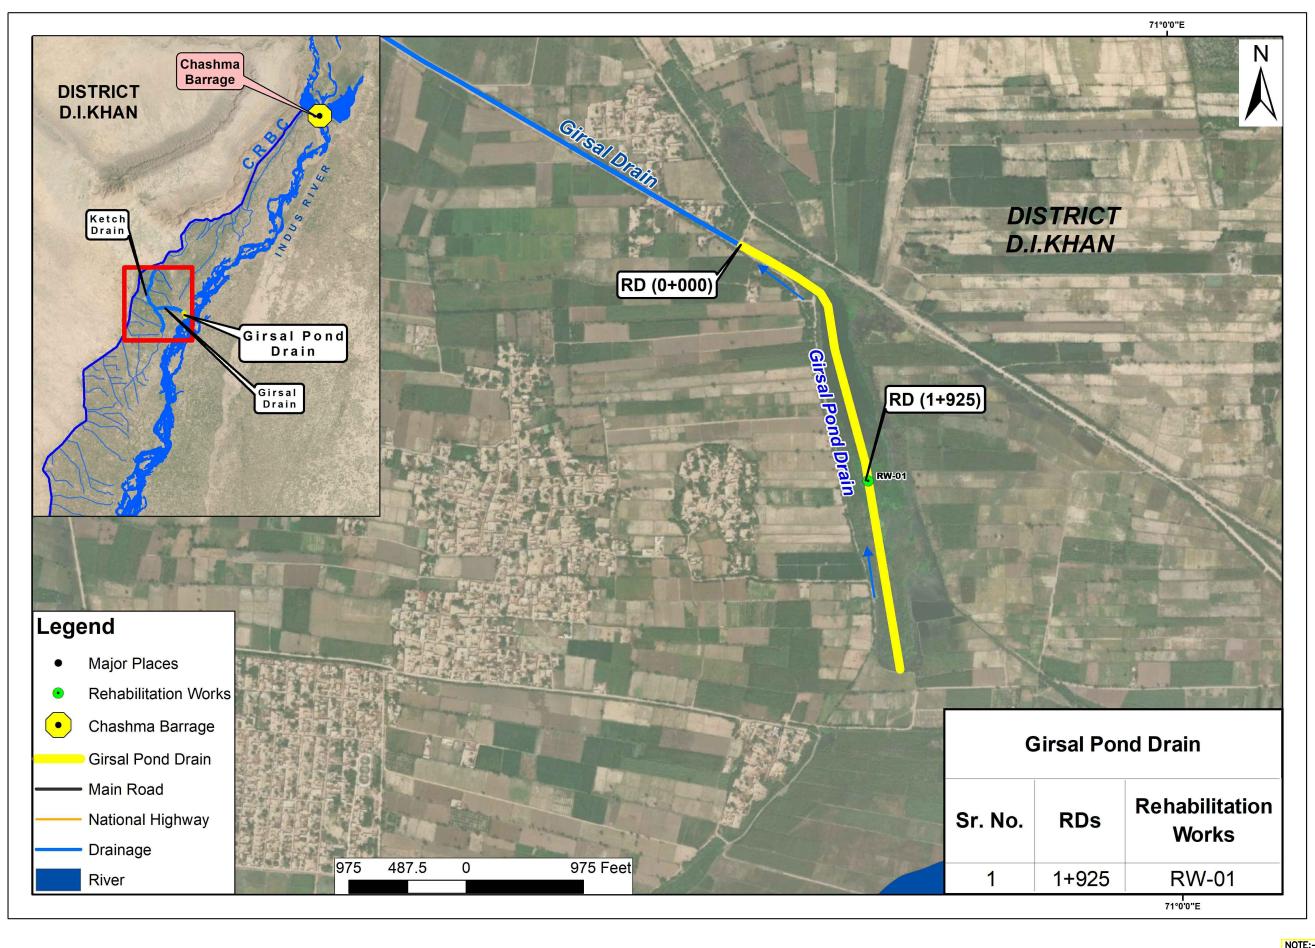

EMERGENCY FLOOD ASSISTANCE PROJECT (EFAP)-KP "RECONSTRUCTION AND REHABILITATION OF IRRIGATION AND DRAINAGE SYSTEM AND FLOOD PROTECTION WORKS IN KHYBER PAKHUNKHWA"




GOVERNMENT OF KHYBER PAKHTUNKHWA IRRIGATION DEPARTMEN

							DRAWN	K.A
R							SUBMITTED	M.M
							RECOMMENDED	Q.L
IT							CHD/VER	F.R.K
	RFV.	DATE	DESCRIPTION	BY	CKD.	APPR.	APPROVED	N.A

NATIONAL ENGINEERING SERVICES PAKISTAN (PVT) LIMITED

LOCATION MAP FOR REHABILITATION OF DAMAGED / WASHED AWAY DRAINS SECTION OF GIRSAL POND DRAIN

HEAD OFFICE: NESPAK HOUSE, 1-C BLOCK N, MODEL TOWN EXTENSION, LAHORE PAKISTAN DRAWING NO.

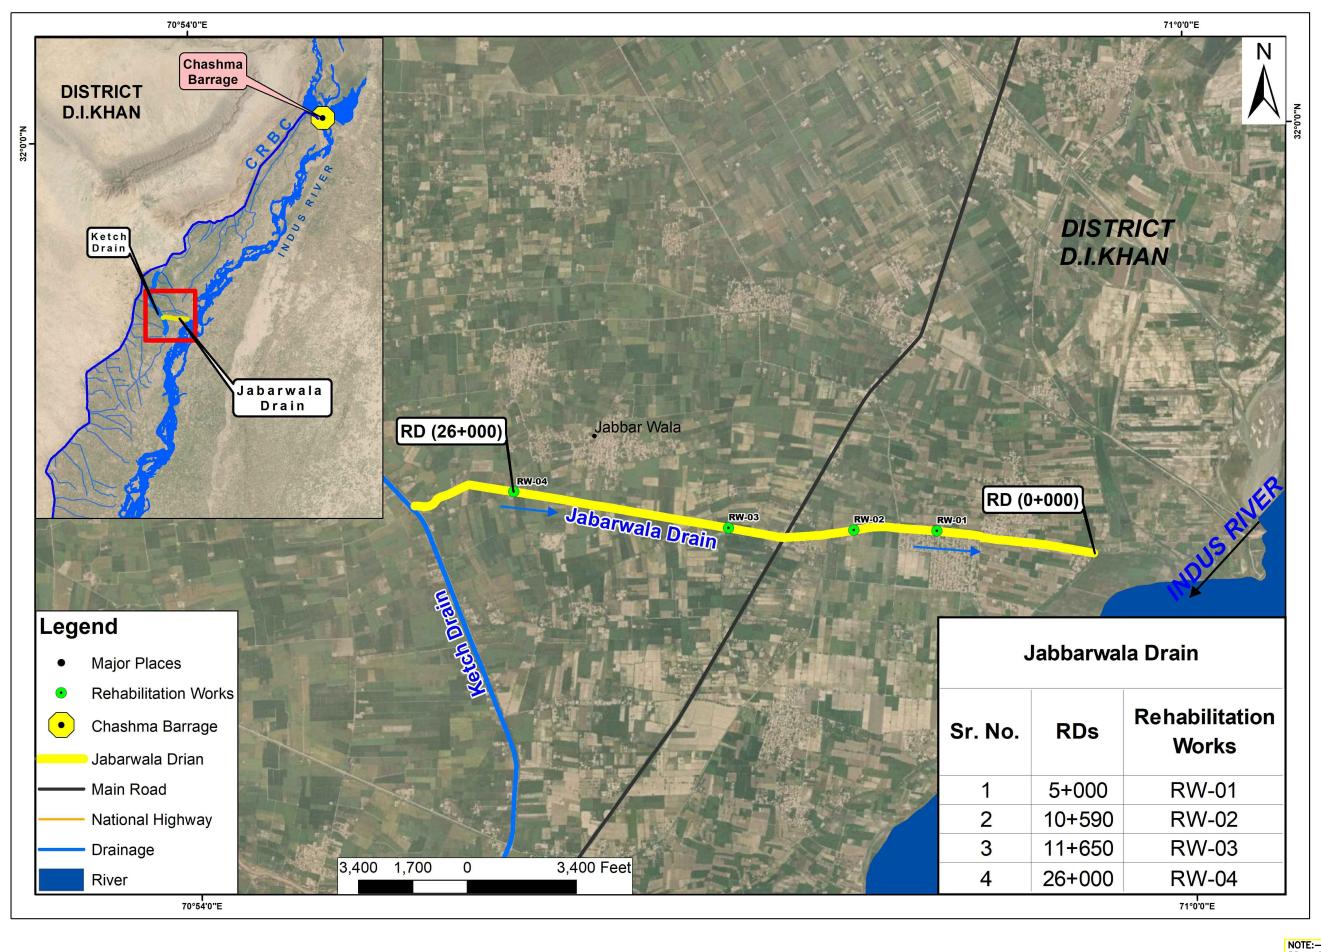

EMERGENCY FLOOD ASSISTANCE PROJECT (EFAP)-KP
"RECONSTRUCTION AND REHABILITATION OF
IRRIGATION AND DRAINAGE SYSTEM AND FLOOD
PROTECTION WORKS IN KHYBER PAKHUNKHWA"




GOVERNMENT OF KHYBER
PAKHTUNKHWA
IRRIGATION DEPARTMENT

							DRAWN	K.A
R							SUBMITTED	M.M
							RECOMMENDED	Q.L
T							CHD/VER	F.R.K
	REV.	DATE	DESCRIPTION	BY	CKD.	APPR.	APPROVED	N.A

NATIONAL ENGINEERING SERVICES PAKISTAN (PVT)

LOCATION MAP FOR REHABILITATION OF DAMAGED / WASHED AWAY DRAINS SECTION OF JABBARWALA DRAIN

HEAD OFFICE : NESPAK HOUSE, 1-C BLOCK N, MODEL TOWN EXTENSION, LAHORE PAKISTAN TE. DRAWING NO.

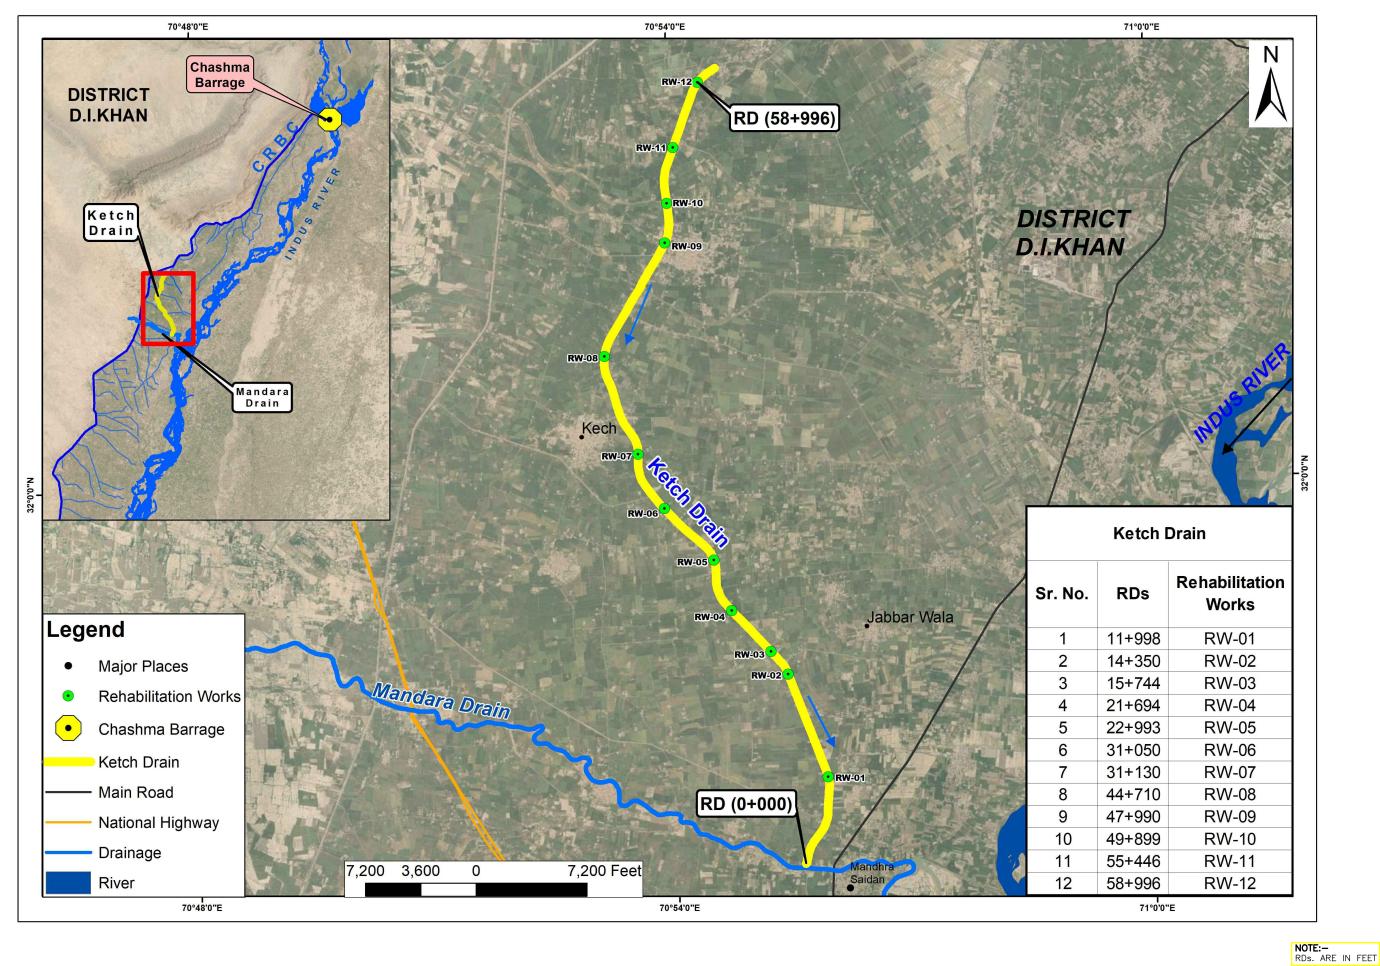

EMERGENCY FLOOD ASSISTANCE PROJECT (EFAP)-KP
"RECONSTRUCTION AND REHABILITATION OF
IRRIGATION AND DRAINAGE SYSTEM AND FLOOD
PROTECTION WORKS IN KHYBER PAKHUNKHWA"


GOVERNMENT OF KHYBER PAKHTUNKHWA IRRIGATION DEPARTMENT

| DRAWN K.A | SUBMITTED M.M | RECOMMENDED | Q.L | CHD/VER | F.R.K | REV. DATE | DESCRIPTION | BY CKD. APPR. APPROVED | N.A |

NATIONAL ENGINEERING SERVICES PAKISTAN (PVT)

LOCATION MAP FOR REHABILITATION OF DAMAGED / WASHED AWAY DRAINS SECTION OF KETCH DRAIN

HEAD OFFICE : NESPAK HOUSE, 1-C BLOCK N, MODEL TOWN EXTENSION, LAHORE PAKISTAN DATE. DRAWING NO.

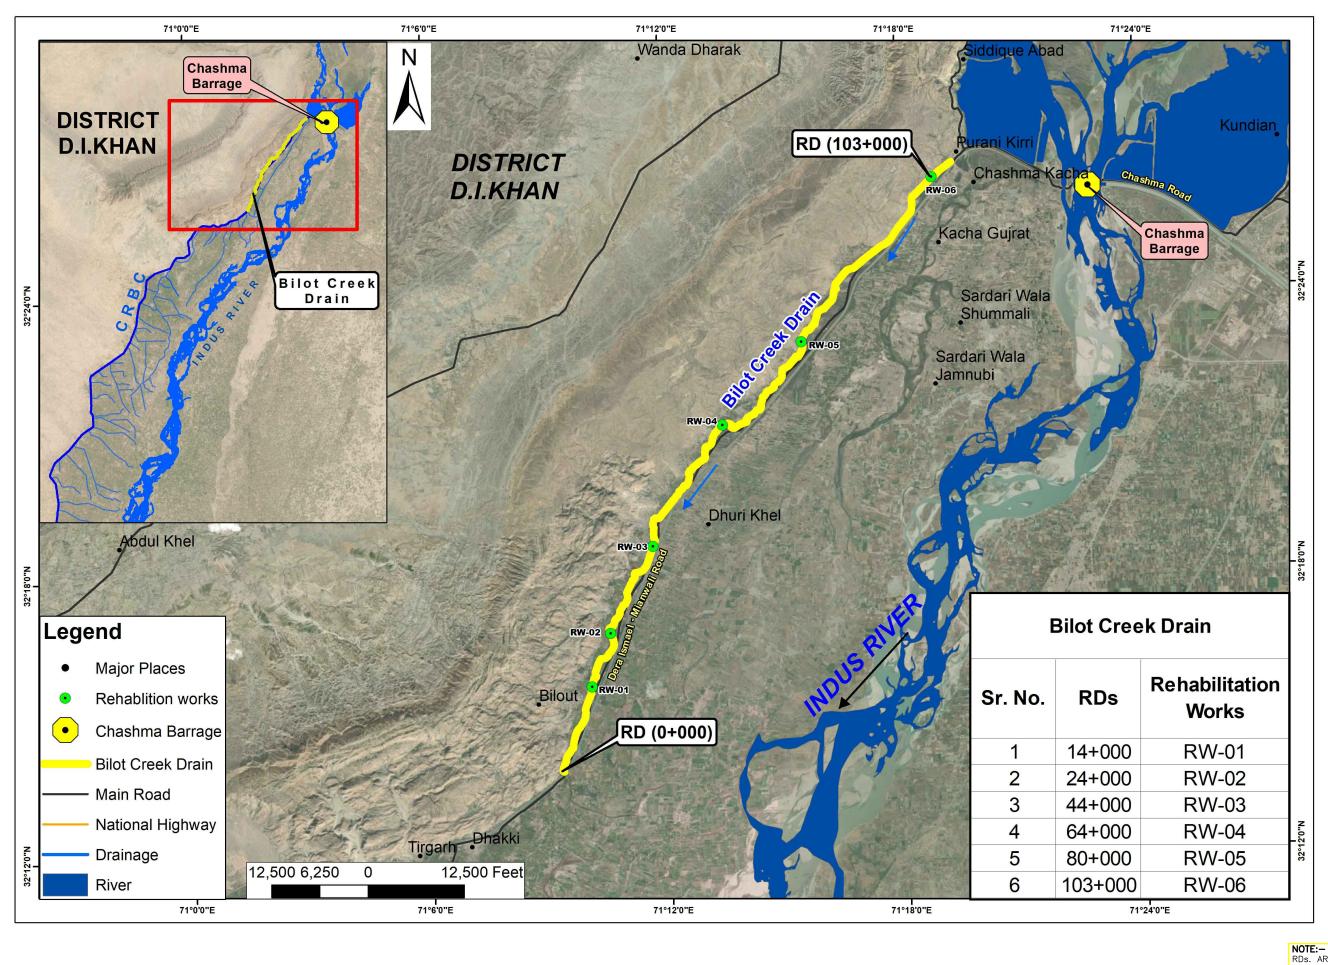

EMERGENCY FLOOD ASSISTANCE PROJECT (EFAP)-KP "RECONSTRUCTION AND REHABILITATION OF **IRRIGATION AND DRAINAGE SYSTEM AND FLOOD** PROTECTION WORKS IN KHYBER PAKHUNKHWA"

GOVERNMENT PAKHTUN **IRRIGATION DE**

							DRAWN	K.A
OF KHYBER							SUBMITTED	M.M
NKHWA							RECOMMENDED	Q.L
EPARTMENT							CHD/VER	F.R.K
	REV.	DATE	DESCRIPTION	BY	CKD.	APPR.	APPROVED	N.A

NATIONAL ENGINEERING SERVICES PAKISTAN (PVT)

LOCATION MAP FOR REHABILITATION OF DAMAGED / WASHED AWAY DRAINS SECTION OF BILOT CREEK DRAIN

HEAD OFFICE: NESPAK HOUSE, 1-C BLOCK N, MODEL TOWN EXTENSION, LAHORE PAKISTAN DRAWING NO.

			Table o	f Details	of Proposed	Restoration	ı/Reh	abilitation	Works	of Katg	arh Bra	nch Dra	in No. (03	
									Desig	n Paramet	ers of Drai	n (L-Profil	e)		
Sr. No.	Start RD	ID	Coord	linates	Type of Rehab. Works	Length of Rehab.Work	Side	Design Discahrge	Type of Channel	Bed Width	Flow Depth	Bed Slope	Bed Level	Bank Level	Reference Drawing
			Easting	Northing		L		Q							
(-)	(ft)	(-)	(ft)	(ft)	(-)	(ft)	(-)	(cusec)	(-)	(ft)	(ft)	(ft/ft)	(ft)	(ft)	(-)
1	1+000	RW-1	2270065	11680475	Section Cleaning	1000	BS	74	Earthen	12	2.03	0.0012	591.08	598.11	4593/TD/061/DR/RW-01
2	2+460	RW-2	2268591	11680794	Section Cleaning	1460	BS	74	Larmen	12	2.12	0.001	587.60	594.72	4593/1D/001/DR/RVV-01
			•				Katgarl	n Main Drain							
1	4+108	RW-1	2271210	11680206	Section Cleaning	4108	BS	286		45	3	0.0004	582.50	590.50	
2	10+500	RW-2	2267382	11684269	Section Cleaning	6392	BS	286		45	3	0.0004	584.59	592.59	
3	12+556	RW-3	2264982	11684870	Section Cleaning	2056	BS	74	Earthen	12	2.87	0.00033	585.84	592.71	4593/TD/061/DR/RW-01
4	15+115	RW-4	2263498	11685569	Section Cleaning	2559	BS	74		12	2.44	0.0006	587.38	594.82	

^{*} RDs are taken from the Start of the proposed rehabilitation works

BS = Both Side

RS = Right Side

Left Side

NOTES:

- ALL RDs/Coordinates should be confirmed by site engineer before construction.
 Drain Section shall be Restored As Per Approved L—Section.

EFAP)-KP	
N OF	
LOOD	

						DRAWN	K.A
						SUBMITTED	M.M
						RECOMMENDED	Q.L
						CHD/VER	F.R.K
REV.	DATE	DESCRIPTION	BY	CKD.	APPR.	APPROVED	N.A

HEAD OFFICE: NESPAK HOUSE, 1-C BLOCK N, MODEL TOWN EXTENSION, LAHORE PAKISTAN

^{*} Section Cleaning = Clearing and Grubing / Uprooting Sirkanda

^{*} Section Restoration = Bank Raising and Section Cleaning

				Table o	f Details of Pro	oposed R	estora	tion/Reha	bilitation	Works	s of Kat	garh Br	anch D	rain No	. 04		
									Desigr	Paramete	ers of Drai	n (L-Sectio	n)				
Sr. No.	Start RD	ID	Coordinates (Start)		Type of Rehab. Works	Length of Rehab.Wor k	Side	Design Discahrge	Type of Channel	Bed Width	Flow Depth	Bed Slope	Existing Bed Level	Design Bed Level	Existing Bank Level	Proposed Bank Level	Reference Drawing
			Easting	Northing		L		Q (cusec)									
(-)	(ft)	(-)	(ft)	(ft)	(-)	(ft)	(-)	(ft3/s)	(-)	(ft)	(ft)	(ft/ft)	(ft)	(ft)	(ft)	(ft)	(-)
1	3+900	RW-1	2267159	11681044	Section Cleaning	3900	BS	285		48	3.35	0.0006	585.89	583.25	590.47	591.60	4593/TD/061/DR/RW/01
2	5+800	RW-2	2265365	11681064	Section Restoration	600	BS	285		48	3.35	0.0009	583.53	583.35	588.11	591.70	4593/TD/061/DR/RW/02
3	6+700	RW-3	2264436	11681074		2200	BS	115	Earthen	23	2.55	0.00015	585.68	583.71	591.94	591.26	
4	9+000	RW-4	2262848	11682348	Section Cleaning	2300	BS	115		23	2.55	0.00015	589.28	586.79	592.29	594.34	4593/TD/061/DR/RW/01
5	10+100	RW-5	2262164	11683074		1100	BS	115		23	2.55	0.00015	590.44	586.96	591.95	594.51	

^{*} RDs are taken from the Start of the proposed rehabilitation works

BS = Both Side

RS = Right Side

Left Side

NOTES:

- ALL RDs/Coordinates should be confirmed by site engineer before construction.
 Drain Section shall be Restored As Per Approved L—Section.

GOVERNMENT OF KHYBER			
PAKHTUNKHWA			

IRRIGATION DEPARTMENT

4593/TD/061/TOD-02

Section Cleaning = Clearing and Grubing / Uprooting Sirkanda

Section Restoration = Bank Raising and Section Cleaning

	Table of Details of Proposed Restoration/Rehabilitation Works of Largi Drain No. 02																
											Design Pa	arameters	of Drain				
Sr. No.	Start RD	ID		inates	Type of Rehab. Works	Length of Rehab. Work	Side	Design Discahrge	Type of Channel	Bed Width	Flow Depth	Bed Slope	Existing Bed Level	Design Bed Level	Existing Bank Level	Proposed Bank Level	Reference Drawing
			Easting	Northing		L		Q									
(-)	(ft)	(-)	(ft)	(ft)	(-)	(ft)	(-)	(ft3/s)	(-)	(ft)	(ft)	(ft/ft)	(ft)	(ft)	(ft)	(ft)	(-)
1	6+850	RW-1	2262057	11672311	Section Cleaning	6850	BS	378		25	4.16	0.00065	588.40	585.22	591.69	594.38	4593/TD/061/DR/RW-01
2	7+070	RW-2	2261884	11672304	Section Restoration	120	BS	378	Earthen	25	4.16	0.00065	588.54	585.38	591.83	594.54	4593/TD/061/DR/RW-02
3	9+308	RW-3	2259978	11672307	Section Cleaning	2238	BS	378		25	4.16	0.00065	589.99	586.82	593.28	595.98	4593/TD/061/DR/RW-01

^{*} RDs are taken from the Start of the proposed rehabilitation works

BS = Both Side

RS = Right Side

LS = Left Side

NOTES:

ALL RDs/Coordinates should be confirmed by site engineer before construction.
 Drain Section shall be Restored As Per Approved L—Section.

EMERGENCY FLOOD ASSISTANCE PROJECT (EFAP)-KP
"RECONSTRUCTION AND REHABILITATION OF
IRRIGATION AND DRAINAGE SYSTEM AND FLOOD PROTECTION WORKS IN KHYBER PAKHUNKHWA"

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St (ETAP \ lable, gang)	PAKHTUNKHWA
ALL DE	IRRIGATION DEPARTMENT
The same of the sa	

						DRAWN	K.A
						SUBMITTED	M.M
						RECOMMENDED	Q.L
						CHD/VER	F.R.K
REV.	DATE	DESCRIPTION	BY	CKD.	APPR.	APPROVED	N.A

MODEL TOWN EXTENSION, LAHORE PAKISTAN

^{*} Section Cleaning = Clearing and Grubing / Uprooting Sirkanda

^{*} Section Restoration = Bank Raising and Section Cleaning

					Table of Deta	ails of Pr	opose	d Restora	tion/Reh	abilitat	ion Wo	rks of L	argi Drai	n No. 01			
			Coore	linates		Length of			Design Pa	rameters	of Drain (L	-Section)					
Sr. No.	Start RD	ID	Coord	illiates	Type of Rehab. Works	Rehab. Work	Side	Design Discahrge	Type of Channel	Bed Width	Flow Depth	Bed Slope	Existing	Design Bed Level	Existing Bank	Proposed Bank Level	Reference Drawing
			Easting	Northing		L		Q	Cilaiillei	vvidtii	Deptil	Slope	Ded Level	Ded Level	Level	Dalik Level	
(-)	(ft)	(-)	(ft)	(ft)	(-)	(ft)	(-)	(ft3/s)	(-)	(ft)	(ft)	(ft/ft)	(ft)	(ft)	(ft)	(ft)	(-)
1	0+000	RW-1	2255951	11655151	Box Culvert	-	-	94		14.00	3.15	0.00045	576.10	576.34	583.41	584.25	4502/TD/064/DD/DC 04
2	1+500	RW-2	2254854	11656158	Section Cleaning	1500	BS	94		14.00	3.15	0.00045	576.76	577.02	584.09	584.91	4593/TD/061/DR/DC-01
4	2+750	RW-4	2253839	11656884	Bank protection	300	LS	94		14.00	3.15	0.00045	577.31	575.50	583.32	585.46	4593/TD/061/DR/RW-03
3	4+000	RW-3	2252820	11657605	Section Cleaning	1400	BS	94	Conthon	14.00	3.15	0.00045	578.00	579.80	584.21	586.15	4593/TD/061/DR/RW-01
5	4+150	RW-5	2252723	11657705	Bank protection	350	LS	94	Earthen	14.00	3.15	0.00045	578.36	579.51	584.78	586.51	4593/TD/061/DR/RW-03
6	5+700	RW-6	2251545	11658788	Section Cleaning	1550	BS	94		6.00	2.56	0.0023	581.90	583.86	588.25	589.46	4593/TD/061/DR/RW-01
7	5+800	RW-7	2251526	11658812	Bank protection	100	RS	94		6.00	2.56	0.0023	582.13	583.86	588.25	589.69	4593/TD/061/DR/RW-03 (B)
8	8+509	RW-8	2250593	11661028	Section Cleaning	2709	BS	94		6.00	2.56	0.0023	588.07	590.07	594.46	595.63	4593/TD/061/DR/RW-01

DESCRIPTION

BS = Both Side RS = Right Side LS = Left Side

- ALL RDs/Coordinates should be confirmed by site engineer before construction.
 Drain Section shall be Restored As Per Approved L—Section.

NOTES:

				DRAWN	K.A	NATIONAL ENGINEERING	
KHYBER				SUBMITTED	M.M	SERVICES PAKISTAN (PVT)	FOR F
WA				RECOMMENDED	Q.L	LIMITED	
RTMENT				CHD/VER	F.R.K	HEAD OFFICE : NESPAK HOUSE, 1-C BLOCK N,	DATE.

^{*} RDs are taken from the Start of the proposed rehabilitation works

^{*} Section Cleaning = Clearing and Grubbing / Uprooting Sirkanda

^{*} Section Restoration = Bank Raising and Section Cleaning

Bank Protection = Side Retaining Wall / Stone Pitching

	Table of Details of Proposed Restoration/Rehabilitation Works of Seed Farm Branch Drain														
		Coordinates							Desig	ın Paramet	ers of Dra	in (L-Sect	ion)		
Sr. No.	Start RD	ID	Coord	inates	Type of Rehab. Works	Length of Rehab. Work	Side	Design Discahrge	Type of Channel	Bed Width	Flow Depth	Bed Slope	Bed Bed Bank Dra		Reference Drawing
			Easting	Northing		L		Q							
(-)	(ft)	(-)	(-)	(-)	(-)	(ft)	(-)	(ft3/s)	(-)	(ft)	(ft)	(ft/ft)	(ft)	(ft)	(-)
1	6+860	RW-1	2264982	11684870	Section Cleaning	6860	BS	30	Earthen	20.00	1.75	0.00023	575.67	582.42	4593/TD/061/DR/RW-01

^{*} RDs are taken from the Start of the proposed rehabilitation works

Both Side

Right Side RS =

Left Side LS =

NOTES:

- RDs/Coordinates should be confirmed by
- site engineer before construction.

 2. Drain Section shall be Restored As Per Approved L—Section.

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EMERGENCY FLOOD ASSISTANCE PROJECT (EFAP)-KP "RECONSTRUCTION AND REHABILITATION OF IRRIGATION AND DRAINAGE SYSTEM AND FLOOD PROTECTION WORKS IN KHYBER PAKHUNKHWA"



							DRAWN	K.A
₹						·	SUBMITTED	M.M
							RECOMMENDED	Q.L
Γ							CHD/VER	F.R.K
	REV.	DATE	DESCRIPTION	BY	CKD.	APPR.	APPROVED	N.A

^{*} Section Cleaning = Clearing and Grubing / Uprooting Sirkanda

Section Restoration = Bank Raising and Section Cleaning

^{*}Bank Protection = Side Retaining Wall / Stone Pitching

	Table of Details of Proposed Restoration/Rehabilitation Works of Bund Kurai Branch Drain																
									Desi	gn Parame	eters of Dr	ain					
Sr. No.	Start RD	ID	Coord (Sta		Type of Rehab. Rehab.V Works ork			Design Discahrge	Type of Channel	Bed Width	Flow Depth	Bed Slope	Existing Bed Level	Design Bed Level	Existing Bank Level	Propose d Bank Level	Reference Drawing
			Easting	Northing		L		Q									
(-)	(ft)	(-)	(ft)	(ft)	(-)	(ft)	(-)	(ft3/s)	(-)	(ft)	(ft)	(ft/ft)	(ft)	(ft)	(ft)	(ft)	(-)
1	6+000	RW-1	2239042	11633277		11215	BS	460		30	4.49	0.00053	581.00	578.13	587.62	587.62	
2	12+000	RW-2	2233468	11631822	Section Cleaning	10300	BS	460		30	4.34	0.0006	584.61	581.74	591.08	591.08	4593/TD/061/DR/RW-01
3	19+019	RW-3	2227263	11633447		8200	BS	460	Earthen	30	4.34	0.0006	588.81	585.94	595.28	595.28	
4	19+019	RW-4	2227263	11633447	Section Restoration	330	RS & LS	460		30	4.34	0.0006	588.81	585.94	595.28	595.28	4593/TD/061/DR/RW-02
5	19+019	RW-5	2227263	11633447	Section Cleaning	7019	BS	460		30	4.34	0.0006	588.81	585.94	595.28	595.28	4593/TD/061/DR/RW-01

RDs are taken from the Start of the proposed rehabilitation works

BS = Both Side RS = Right Side LS = Left Side

- 1. ALL RDs/Coordinates should be confirmed by
- site engineer before construction.

 2. Drain Section shall be Restored As Per Approved L—Section.

NOTES:

NATIONAL ENGINEERING SERVICES PAKISTAN (PVT)

M.M

DRAWN

SUBMITTED

Section Cleaning = Clearing and Grubing / Uprooting Sirkanda

Section Restoration = Bank Raising and Section Cleaning

Bank Protection = Side Retaining Wall / Stone Pitching

	Table of Details of Proposed Restoration/Rehabilitation Works of Bund Kurai Main Drain																
						l amouth of		Design Parameters of Drain									
Sr. No.	Start RD	ID	Coordinates			Length of Rehab. Work	Side	Design Discahrge	Type of Channel	Bed Width	Flow Depth	Bed Slope	Existing Bed Level	Design Bed Level	Existing Bank Level	Proposed Bank Level	Reference Drawing
			Easting	Northing		L		Q					Level		Level	Level	
(-)	(ft)	(-)	(ft)	(ft)	(-)	(ft)	(-)	(ft3/s)	(-)	(ft)	(ft)	(ft/ft)	(ft)	(ft)	(ft)	(ft)	(-)
1	2+750	RW-1	2246872	11631516		300	LS	920		50	5.55	0.0004	575.16	573.05	583.60	586.60	
2	3+300	RW-2	2246277	11631745	Bank protection	200	RS	920		50	5.55	0.0004	575.39	573.28	583.83	586.83	4593/TD/061/DR/RW-03
3	4+450	RW-3	2245272	11632117		100	LS	920		50	5.55	0.0004	575.85	573.74	584.29	587.29	
4	4+700	RW-4	2245042	11632207	Section Restoration	800	LS	920	Earthen	50	5.55	0.0004	575.95	573.84	584.39	587.39	4593/TD/061/DR/RW-02
5	10+440	RW-5	2241150	11636090	Section Restoration	950	LS	450	450	25	5.29	0.0004	576.70	574.59	582.88	585.88	4093/10/001/DR/RVV-02
6	23+500	RW-6	2229057	11639048	Section Cleaning	23500	BS	460		25	4.38	0.0008	587.66	585.55	590.55	593.55	4593/TD/061/DR/RW-01
7	23+500	RW-7	2229057	11639048	Section Restoration	4600	LS	460		25	4.38	0.0008	587.66	585.55	594.93	597.93	4593/TD/061/DR/RW-02

^{*} RDs are taken from the Start of the proposed rehabilitation works

BS = Both Side

RS = Right Side

LS = Left Side

NOTES:

- ALL RDs/Coordinates should be confirmed by site engineer before construction.
 Drain Section shall be Restored As Per Approved L—Section.

EMERGENCY FLOOD ASSISTANCE PROJECT (EFAP)-KP
"RECONSTRUCTION AND REHABILITATION OF
IRRIGATION AND DRAINAGE SYSTEM AND FLOOD
PROTECTION WORKS IN KHYBER PAKHUNKHWA"

GOVERNMENT OF KHYBER
PAKHTUNKHWA
IRRIGATION DEPARTMENT

							DRAWN	K.A
₹							SUBMITTED	M.M
							RECOMMENDED	Q.L
Γ							CHD/VER	F.R.K
	REV.	DATE	DESCRIPTION	BY	CKD.	APPR.	APPROVED	N.A

Section Cleaning = Clearing and Grubing / Uprooting Sirkanda

^{*} Section Restoration = Bank Raising and Section Cleaning

^{*} Bank Protection = Side Retaining Wall / Stone Pitching

				Table	of Details	of Proposed	Restora	tion/Re	habilitat						
Sr. No.	Start RD	ID	(Start) Disca		Design Discahrge	Type of Rehab.	Length of Rehab. Work	Side	Type of Channel	Bed Width	Flow Depth	meters of I Bed Slope	Drain (L-Prof Design Bed Level	Design Bank Level	Reference Drawing
			Easting	Northing	Q (cusec)		L								
(-)	(ft)	(-)	(ft)	(ft)	(ft3/s)	(-)	(ft)	(-)	(-)	(ft)	(ft)	(ft/ft)	(ft)	(ft)	(-)
1	8+500	RW-1	2250649	11626183	1927	Section Cleaning	800	BS	Earthen	80	8.31	0.00017	568.19	581.5044	4593/TD/061/DR/RW-0
2	14+000	RW-2	2249275	11631250	1927	Left bank protection	200	LS	Earthen	80	8.31	0.00018	569.18	582.4884	4593/TD/061/DR/RW-03
3	14+000	RW-3	2249275	11631250	1007	Section Cleaning	0	BS	Earthen	65	6.87	0.00017	569.18	581.0484	4593/TD/061/DR/RW-0 ⁻
4	14+050	RW-4	2249263	11631274	1007	Left bank protection	50	LS	Earthen	65	6.87	0.00017	569.18	581.0484	4593/TD/061/DR/RW-03
5	26+650	RW-5	2248478	11643724	1007	Section Restoration	250	RS & LS	Earthen	65	6.87	0.00017	570.95	582.8196	4593/TD/061/DR/RW-02
6	28+300	RW-6	2248389	11645528	1007	Section Restoration	300	RS & LS	Earthen	65	6.87	0.00017	571.18	583.0492	4393/10/001/DR/RVV-02
7	28+300	RW-7	2248389	11645528	1007	Box Culvert required	-	-	-	-	-	-	-	-	4593/TD/061/DR/DC-01
8	42+900	RW-8	2257570	11656280	913		800	BS	Earthen	60	6.21	0.00019	573.28	584.49	
9	49+500	RW-9	2262431	11660630	913		1000	BS	Earthen	60	6.21	0.00019	574.52	585.73	
10	55+200	RW-10	2265549	11665031	913		1200	BS	Earthen	50	5.69	0.00036	575.61	586.30	
11	61+000	RW-11	2268066	11670476	913		800	BS	Earthen	50	5.69	0.00036	577.41	588.10	
12	64+500	RW-12	2269587	11673643	537	Section Cleaning	1500	BS	Earthen	36	4.71	0.00044	578.69	588.40	4593/TD/061/DR/RW-0 ⁻
13	69+000	RW-13	2272373	11677050	537]	1000	BS	Earthen	36	4.71	0.00044	580.56	590.27	
14	78+187	RW-14	2278620	11683645	420		9187	BS	Earthen	32	4.5	0.00039	584.07	593.57	
15	84+000	RW-15	2282597	11687973	300		5813	BS	Earthen	30	4.25	0.00028	585.71	594.96	
16	93+000	RW-16	2287464	11693704	300		9000	BS	Earthen	30	4	0.00036	588.79	597.79	

RDs are taken from the Start of the proposed rehabilitation works

BS = Both Side Right Side RS = LS = Left Side

NOTES:

- 1. ALL RDs/Coordinates should be confirmed by
- site engineer before construction.

 2. Drain Section shall be Restored As Per Approved L—Section.

NATIONAL ENGINEERING SERVICES PAKISTAN (PVT) LIMITED

TABLE OF DETAILS
FOR REHABILITATION OF DAMAGED / WASHED AWAY
DRAINS SECTION OF MAIN DRAIN

EMERGENCY FLOOD ASSISTANCE PROJECT (EFAP)-KP "RECONSTRUCTION AND REHABILITATION OF IRRIGATION AND DRAINAGE SYSTEM AND FLOOD PROTECTION WORKS IN KHYBER PAKHUNKHWA"

NE STE	GOVERNMENT OF KHYBER
ENERGY Linksprag	PAKHTUNKHWA
Salar Report	IRRIGATION DEPARTMENT

						DRAWN	K.A
						SUBMITTED	M.M
						RECOMMENDED	Q.L
						CHD/VER	F.R.K
DEV	DATE	DECODIPTION	DV	CKD	4000	*DDD0//ED	NI A

Section Cleaning = Clearing and Grubbing / Uprooting Sirkanda

Section Restoration = Bank Raising and Section Cleaning

Bank Protection = Side Retaining Wall / Stone Pitching

	Table of Details of Proposed Restoration/Rehabilitation Works of Girsal Drain																		
			Coordinates _ Length of							_	Design Parameters of Drain								
Sr. No.	Start RD	End RD	Mid RD	ID		art)	Type of Rehab. Works	Rehab. Work	Side	Design	Type of Channel	Bed Width	Flow	Bed Slope	Existing Bed	Design Bed	Existing Bank	Proposed Bank	Reference Drawing
					Easting	Northing		L		Discahrge	Cilalillei	widui	Depth	Slope	Level	Level	Level	Level	
(-)	(ft)	(ft)	(ft)	(-)	(ft)	(ft)	(-)	(ft)	(-)	Q	(-)	(ft)	(ft)	(ft/ft)	(ft)	(ft)	(ft)	(ft)	(-)
1	2	3	4	5	6	7	10	11	12	(ft3/s)	13	14	15	17	19	20	21	22	23
1	0+000	26+662	13+331	RW-1	2232125	11615104	Section Cleaning	26662	BS	9	Earthen	10	2.83	0.0005	572.79	571.02	575.18	578.85	4593/TD/061/DR/RW-01

^{*} RDs are taken from the Start of the proposed rehabilitation works

Both Side BS =

RS = Right Side

LS = Left Side

- ALL RDs/Coordinates should be confirmed by site engineer before construction.
 Drain Section shall be Restored As Per Approved L—Section.

NOTES:

NATIONAL ENGINEERING SERVICES PAKISTAN (PVT) LIMITED

TABLE OF DETAILS FOR REHABILITATION OF DAMAGED / WASHED AWAY DRAINS SECTION OF GIRSAL DRAIN

EMERGENCY FLOOD ASSISTANCE PROJECT (EFAP)-KP
"RECONSTRUCTION AND REHABILITATION OF
IRRIGATION AND DRAINAGE SYSTEM AND FLOOD PROTECTION WORKS IN KHYBER PAKHUNKHWA"

14 July 19 19 19 19 19 19 19 19 19 19 19 19 19	GOVERNMENT OF KHYBER
ENERGY Labourage	PAKHTUNKHWA
AND SERVE	IRRIGATION DEPARTMENT

					·	SUBMITTED	M.M
						RECOMMENDED	Q.L
						CHD/VER	F.R.K
REV.	DATE	DESCRIPTION	BY	CKD.	APPR.	APPROVED	N.A

DRAWN

K.A

^{*} Section Cleaning = Clearing and Grubbing / Uprooting Sirkanda

^{*} Section Restoration = Bank Raising and Section Cleaning

^{*} Bank Protection = Side Retaining Wall / Stone Pitching

				Та	ble of Details	of Pro	posed	Restorat	ion/Reh	abilitati	on Wor	ks of G	irsal Po	nd Drain	1		
Sr. No.	RD ` ` ´ Works Work Discahrge Channel Width Denth Slope Bed Bed Evel Bank Bank Level								Reference Drawing								
			Easting	Northing		L		Q	Chamilei	WIGHT	Depui	Slope	Level	Ded Level	Level	Dalik Level	
(-)	(ft)	(-)	(ft)	(ft)	(-)	(ft)	(-)	(ft3/s)	(-)	(ft)	(ft)	(ft/ft)	(ft)	(ft)	(ft)	(ft)	(-)
1	1+925	RW-1	2257825	11610363	Section Cleaning	900	BS	39.9	Earthen	48	1.83	0.001	570.62	565.34	571.89	572.17	4593/TD/061/DR/RW-01

RDs are taken from the Start of the proposed rehabilitation works

BS = Both Side RS = Right Side

LS = Left Side

- 1. ALL RDs/Coordinates should be confirmed by

NOTES:

site engineer before construction.

2. Drain Section shall be Restored As Per Approved L—Section.

						DIAWN	K.A
						SUBMITTED	M.M
						RECOMMENDED	Q.L
						CHD/VER	F.R.K
RFV.	DATE	DESCRIPTION	BY	CKD.	APPR.	APPROVED	N.A

Section Cleaning = Clearing and Grubbing / Uprooting Sirkanda

Section Restoration = Bank Raising and Section Cleaning

^{*} Bank Protection = Side Retaining Wall / Stone Pitching

	Table of Details of Proposed Restoration/Rehabilitation Works of Jabbarwala Drain																
						Length of					Design	Parameter	s of Drain				
Sr. No.	Start RD	ID		inates art)	Type of Rehab. Works	Rehab. Work	Side	Design Discahrge	Type of Channel	Bed Width	Flow Depth	Bed Slope	Existing Bed Level	Design Bed Level	Existing Bank Level	Proposed Bank Level	Reference Drawing
			Easting	Northing		L		Q					Level	Levei	Level	Level	
(-)	(ft)	(-)	(ft)	(ft)	(-)	(ft)	(-)	(ft3/s)	(-)	(ft)	(ft)	(ft/ft)	(ft)	(ft)	(ft)	(ft)	(-)
1	5+000	RW-1	2252512	11608621	Bank protection	100	RS	40		6	2.75	0.0004	572.58	570.60	576.60	578.35	4593/TD/061/DR/RW-03
2	10+590	RW-2	2247852	2246862	Section Cleaning	6090	BS	40	Earthen	6	2.75	0.0004	575.10	572.66	579.30	580.41	4593/TD/061/DR/RW-01
3	11+650	RW-3	2246862	11608435	Bank Protection	300	LS	30	⊏armen	6	2.23	0.0005	575.63	573.64	579.83	580.87	4593/TD/061/DR/RW-03
4	26+000	RW-4	2240471	11606696	Section Cleaning	15410	BS	30		6	2.23	0.0005	582.80	580.82	587.00	588.05	4593/TD/061/DR/RW-01

^{*} RDs are taken from the Start of the proposed rehabilitation works

BS = Both Side

RS= Right Side

Left Side

NOTES:

- 1. ALL RDs/Coordinates should be confirmed by site engineer before construction.

_					nistraction		_	
2.	Drain	Section	shall	be	Restored	As	Per	
	Approv	/ed L−S	ection					

GOVERNMENT OF KHYBER PAKHTUNKHWA **IRRIGATION DEPARTMENT**

							DRAWN	K.A
₹							SUBMITTED	M.M
							RECOMMENDED	Q.L
Γ							CHD/VER	F.R.K
	REV.	DATE	DESCRIPTION	BY	CKD.	APPR.	APPROVED	N.A

Section Cleaning = Clearing and Grubbing / Uprooting Sirkanda

Section Restoration = Bank Raising and Section Cleaning

Bank Protection = Side Retaining Wall / Stone Pitching

				Table o	f Details of Pro	oposed F	Restora	ition/Rel	nabilitati	on Wo	rks of K	etch Dr	ain		
						Length of			Desi	ign Param	eters of Dr	ain (L-Sect	ion)		
Sr. No.	Start RD*	ID		linates tart)	Type of Rehab. Works	Rehab. Work	Side	Design Discahrge	Type of Channel	Bed Width	Flow Depth	Bed Slope	Bed Level	Bank Level	Reference Drawing
			Easting	Northing		L		Q							
(-)	(ft)	(-)	(ft)	(ft)	(-)	(ft)	(-)	(ft3/s)	(-)	(ft)	(ft)	(ft/ft)	(ft)	(ft)	(-)
1	11+998	RW-1	2237171	11607304		11998	BS	99.94		10	4	0.00032	584.63	593.63	
2	14+350	RW-2	2236160	11609321		2352	BS	99.94		10	4	0.00034	585.48	594.48	
3	15+744	RW-3	2235139	11610400	Section Cleaning	1394	BS	99.94		10	4	0.00053	586.20	595.20] - 4593/TD/061/DR/RW-01
4	21+694	RW-4	2232020	11615101	Section Cleaning	5950	BS	99.94]	10	4	0.0001	586.00	595.00	4393/10/00/1/DK/KVV-01
5	22+993	RW-5	2231659	11616310		1299	BS	99.94	1	10	4	0.0003	587.97	596.97	
6	31+050	RW-6	2227019	11621683		8057	BS	99.94		10	4	0.00014	588.96	597.96	
7	31+130	RW-7	2227067	11621772	Section Restoration	80	BS	99.94	Earthen	10	4	0.00014	588.99	597.99	4593/TD/061/DR/RW-02
8	44+710	RW-8	2227919	11635005		13580	BS	99.94]	10	4	0.00014	590.86	599.86	
9	47+990	RW-9	2228927	11638047	Soction Clooping	3280	BS	99.94]	10	4	0.00165	592.76	601.76	1 - 4593/TD/061/DR/RW-01
10	49+899	RW-10	2228686	11639985	Section Cleaning	1909	BS	99.94]	10	4	0.0008	591.25	600.25	4090 00 00 KW-01
11	55+446	RW-11	2230132	11645301		5547	BS	99.94]	10	4	0.00017	592.17	601.17	
12	58+996	RW-12	2232038	11647884	Section Restoration	3550	BS	99.94]	10	4	0.00017	592.79	601.79	4593/TD/061/DR/RW-02

^{*} RDs are taken from the Start of the proposed rehabilitation works

Both Side BS =

RS = Right Side

LS = Left Side

NOTES:

- 1. ALL RDs/Coordinates should be confirmed by
- site engineer before construction.

 2. Drain Section shall be Restored As Per Approved L—Section.

TABLE OF DETAILS
FOR REHABILITATION OF DAMAGED / WASHED AWAY
DRAINS SECTION OF KETCH DRAIN

GOVERNMENT OF KHYBER PAKHTUNKHWA **IRRIGATION DEPARTMENT**

						DRAWN	K.A
						SUBMITTED	M.M
						RECOMMENDED	Q.L
						CHD/VER	F.R.K
REV.	DATE	DESCRIPTION	BY	CKD.	APPR.	APPROVED	N.A

NATIONAL ENGINEERING SERVICES PAKISTAN (PVT) LIMITED

^{*} Section Cleaning = Clearing and Grubbing / Uprooting Sirkanda

Section Restoration = Bank Raising and Section Cleaning

^{*} Bank Protection = Side Retaining Wall / Stone Pitching

					Table of D	etails of	Propos	sed Resto	ration/R	Rehabilit	ation W	orks o	f Bilot Cr	eek			
						1					Design	Parameter	s of Drain				
Sr. No.	Start RD	ID		linates art)	Type of Rehab. Works	Length of Rehab. Work	Side	Design Discahrge	Type of Channel	Bed Width	Flow Depth	Bed Slope	Existing Bed Level	Design Bed Level	Existing Bank Level	Proposed Bank Level	Reference Drawing
			Easting	Northing		L		Q							20101	20101	
(-)	(ft)	(-)	(ft)	(ft)	(-)	(ft)	(-)	(ft3/s)	(-)	(ft)	(ft)	(ft/ft)	(ft)	(ft)	(ft)	(ft)	(-)
1	2	5	6	7	10	11	12	9	13	14	15	17	19	20	21	22	23
1	14+000	RW-1	2310686	11718799	Bank Protection	150	LS	68		8.00	4.00	0.00018	603.73	601.46	607.32	608.46	4593/TD/061/DR/RW-03 (B)
2	24+000	RW-2	2313945	11727048		24000	BS	68		8.00	4.00	1.00018	605.69	603.51	609.96	610.51	
3	44+000	RW-3	2307462	11708630		20000	BS	60	Cautha au	7.00	3.90	0.00018	609.29	610.47	613.56	617.37	
4	64+000	RW-4	2308676	11711734	Section Restoration	20000	BS	50	Earthen	6.50	3.70	0.00018	619.09	623.35	622.04	630.05	4593/TD/061/DR/RW-02
5	80+000	RW-5	2323789	11745849		16000	BS	43		6.00	3.70	0.00018	621.87	618.89	623.54	625.59	
6	103+000	RW-6	2355991	11784624		23000	BS	43		6.00	3.50	0.00018	625.87	619.86	627.75	628.36	

^{*} RDs are taken from the Start of the proposed rehabilitation works

BS = Both Side RS = Right Side LS = Left Side

NOTES:

- ALL RDs/Coordinates should be confirmed by site engineer before construction.
 Drain Section shall be Restored As Per Approved L—Section.

EMERGENCY FLOOD ASSISTANCE PROJECT (EFAP)-KP	
"RECONSTRUCTION AND REHABILITATION OF	
IRRIGATION AND DRAINAGE SYSTEM AND FLOOD	
PROTECTION WORKS IN KHYBER PAKHUNKHWA"	

18 July 18	GOVERNMENT OF KHYBER
SEASTAP Linksprog	PAKHTUNKHWA
THE REAL PROPERTY.	IRRIGATION DEPARTMENT

						DRAWN	K.A
						SUBMITTED	M.M
						RECOMMENDED	Q.L
						CHD/VER	F.R.K
REV.	DATE	DESCRIPTION	BY	CKD.	APPR.	APPROVED	N.A

^{*} Section Cleaning = Clearing and Grubbing / Uprooting Sirkanda

^{*} Section Restoration = Bank Raising and Section Cleaning

^{*} Bank Protection = Side Retaining Wall / Stone Pitching

REHABILITATION WORKS OF CANALS IN PAHARPUR IRRIGATION DIVISION DERA ISMAIL KHAN

LOCATION MAPS & TABLE OF DETAIL DISTRIBUTARIES AND MINORS LS OF GOVERNA PAK IRRIGATIO

	EVIENDION,	N A	CHD/VEK					I	
ň _		F.R.K	? ; } }						
	E LIMITED	Q.L	RECOMMENDED						TION DEPARTMENT
AKISTAN (PVT)	SERVICES PA	K.	SUBMITTED						NMENT OF KHYBER
NGINEERING	NATIONAL EI	F.A	DRAWN						
					$\frac{1}{1}$				
4593/TD/061/TOD-30						AH MINOR	S OF TAKWE	SIONS	TABLE OF DIMEN
4593/TD/061/LM-30						NOR	KWRAH MII	OF TAI	LOCATION MAP
4593/TD/061/TOD-29						NI MINOR	OF BIGWA	SNOIS	TABLE OF DIMEN
4593/TD/061/LM-29						OR	WANI MIN)F BIG	LOCATION MAP
4593/TD/061/TOD-28						ARH MINOR	OF KATHO	SNOIS	TABLE OF DIMEN
4593/TD/061/LM-28						NOR	THGARH MI	OF KA	LOCATION MAP
4593/TD/061/TOD-27						JISTY	OF RAKH [SNOIS	TABLE OF DIMEN
4593/TD/061/LM-27							KH DISTY)F RA	LOCATION MAP OF RAKH DISTY
4593/TD/061/TOD-26						1INOR	OF CIVIL N	SIONS	TABLE OF DIMEN
4593/TD/061/LM-26							/IL MINOR	OF CIV	LOCATION MAP OF CIVIL MINOR
4593/TD/061/TOD-25				160000	000-1	PUR CANAL (RD 30	OF PAHAR	SNOIS	TABLE OF DIMEN
4593/TD/061/LM-25				<u>)</u>	60000	NAL (RD 130000-1	HARPUR CA)F PA	LOCATION MAP
4593/TD/061/TOD-24			0)	-12230	8500	PUR CANAL (RD 11	OF PAHAR	SNOIS	TABLE OF DIMEN
4593/TD/061/LM-24)	22300	NAL (RD 118500-1	HARPUR CA)F PA	LOCATION MAP
4593/TD/061/TOD-23						PUR DISTY	OF PAHAR	SNOIS	TABLE OF DIMEN
4593/TD/061/LM-23						STY	HARPUR DI)F PA	LOCATION MAP
4593/TD/061/TOD-22						MINOR	OF KETCH	SNOIS	TABLE OF DIMEN
4593/TD/061/LM-22							TCH MINOR)F KE	LOCATION MAP OF KETCH MINOR
4593/TD/061/TOD-21						(URAI BRANCH	OF BUND	SNOIS	TABLE OF DIMEN
4593/TD/061/LM-21						RANCH	ND KURAI E)F BU	LOCATION MAP
4593/TD/061/TOD-20						(URAI MINOR	OF BUND	SNOIS	TABLE OF DIMEN
4593/TD/061/LM-20						/INOR	ND KURAI N)F BU	LOCATION MAP (
4593/TD/061/TOD-19						OT FEEDER	OF SHAH K	SNOIS	TABLE OF DIMEN
, , , , , , , , , , , , , , , , , , , ,	4593/TD/061/TC 4593/TD/061/LN 4593/TD/061/LN 4593/TD/061/LN 4593/TD/061/LN 4593/TD/061/LN 4593/TD/061/LN 4593/TD/061/LN 4593/TD/061/LN 4593/TD/061/LN 4593/TD/061/TC	ATIONAL EN PAR HOUSE IN NESPAK HOUSE	NATIONAL EN SERVICES PA LIMITED	RAWN FA UDMITTED M.M SERVICES PA LIMITED OL	RAWN FA UBMITTED M.M. ECOMMENDED O.L HEAD OFFICE: NESPAK HOUSE F.R.K HEAD OFFICE: NESPAK HOUSE	RAWN FA UBMITED M.M ECOMMENDED O.L HOVER F.R.K HEAD OFFICE : NESPAK HOUSE	RAWN FA UBMITTED M.M ECOMMENDED O.L HOVER F.R.K HEAD OFFICE : NESPAK HOUSE HEAD OFFICE : NESPAK HOUSE	RAWN FA UBMITTED M.M. ECOMMENDED O.L HEAD OFFICE: NESPAK HOUSE F.R.K HEAD OFFICE: NESPAK HOUSE	MINOR

31 30 29 28 27 26 25 24

23 22 21 20 19 18

17 16 15 14 13 12 11 10 9 8 SR. NO.

LIST OF LOCATION MAPS AND TODS FOR PROPOSED REHABILITATION WORKS OF DISTRIBUTARIES AND

DRAWING TITLE

LOT-1 CANALS IN PAHARPUR IRRIGATION DIVISION DERA ISMAIL KHAN

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6 5

TABLE OF DIMENSIONS OF GIRSAL MINOR

TABLE OF DIMENSIONS OF DISTY NO.3

LOCATION MAP OF GIRSAL MINOR

LOCATION MAP OF DISTY NO.3

TABLE OF DIMENSIONS OF DISTY NO.2

LOCATION MAP OF DISTY NO.2

LOCATION MAP OF GIRSAL FEEDER

TABLE OF DIMENSIONS OF SHAH KOT MINOR

LOCATION MAP OF SHAH KOT FEEDER

TABLE OF DIMENSIONS OF GIRSAL FEEDER

4593/TD/061/TOD-16 4593/TD/061/LM-17 4593/TD/061/TOD-17 4593/TD/061/LM-18

3/TD/061/TOD-16


4593/TD/061/LM-19 4593/TD/061/TOD-18 4593/TD/061/LM-15 4593/TD/061/TOD-15 4593/TD/061/LM-16

4593/TD/061/LM-14 4593/TD/061/TOD-1

DRAWING NO.

MINOR

LOCATION MAP OF SHAH KOT MINOR

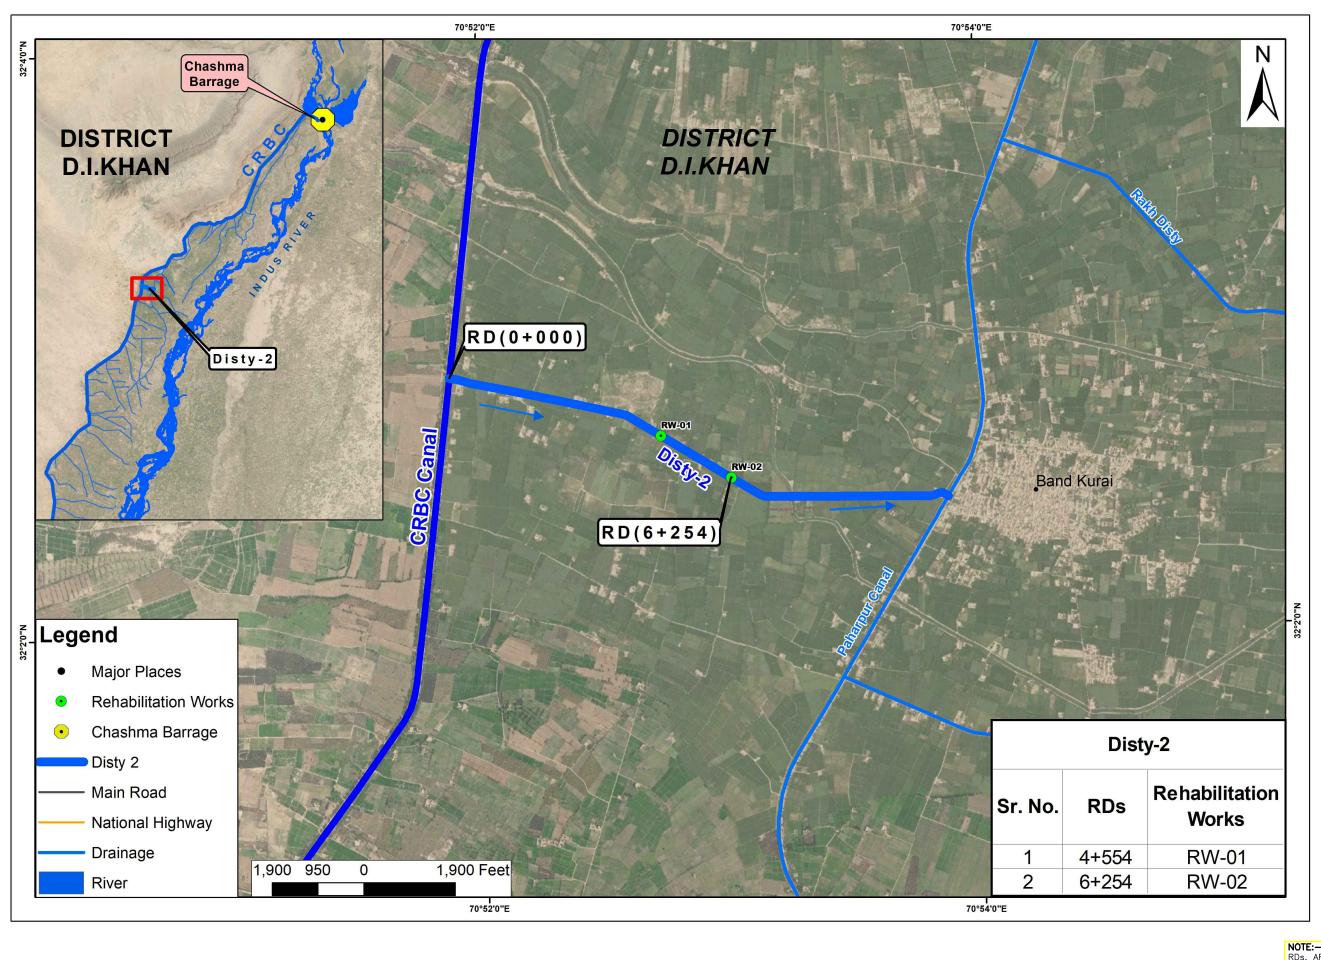

EMERGENCY FLOOD ASSISTANCE PROJECT (EFAP)-KP
"RECONSTRUCTION AND REHABILITATION OF
IRRIGATION AND DRAINAGE SYSTEM AND FLOOD
PROTECTION WORKS IN KHYBER PAKHUNKHWA"


GOVERNMENT OF KHYB
PAKHTUNKHWA
IRRIGATION DEPARTME

							DRAWN	K.A
BER							SUBMITTED	M.M
							RECOMMENDED	Q.L
ENT							CHD/VER	F.R.K
	REV.	DATE	DESCRIPTION	BY	CKD.	APPR.	APPROVED	N.A

NATIONAL ENGINEERING SERVICES PAKISTAN (PVT) LIMITED

LOCATION MAP FOR REHABILITATION OF DAMAGED / WASHED AWAY CANAL SECTION OF DISTY-2

HEAD OFFICE : NESPAK HOUSE, 1-C BLOCK N, MODEL TOWN EXTENSION, LAHORE PAKISTAN DRAWING NO.

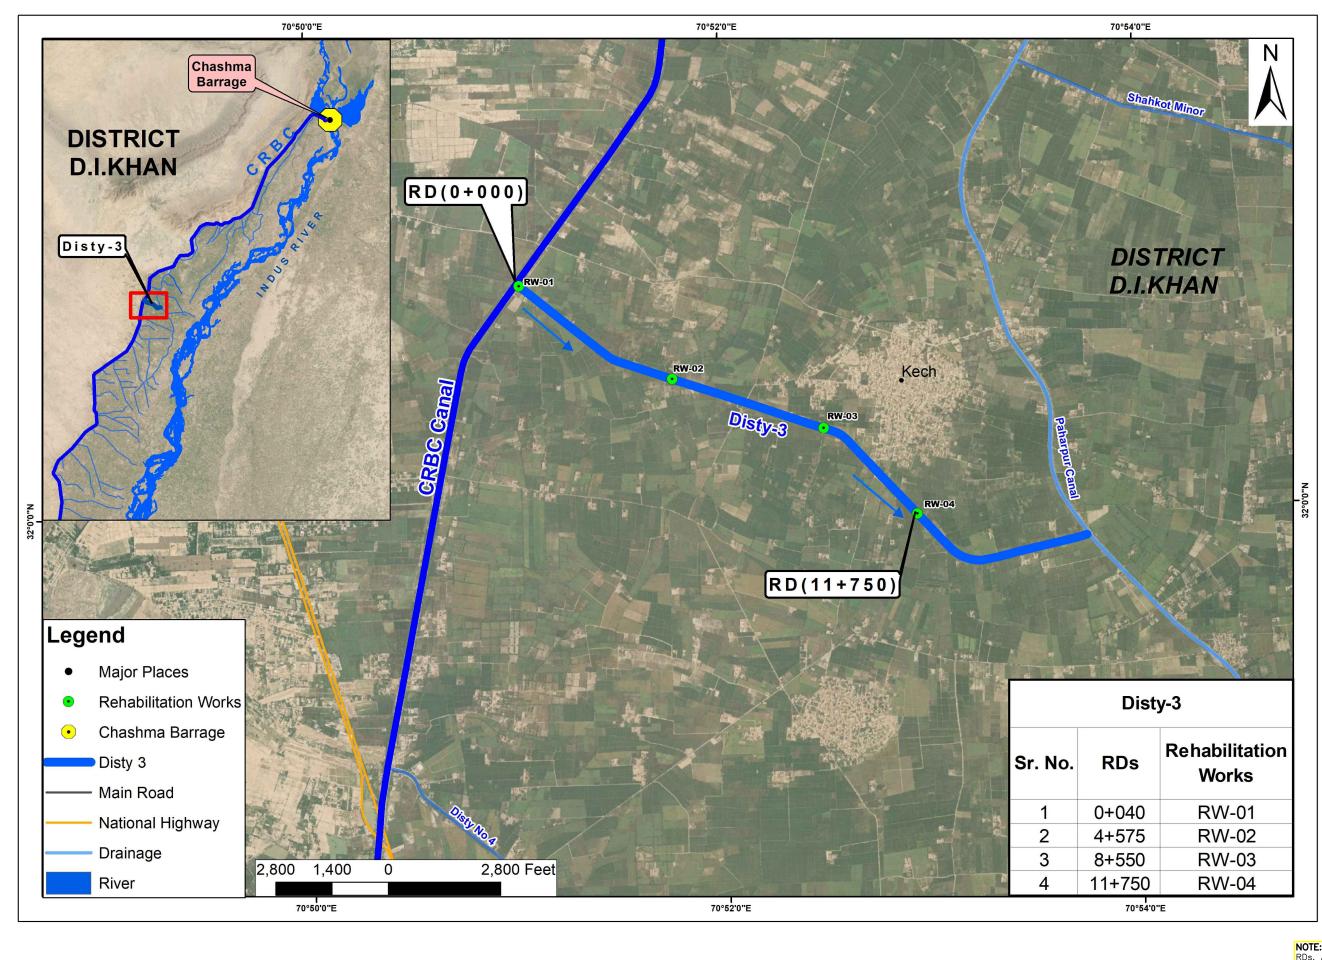

EMERGENCY FLOOD ASSISTANCE PROJECT (EFAP)-KP "RECONSTRUCTION AND REHABILITATION OF IRRIGATION AND DRAINAGE SYSTEM AND FLOOD PROTECTION WORKS IN KHYBER PAKHUNKHWA"

GOVERNMENT OF KHYBER PAKHTUNKHWA IRRIGATION DEPARTMENT


							DRAWN	K.A
₹							SUBMITTED	M.M
							RECOMMENDED	Q.L
Γ							CHD/VER	F.R.K
	REV.	DATE	DESCRIPTION	BY	CKD.	APPR.	APPROVED	N.A

NATIONAL ENGINEERING SERVICES PAKISTAN (PVT) LIMITED

LOCATION MAP FOR REHABILITATION OF DAMAGED / WASHED AWAY CANAL SECTION OF DISTY-3

HEAD OFFICE: NESPAK HOUSE, 1-C BLOCK N, MODEL TOWN EXTENSION, LAHORE PAKISTAN

DRAWING NO. 4593/TD/061/LM-15

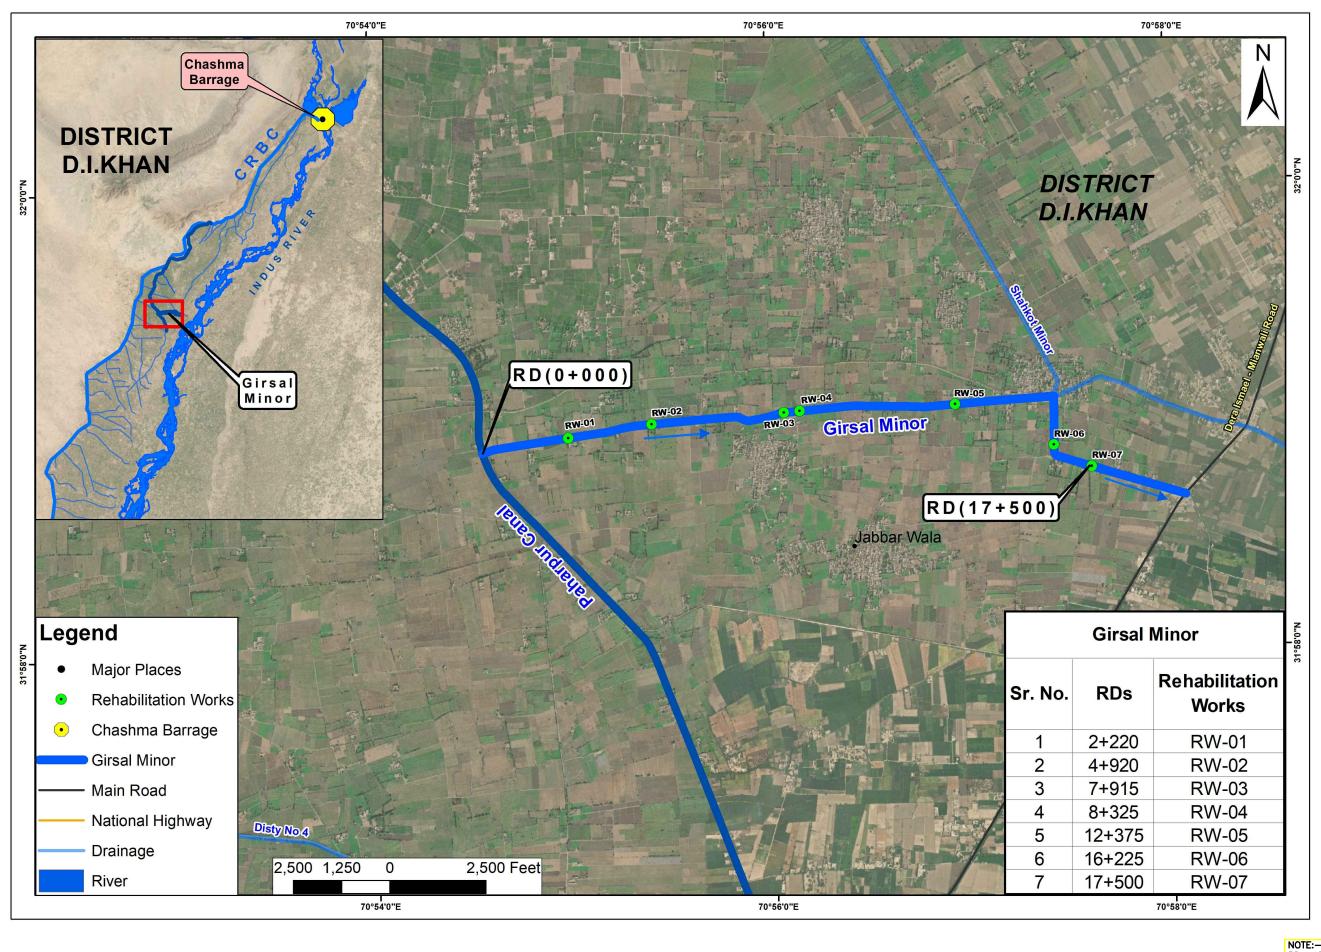

EMERGENCY FLOOD ASSISTANCE PROJECT (EFAP)-KP "RECONSTRUCTION AND REHABILITATION OF **IRRIGATION AND DRAINAGE SYSTEM AND FLOOD** PROTECTION WORKS IN KHYBER PAKHUNKHWA"



GOVERNI PAK IRRIGATION


							DRAWN	K.A
MENT OF KHYBER							SUBMITTED	M.M
KHTUNKHWA							RECOMMENDED	Q.L
ION DEPARTMENT							CHD/VER	F.R.K
	REV.	DATE	DESCRIPTION	BY	CKD.	APPR.	APPROVED	N.A

NATIONAL ENGINEERING SERVICES PAKISTAN (PVT) LIMITED

LOCATION MAP FOR REHABILITATION OF DAMAGED / WASHED AWAY DRAINS SECTION OF GIRSAL MINOR

HEAD OFFICE: NESPAK HOUSE, 1-C BLOCK N, MODEL TOWN EXTENSION, LAHORE PAKISTAN

DRAWING NO. 4593/TD/061/LM-16

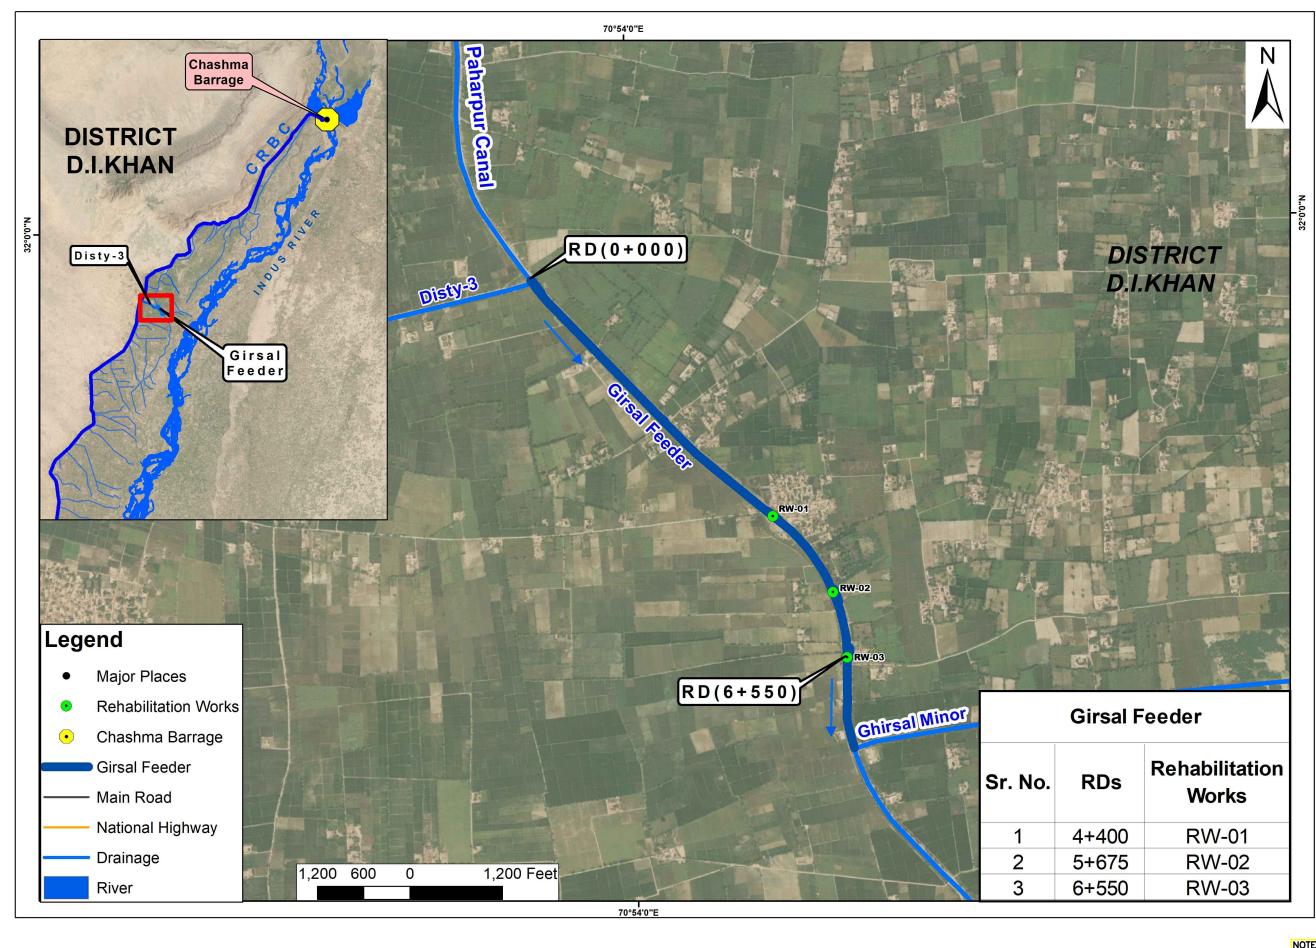

EMERGENCY FLOOD ASSISTANCE PROJECT (EFAP)-KP
"RECONSTRUCTION AND REHABILITATION OF
IRRIGATION AND DRAINAGE SYSTEM AND FLOOD
PROTECTION WORKS IN KHYBER PAKHUNKHWA"



GOVERNMENT OF KHYBER PAKHTUNKHWA IRRIGATION DEPARTMENT


						DRAWN	K.A
						SUBMITTED	M.M
						RECOMMENDED	Q.L
						CHD/VER	F.R.K
REV.	DATE	DESCRIPTION	BY	CKD.	APPR.	APPROVED	N.A

NATIONAL ENGINEERING SERVICES PAKISTAN (PVT) LIMITED

LOCATION MAP FOR REHABILITATION OF DAMAGED / WASHED AWAY DRAINS SECTION OF GIRSAL FEEDER

DATE. HEAD OFFICE: NESPAK HOUSE, 1-C BLOCK N, MODEL TOWN EXTENSION, LAHORE PAKISTAN

DRAWING NO.

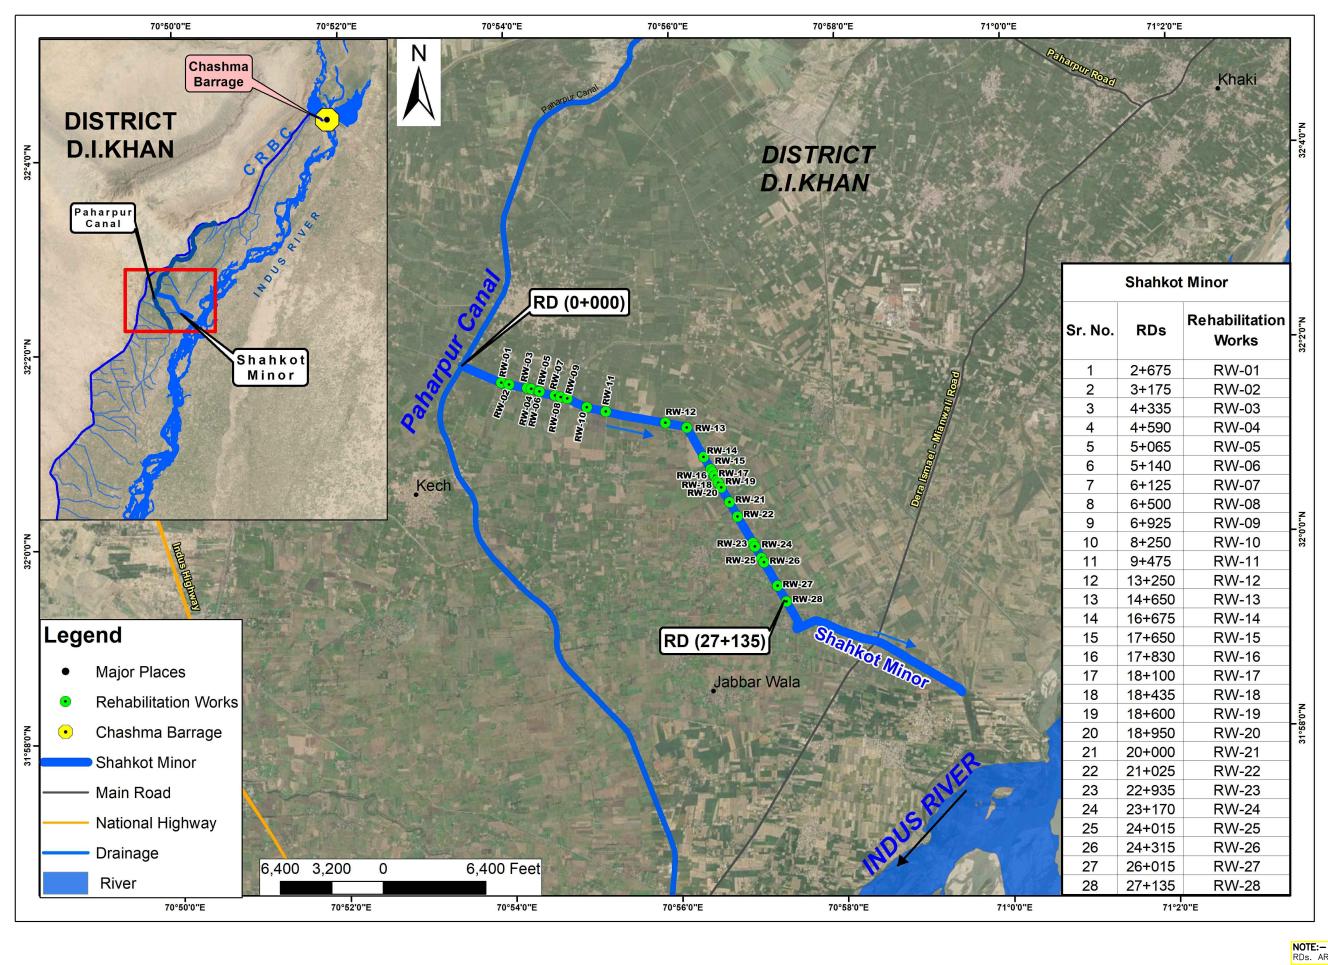

EMERGENCY FLOOD ASSISTANCE PROJECT (EFAP)-KP "RECONSTRUCTION AND REHABILITATION OF **IRRIGATION AND DRAINAGE SYSTEM AND FLOOD** PROTECTION WORKS IN KHYBER PAKHUNKHWA'

GOVERNME **PAKHT IRRIGATION**


							DRAWN	K.A
NT OF KHYBER							SUBMITTED	M.M
TUNKHWA							RECOMMENDED	Q.L
N DEPARTMENT							CHD/VER	F.R.K
	REV.	DATE	DESCRIPTION	BY	CKD.	APPR.	APPROVED	N.A

NATIONAL ENGINEERING SERVICES PAKISTAN (PVT) LIMITED

LOCATION MAP FOR REHABILITATION OF DAMAGED / WASHED AWAY **CANAL SECTION OF SHAH KOT MINOR**

DATE. HEAD OFFICE: NESPAK HOUSE, 1-C BLOCK N, MODEL TOWN EXTENSION, LAHORE PAKISTAN

DRAWING NO.

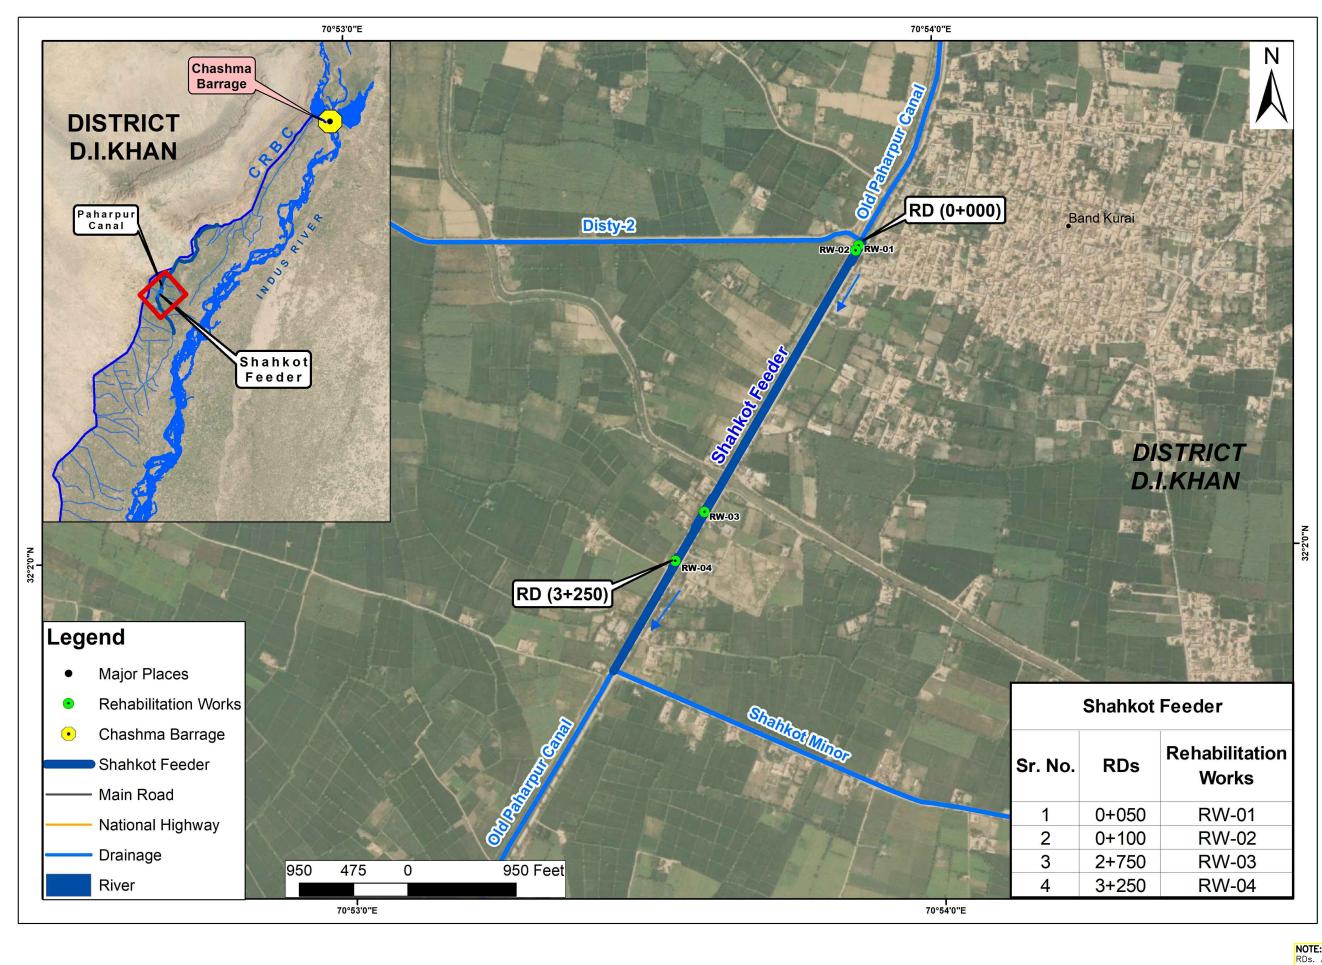

EMERGENCY FLOOD ASSISTANCE PROJECT (EFAP)-KP
"RECONSTRUCTION AND REHABILITATION OF
IRRIGATION AND DRAINAGE SYSTEM AND FLOOD
PROTECTION WORKS IN KHYBER PAKHUNKHWA"



GOVERNMENT OF KHYBI
PAKHTUNKHWA
IRRIGATION DEPARTMEN


							DRAWN	K.A
YBER							SUBMITTED	M.M
							RECOMMENDED	Q.L
MENT							CHD/VER	F.R.K
	REV	DATE	DESCRIPTION	BY	CKD	APPR	APPROVED	NΔ

NATIONAL ENGINEERING SERVICES PAKISTAN (PVT) LIMITED

HEAD OFFICE : NESPAK HOUSE, 1-C BLOCK N, MODEL TOWN EXTENSION, LAHORE PAKISTAN

LOCATION MAP FOR REHABILITATION OF DAMAGED / WASHED AWAY CANAL SECTION OF SHAHKOT FEEDER

DATE. DRAWING NO.

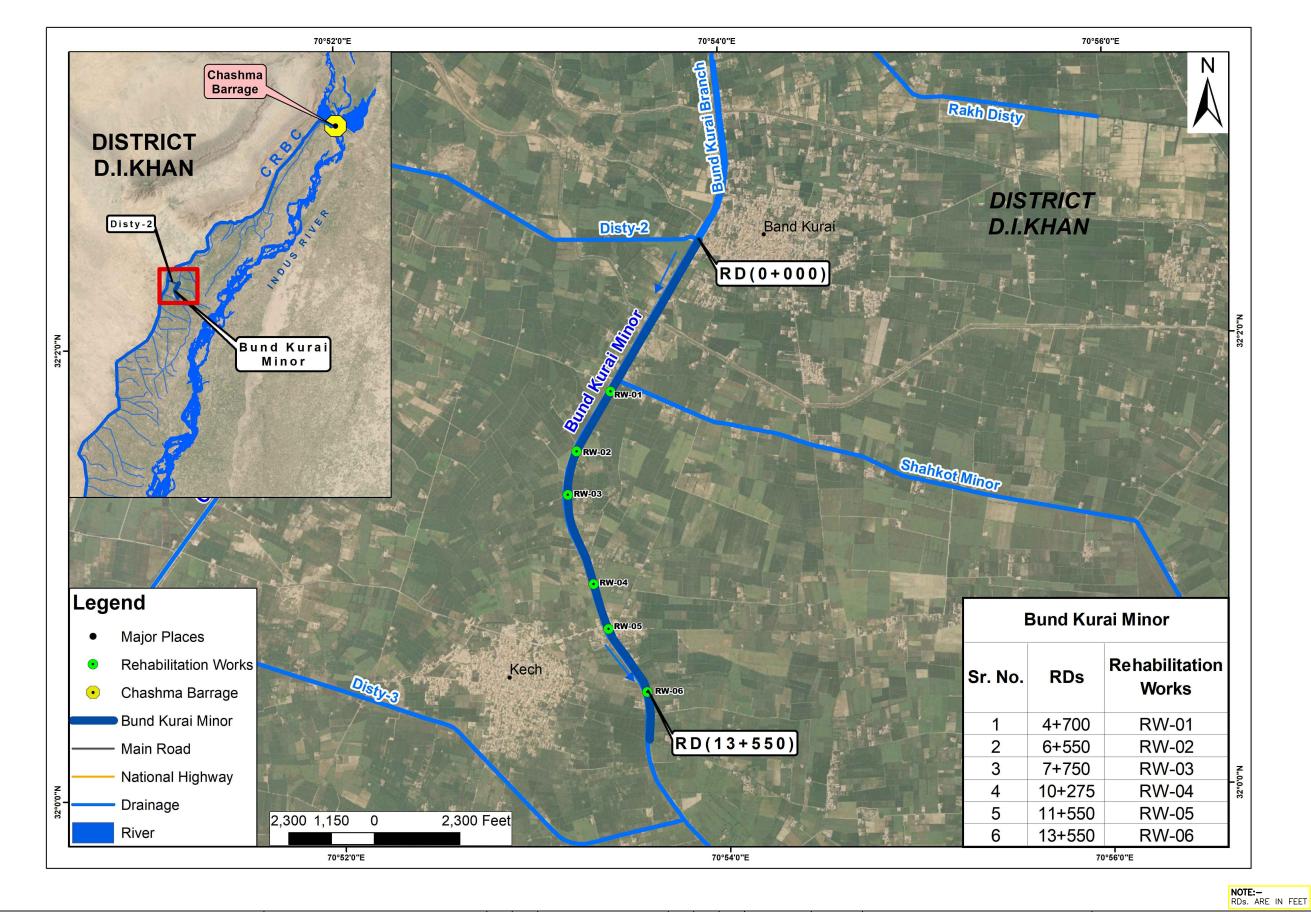

DESCRIPTION

BY CKD. APPR.

GOVERNMENT OF KHYBER PAKHTUNKHWA

SUBMITTED M.M RECOMMENDED Q.L HD/VER F.R.K

NATIONAL ENGINEERING SERVICES PAKISTAN (PVT) LIMITED


LOCATION MAP FOR REHABILITATION OF DAMAGED / WASHED AWAY CANAL SECTION OF BUND KURAI MINOR

DRAWING NO. 4593/TD/061/LM-20 SEP, 2023

EMERGENCY FLOOD ASSISTANCE PROJECT (EFAP)-KP
"RECONSTRUCTION AND REHABILITATION OF
IRRIGATION AND DRAINAGE SYSTEM AND FLOOD
PROTECTION WORKS IN KHYBER PAKHUNKHWA"



HEAD OFFICE : NESPAK HOUSE, 1-C BLOCK N, MODEL TOWN EXTENSION, LAHORE PAKISTAN

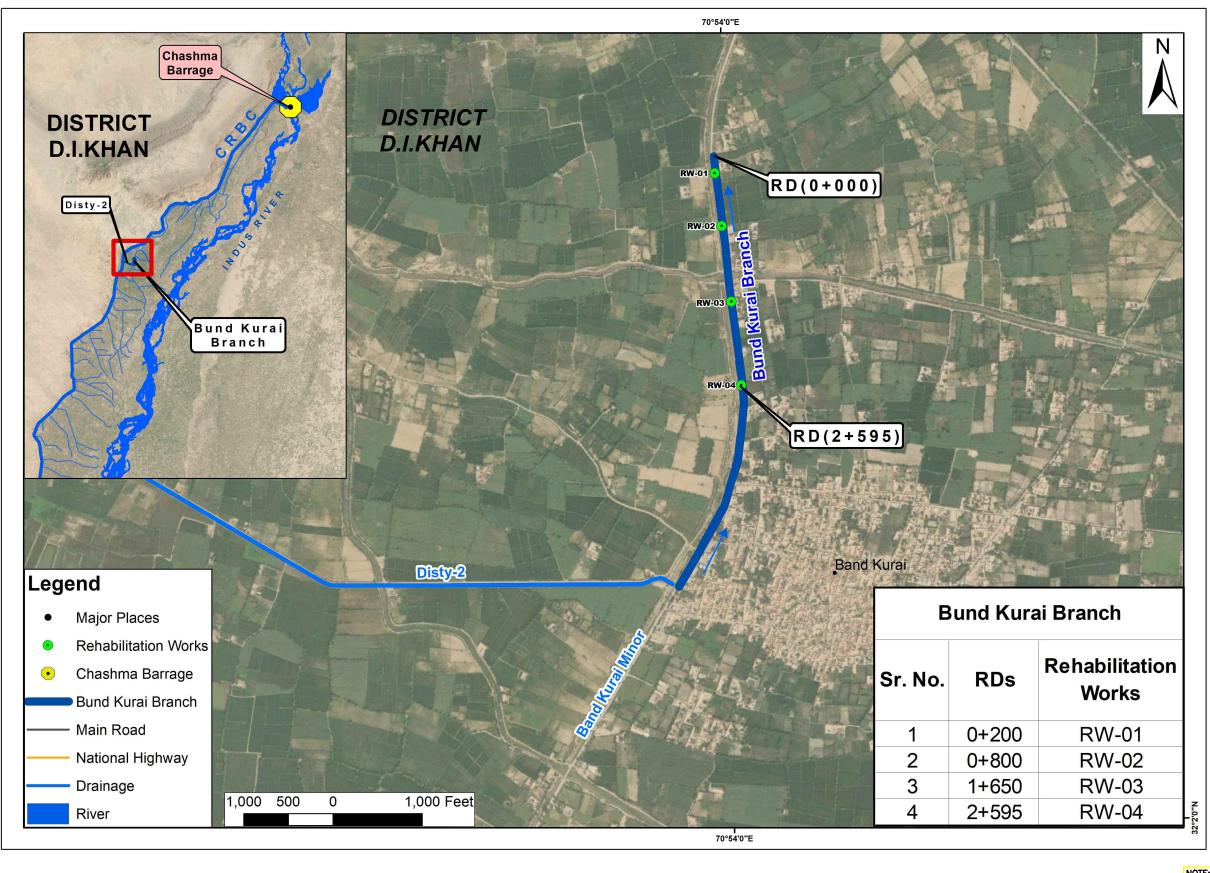

EMERGENCY FLOOD ASSISTANCE PROJECT (EFAP)-KP
"RECONSTRUCTION AND REHABILITATION OF
IRRIGATION AND DRAINAGE SYSTEM AND FLOOD
PROTECTION WORKS IN KHYBER PAKHUNKHWA"


GOVERNMENT OF KHYBER PAKHTUNKHWA IRRIGATION DEPARTMENT

						DRAWN	K.A
						SUBMITTED	M.M
						RECOMMENDED	Q.L
						CHD/VER	F.R.K
REV.	DATE	DESCRIPTION	BY	CKD.	APPR.	APPROVED	N.A

NATIONAL ENGINEERING SERVICES PAKISTAN (PVT) LIMITED

LOCATION MAP FOR REHABILITATION OF DAMAGED / WASHED AWAY CANAL SECTION OF BUND KURAI BRANCH

DRAWING NO. HEAD OFFICE : NESPAK HOUSE, 1-C BLOCK N, 4593/TD/061/LM-21 MODEL TOWN EXTENSION, LAHORE PAKISTAN SEP, 2023

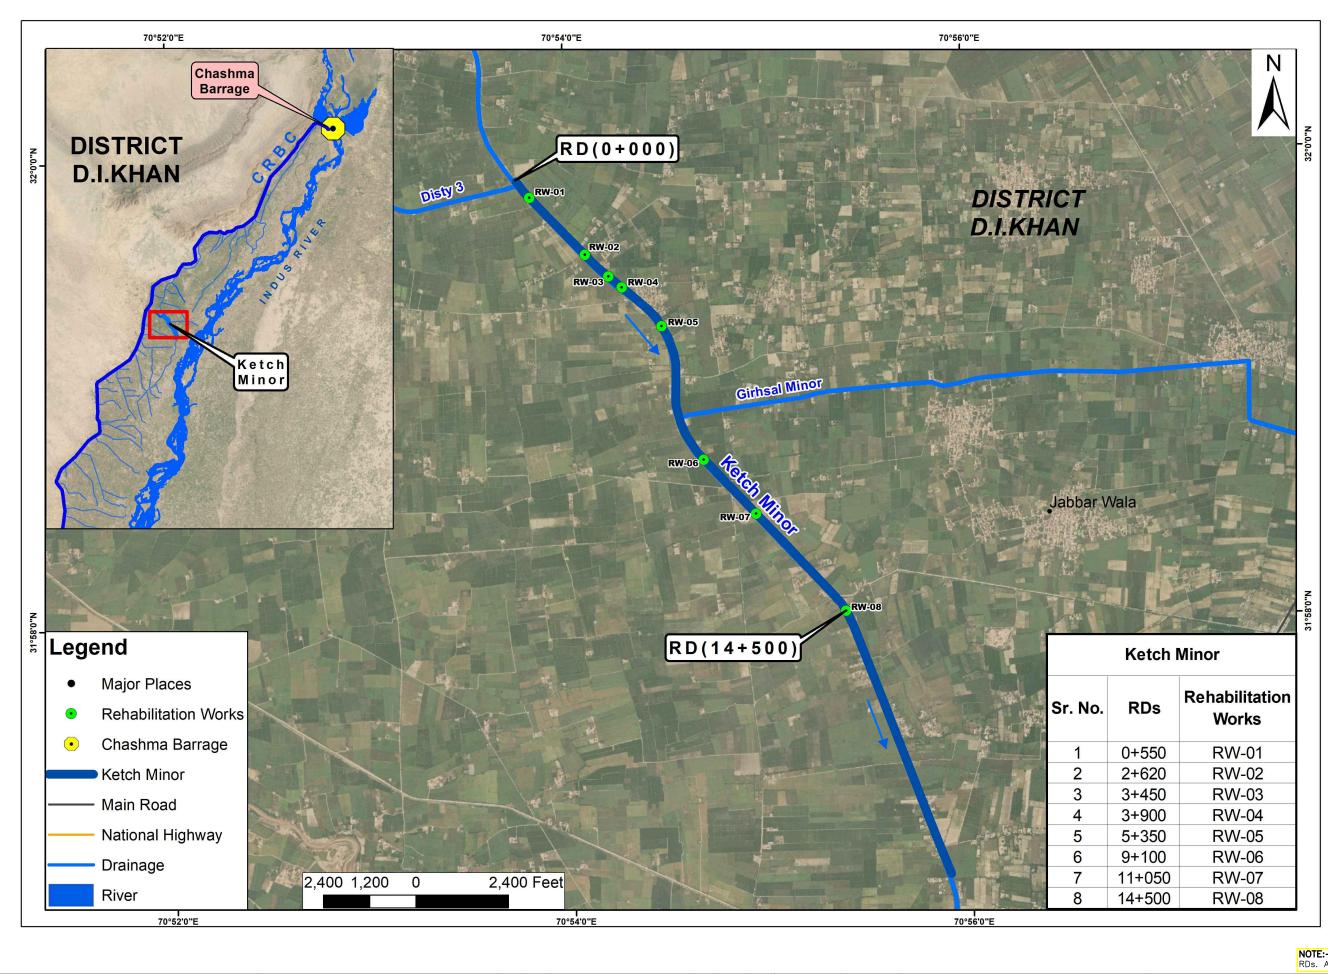

EMERGENCY FLOOD ASSISTANCE PROJECT (EFAP)-KP
"RECONSTRUCTION AND REHABILITATION OF
IRRIGATION AND DRAINAGE SYSTEM AND FLOOD
PROTECTION WORKS IN KHYBER PAKHUNKHWA"




GOVERNMENT OF KHYBER
PAKHTUNKHWA
IRRIGATION DEPARTMENT

						DRAWN	K.A
						SUBMITTED	M.M
						RECOMMENDED	Q.L
						CHD/VER	F.R.K
REV.	DATE	DESCRIPTION	BY	CKD.	APPR.	APPROVED	N.A

NATIONAL ENGINEERING SERVICES PAKISTAN (PVT) LIMITED LOCATION MAP FOR REHABILITATION OF DAMAGED / WASHED AWAY CANAL SECTION OF KETCH MINOR

HEAD OFFICE : NESPAK HOUSE, 1-C BLOCK N, MODEL TOWN EXTENSION, LAHORE PAKISTAN DATE. DRAWING NO.

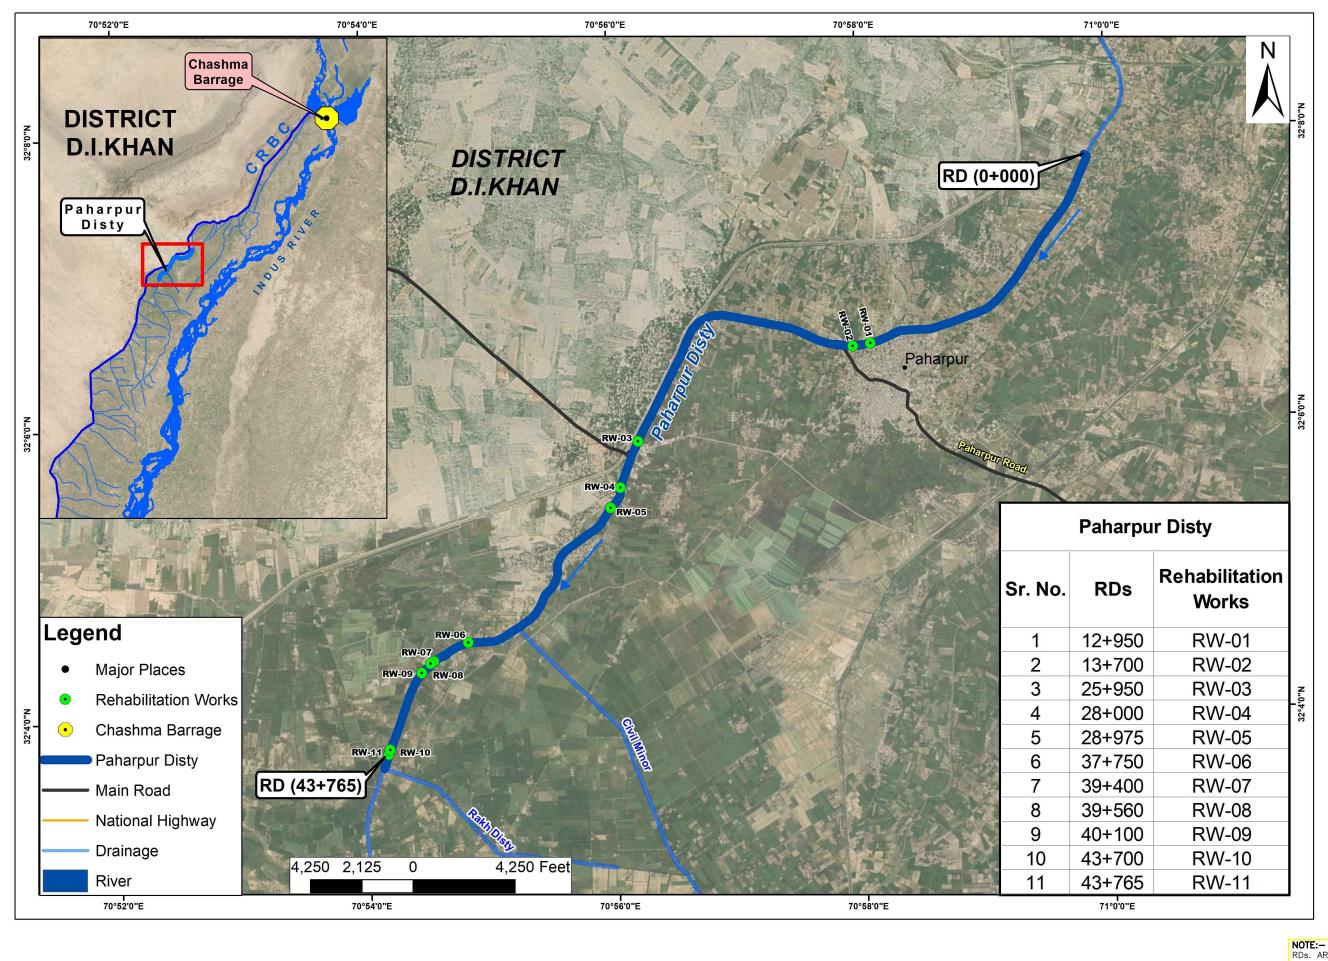

EMERGENCY FLOOD ASSISTANCE PROJECT (EFAP)-KP "RECONSTRUCTION AND REHABILITATION OF **IRRIGATION AND DRAINAGE SYSTEM AND FLOOD** PROTECTION WORKS IN KHYBER PAKHUNKHWA"



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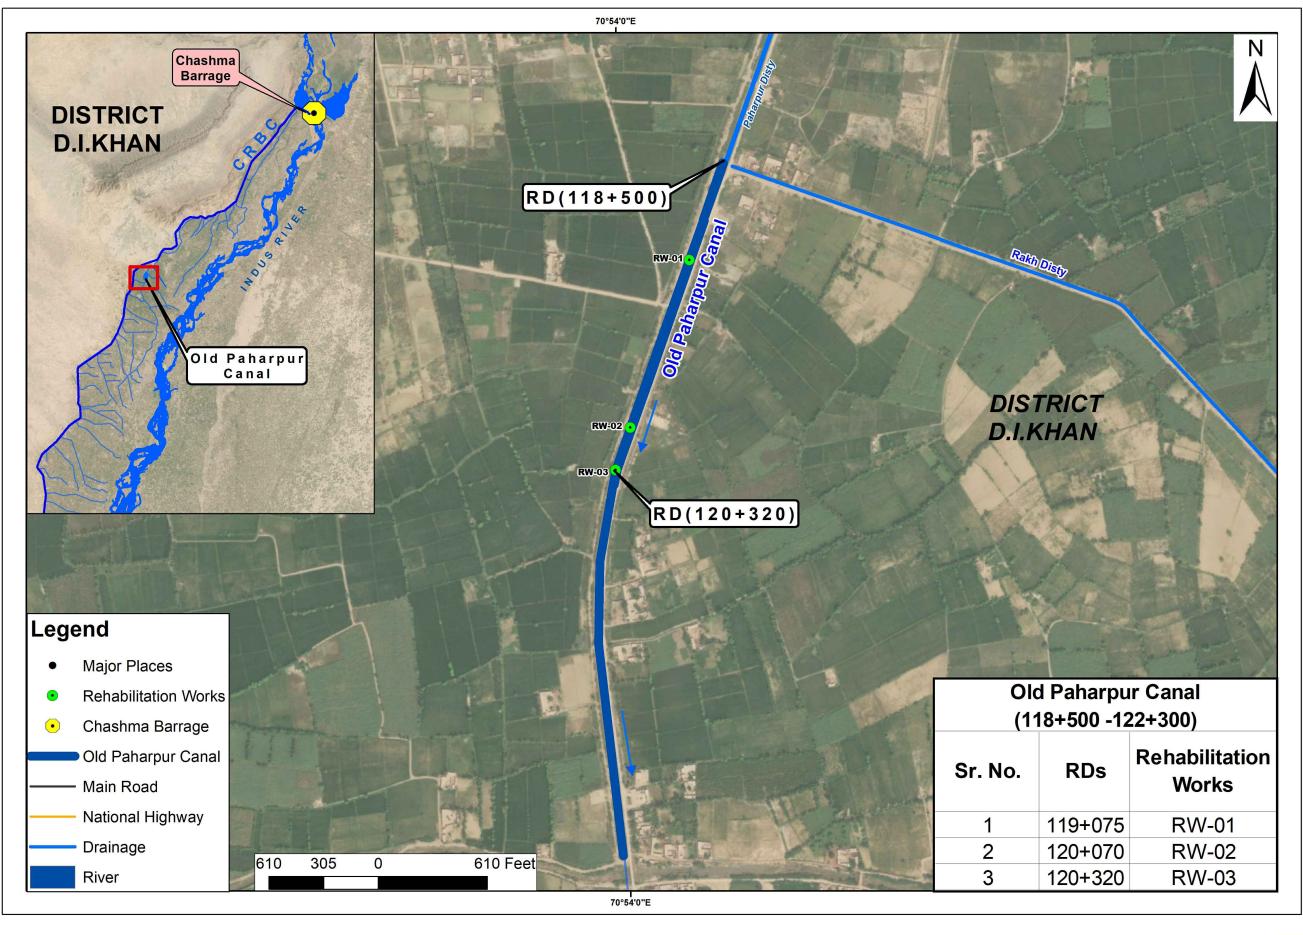
							DRAWN	K.A
VERNMENT OF KHYBER							SUBMITTED	M.M
PAKHTUNKHWA							RECOMMENDED	Q.L
IGATION DEPARTMENT							CHD/VER	F.R.K
	REV.	DATE	DESCRIPTION	BY	CKD.	APPR.	APPROVED	N.A

NATIONAL ENGINEERING SERVICES PAKISTAN (PVT) LIMITED

LOCATION MAP FOR REHABILITATION OF DAMAGED / WASHED AWAY CANAL SECTION OF PAHARPUR DISTY

HEAD OFFICE: NESPAK HOUSE, 1-C BLOCK N, MODEL TOWN EXTENSION, LAHORE PAKISTAN

DRAWING NO.



EMERGENCY FLOOD ASSISTANCE PROJECT (EFAP)-KP
"RECONSTRUCTION AND REHABILITATION OF
IRRIGATION AND DRAINAGE SYSTEM AND FLOOD
PROTECTION WORKS IN KHYBER PAKHUNKHWA"


GOV IRRI

							DRAWN	K.A
VERNMENT OF KHYBER							SUBMITTED	M.M
PAKHTUNKHWA							RECOMMENDED	Q.L
RIGATION DEPARTMENT							CHD/VER	F.R.K
	REV.	DATE	DESCRIPTION	BY	CKD.	APPR.	APPROVED	N.A

NATIONAL ENGINEERING SERVICES PAKISTAN (PVT)

HEAD OFFICE: NESPAK HOUSE, 1-C BLOCK N, MODEL TOWN EXTENSION, LAHORE PAKISTAN

LOCATION MAP FOR REHABILITATION OF DAMAGED / WASHED AWAY CANAL SECTION OF OLD PAHARPUR CANAL RD (118+500-122+300) RD (110+000-124+000) IN REACHES

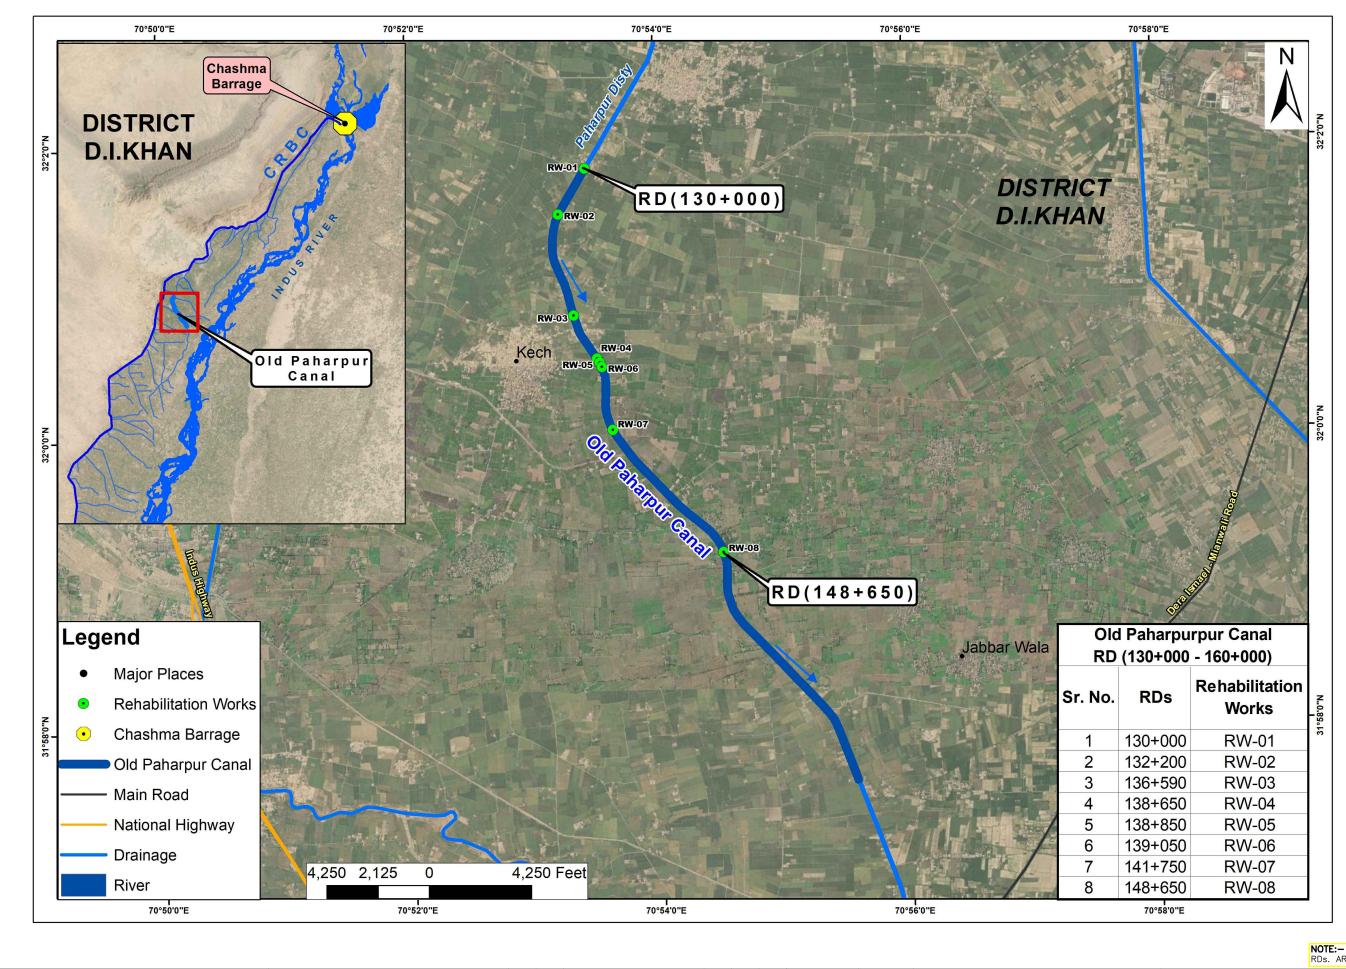


EMERGENCY FLOOD ASSISTANCE PROJECT (EFAP)-KP "RECONSTRUCTION AND REHABILITATION OF **IRRIGATION AND DRAINAGE SYSTEM AND FLOOD** PROTECTION WORKS IN KHYBER PAKHUNKHWA"

GOVERNMENT OF KHYBER PAKHTUNKHWA IRRIGATION DEPARTMENT

						DRAWN	K.A
						SUBMITTED	M.M
						RECOMMENDED	Q.L
						CHD/VER	F.R.K
REV.	DATE	DESCRIPTION	BY	CKD.	APPR.	APPROVED	N.A

NATIONAL ENGINEERING SERVICES PAKISTAN (PVT) LIMITED

HEAD OFFICE: NESPAK HOUSE, 1-C BLOCK N, MODEL TOWN EXTENSION, LAHORE PAKISTAN LOCATION MAP
FOR REHABILITATION OF DAMAGED / WASHED AWAY
CANAL SECTION OF OLD PAHARPUR CANAL RD (130+000-160+000)

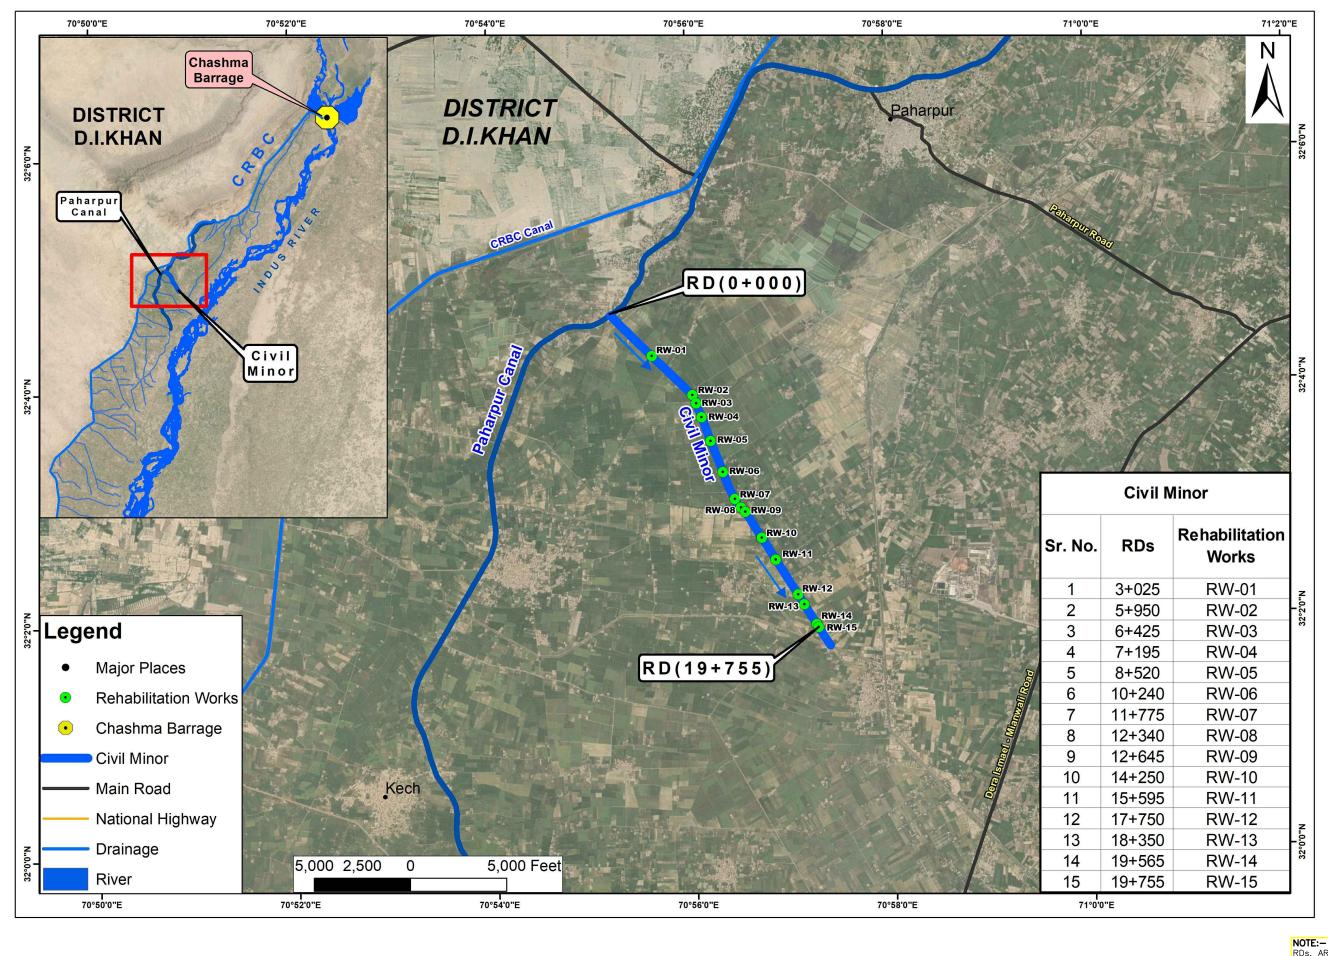

EMERGENCY FLOOD ASSISTANCE PROJECT (EFAP)-KP "RECONSTRUCTION AND REHABILITATION OF **IRRIGATION AND DRAINAGE SYSTEM AND FLOOD** PROTECTION WORKS IN KHYBER PAKHUNKHWA"

GOVERNMENT OF KHYBER PAKHTUNKHWA IRRIGATION DEPARTMENT


							DRAWN	K.A
R							SUBMITTED	M.M
							RECOMMENDED	Q.L
T							CHD/VER	F.R.K
	RFV.	DATE	DESCRIPTION	BY	CKD.	APPR.	APPROVED	N.A

NATIONAL ENGINEERING SERVICES PAKISTAN (PVT) LIMITED

LOCATION MAP FOR REHABILITATION OF DAMAGED / WASHED AWAY CANAL SECTION OF CIVIL MINOR

DATE. HEAD OFFICE: NESPAK HOUSE, 1-C BLOCK N, MODEL TOWN EXTENSION, LAHORE PAKISTAN

DRAWING NO.

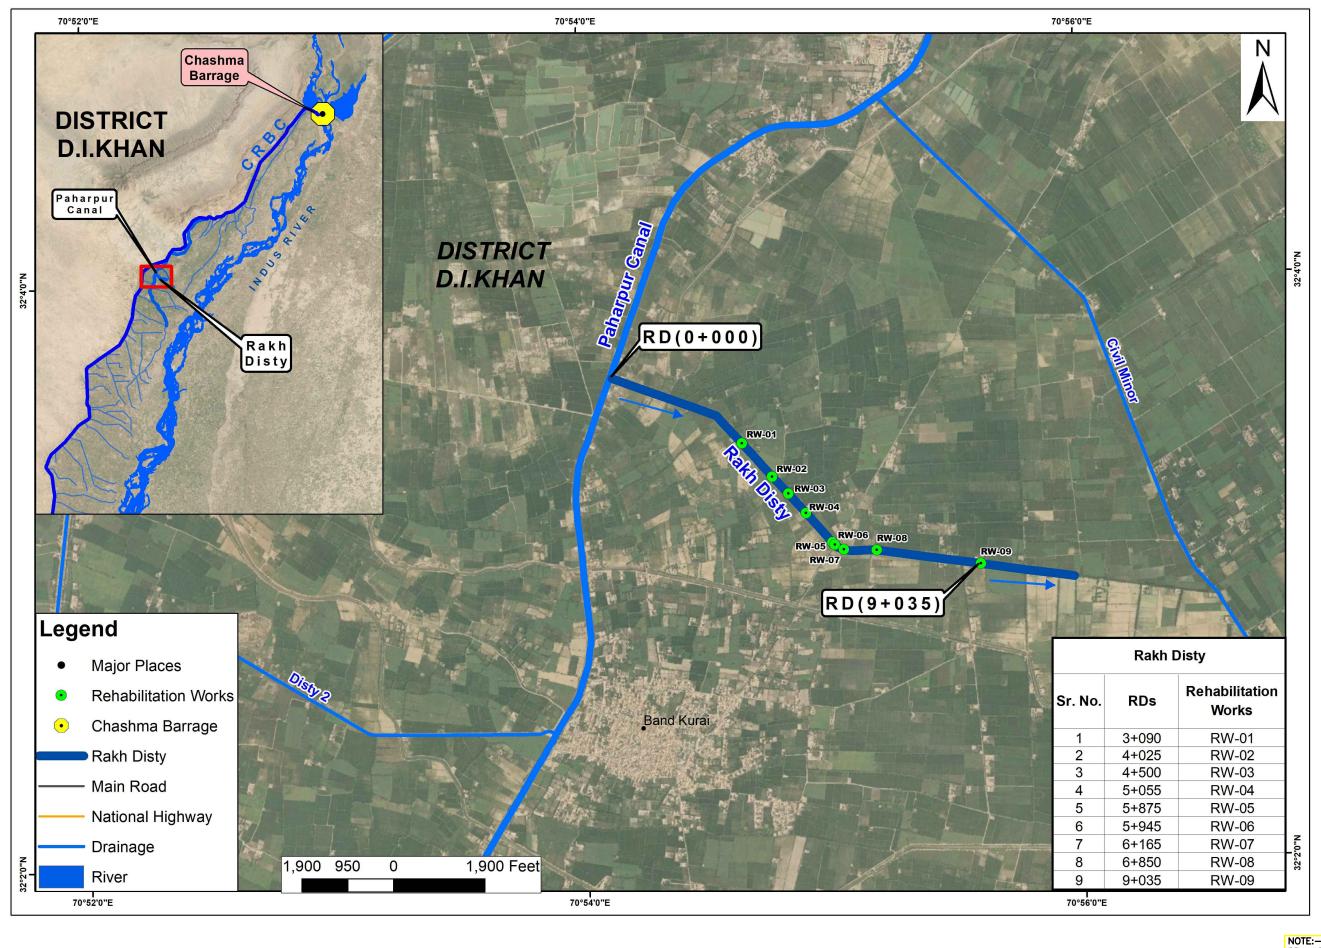

EMERGENCY FLOOD ASSISTANCE PROJECT (EFAP)-KP "RECONSTRUCTION AND REHABILITATION OF **IRRIGATION AND DRAINAGE SYSTEM AND FLOOD** PROTECTION WORKS IN KHYBER PAKHUNKHWA"


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							DRAWN	K.A
OVERNMENT OF KHYBER							SUBMITTED	M.M
PAKHTUNKHWA							RECOMMENDED	Q.L
RIGATION DEPARTMENT							CHD/VER	F.R.K
	REV.	DATE	DESCRIPTION	BY	CKD.	APPR.	APPROVED	N.A

NATIONAL ENGINEERING SERVICES PAKISTAN (PVT) LIMITED

HEAD OFFICE: NESPAK HOUSE, 1-C BLOCK N, MODEL TOWN EXTENSION, LAHORE PAKISTAN LOCATION MAP FOR REHABILITATION OF DAMAGED / WASHED AWAY CANAL SECTION OF RAKH DISTY

DRAWING NO. DATE.

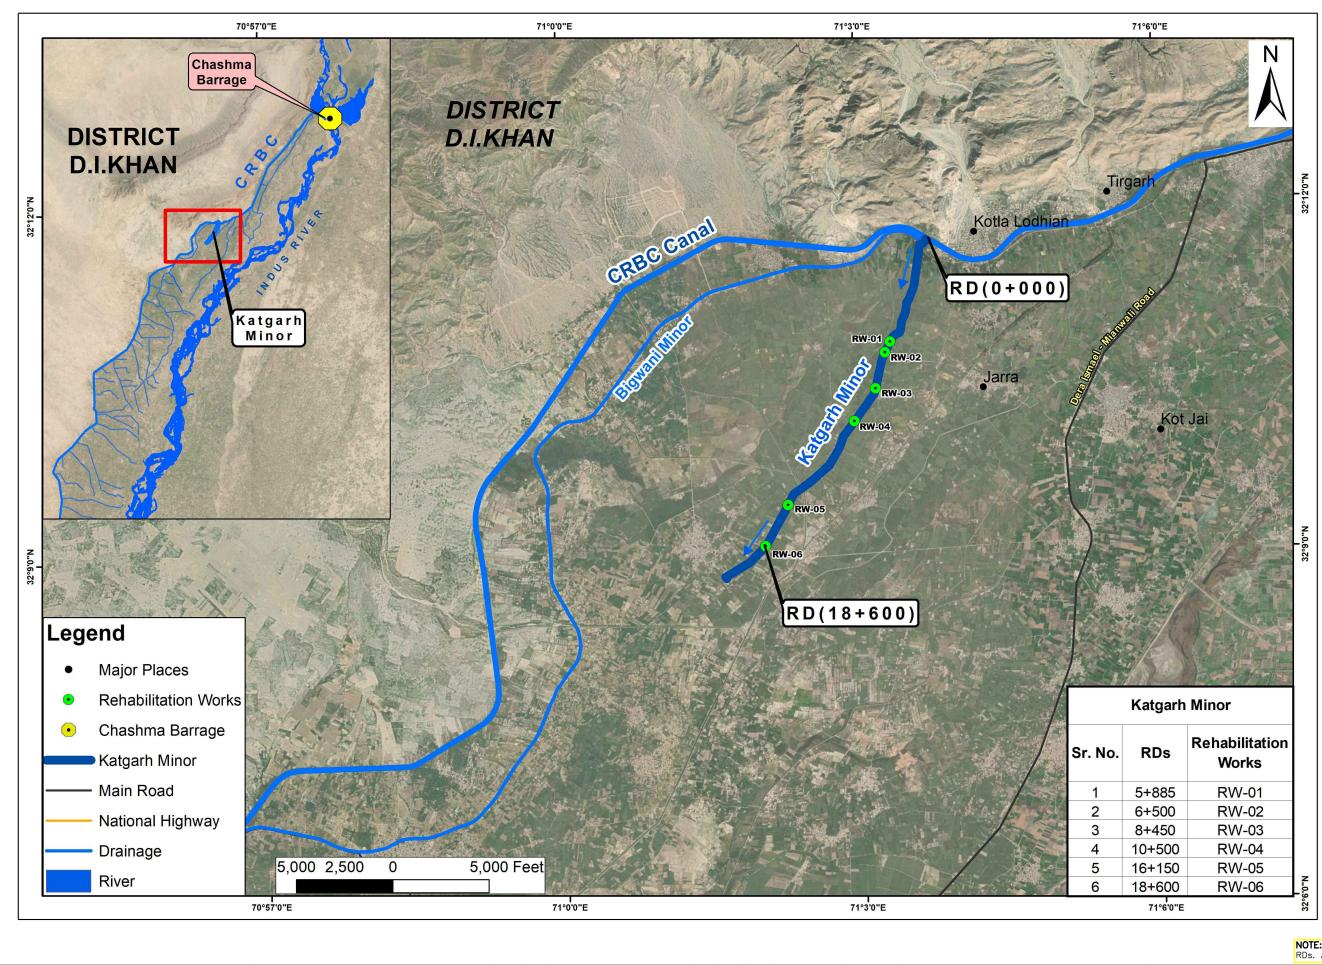

EMERGENCY FLOOD ASSISTANCE PROJECT (EFAP)-KP "RECONSTRUCTION AND REHABILITATION OF IRRIGATION AND DRAINAGE SYSTEM AND FLOOD PROTECTION WORKS IN KHYBER PAKHUNKHWA"

GOVERNMENT OF KHYB PAKHTUNKHWA IRRIGATION DEPARTME


							DRAWN	K.A
BER							SUBMITTED	M.M
							RECOMMENDED	Q.L
ENT							CHD/VER	F.R.K
	REV.	DATE	DESCRIPTION	BY	CKD.	APPR.	APPROVED	N.A

NATIONAL ENGINEERING SERVICES PAKISTAN (PVT) LIMITED HEAD OFFICE: NESPAK HOUSE, 1-C BLOCK N,

LOCATION MAP FOR REHABILITATION OF DAMAGED / WASHED AWAY CANAL SECTION OF KAT GARH MINOR

MODEL TOWN EXTENSION, LAHORE PAKISTAN

DRAWING NO.

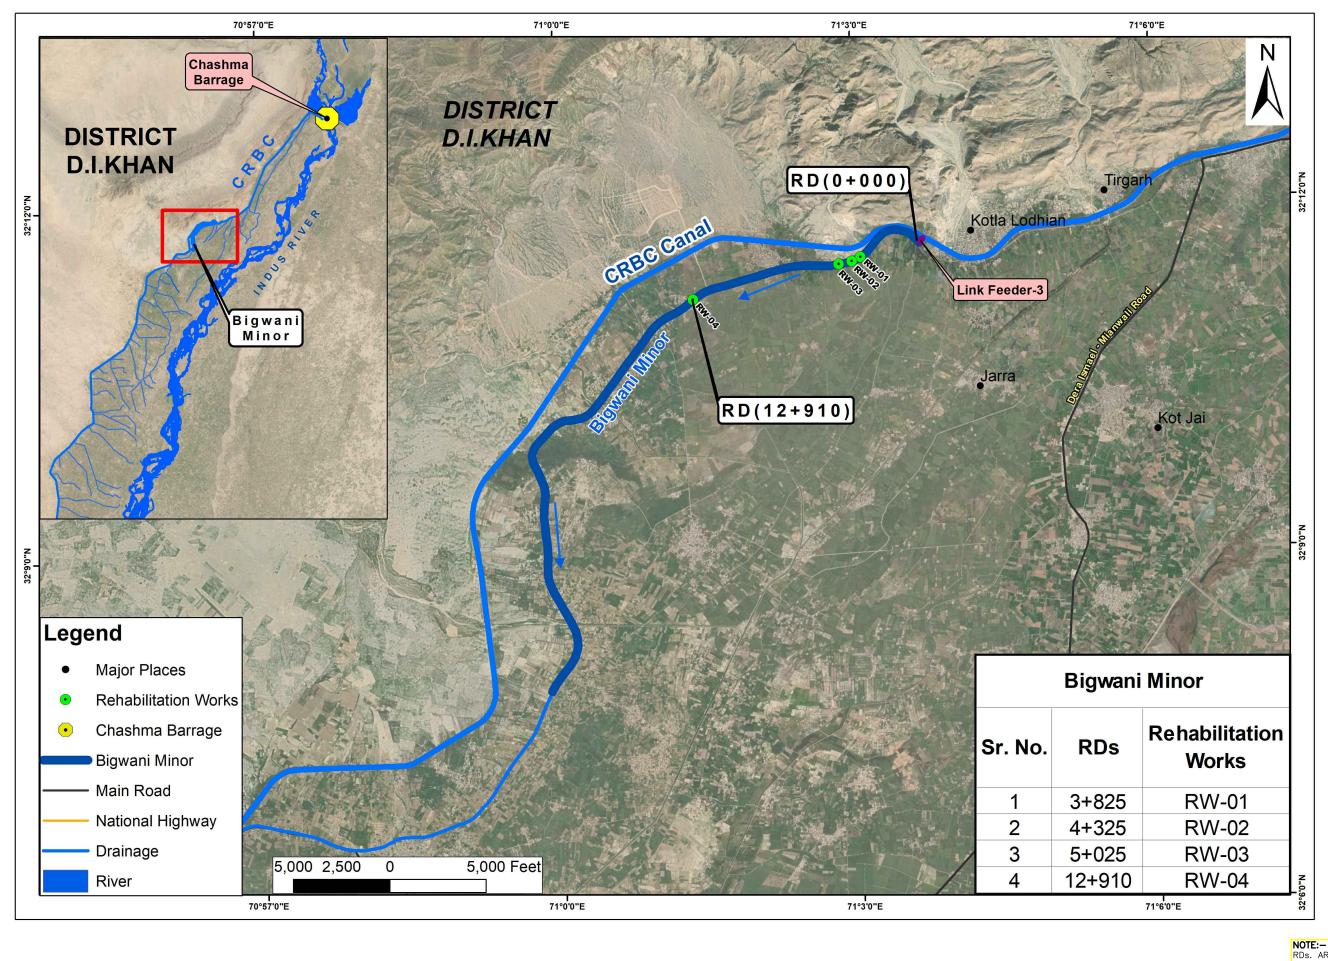

EMERGENCY FLOOD ASSISTANCE PROJECT (EFAP)-KP
"RECONSTRUCTION AND REHABILITATION OF
IRRIGATION AND DRAINAGE SYSTEM AND FLOOD
PROTECTION WORKS IN KHYBER PAKHUNKHWA"




GOVERNMENT OF KHYBER PAKHTUNKHWA IRRIGATION DEPARTMENT

							DRAWN	K.A
R							SUBMITTED	M.M
							RECOMMENDED	Q.L
T							CHD/VER	F.R.K
	REV.	DATE	DESCRIPTION	BY	CKD.	APPR.	APPROVED	N.A

NATIONAL ENGINEERING SERVICES PAKISTAN (PVT)

LOCATION MAP FOR REHABILITATION OF DAMAGED / WASHED AWAY CANAL SECTION OF BIGWANI MINOR

HEAD OFFICE: NESPAK HOUSE, 1-C BLOCK N, MODEL TOWN EXTENSION, LAHORE PAKISTAN DRAWING NO.

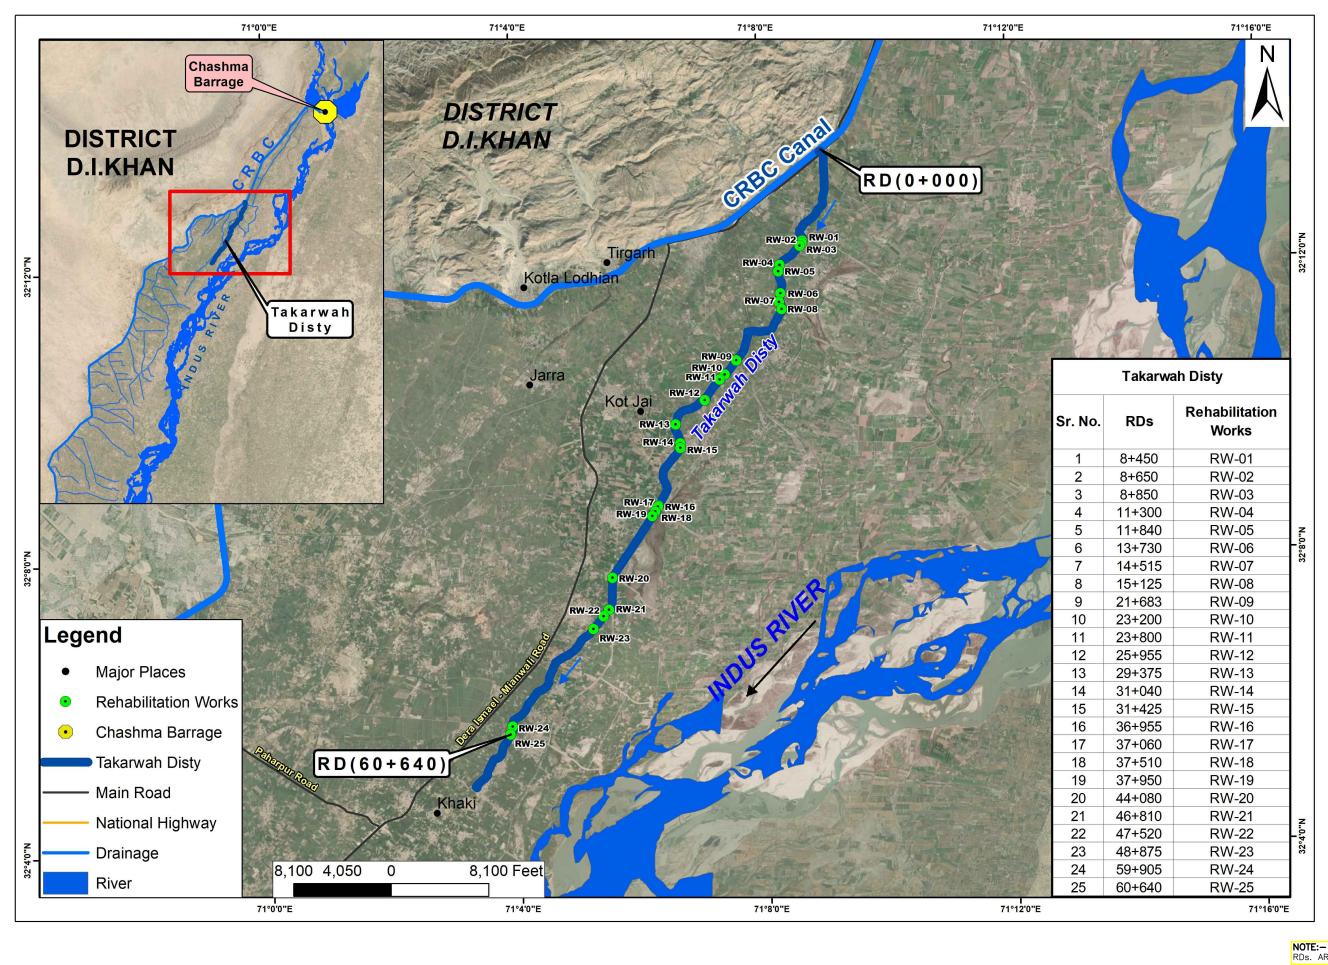

EMERGENCY FLOOD ASSISTANCE PROJECT (EFAP)-KP "RECONSTRUCTION AND REHABILITATION OF **IRRIGATION AND DRAINAGE SYSTEM AND FLOOD** PROTECTION WORKS IN KHYBER PAKHUNKHWA'



GOVERNMENT O PAKHTUNK IRRIGATION DEP

							DRAWN	K.A
OF KHYBER							SUBMITTED	M.M
KHWA							RECOMMENDED	Q.L
PARTMENT							CHD/VER	F.R.K
	REV.	DATE	DESCRIPTION	BY	CKD.	APPR.	APPROVED	N.A



MODEL TOWN EXTENSION, LAHORE PAKISTAN

LOCATION MAP FOR REHABILITATION OF DAMAGED / WASHED AWAY CANAL SECTION OF TAKARWAH DISTY

DRAWING NO. DATE.

	List of Proposed Restoration/Rehabilitation Works of Distributary-02																
	BD*			Coord	inates		Type of	Length of		Type of	Proosed	Design	Existing	Top of	Exisitng	Proposed	
Sr. No.	Start Coordinates		End Co	ordinates	Rehab. Works	Rehab. Work	Side	Channel	Bed Width	Bed Level	Bed Level	Lining	Bank Level	Bank Level	Refernce Drawing No.		
			Easting	Northing	Easting	Northing		L									
(-)	(ft)	(-)	(ft)	(ft)	(ft)	(ft)	(-)	(ft)	(-)	(-)	(ft)	(ft)	(ft)	(ft)	(ft)	(ft)	(-)
1	4+554	RW1	2221458	11637328	2223451	11636201	CI	2508	RS	Unlined	6.30	600.81	602.82	604.81	609.46	609.46	4503/TD/061/PW/-03
							- CL			3S Channel				0.64 604.32 605.05 605.32	- 4593/TD/061/RW-03		

SP = Side Protection

RR =Road Restorartion

BR = Bank Restoration

CL = Concrete Lining

WR = Wall Raising

DC = Desilting Channel

NOTES:

DATE.

ALL RDs/Coordinates should be confirmed by site engineer before construction.

EMERGENCY FLOOD ASSISTANCE PROJECT (EFAP)-KP
"RECONSTRUCTION AND REHABILITATION OF
IRRIGATION AND DRAINAGE SYSTEM AND FLOOD PROTECTION WORKS IN KHYBER PAKHUNKHWA"



							DRAWN	K.A
R							SUBMITTED	M.M
							RECOMMENDED	Q.L
Τ							CHD/VER	F.R.K
	REV.	DATE	DESCRIPTION	BY	CKD.	APPR.	APPROVED	N.A



TABLE OF DETAILS
FOR REHABILITATION OF DAMAGED / WASHED AWAY
CANAL SECTION OF DISTY-2

					L	IST OF P	ROPOSE	D REHABI	LITAT	ION WORKS O	F DISTR	RIBUTAR	Y-3			
				Coord	inates						Propos	ed Design D	Data			
Sr. No.	RD*	ID	Start Cod	ordinates	End Cod	ordinates	Type of Rehab.	Length of Rehab.Work	Side	Type of Channel	Designed Bed	Exisitng Bed Level	Top of Lining	Existing	Proposed Bank Level	Refernce Drawing No.
			Easting	Northing	Easting	Northing	Works	L			Level	Bed Level	Lilling	Balik Level	Dank Level	
(-)	(ft)	(-)	(ft)	(ft)	(ft)	(ft)	(-)	(ft)	(-)	(-)	(ft)	(ft)	(ft)	(ft)	(ft)	(-)
1	0+040	RW-01	2213746	11626198	2213878	11626103	RW	80	L	Brick R/W Side	607.42	607.57	612.42	614.23	614.42	4593/TD/061/RW-03
2	4+575	RW-02	2217442	11623911	2217629	11623848	RW	50	R	Protection	599.44	598.17	604.36	605.29	606.36	4393/10/001/KVV-03
3	8+550	RW-05	2217534	11623879	2224314	11619897	RR	8100	L	Road Rehabilitation	595.69	595.25	600.57	601.66	602.57	Shingle Road
4	11+750	RW-06	2223002	11621271	2224456	11619756	CL	2100	L&R	Concrete Lining	593.39	591.88	597.92	597.55	599.92	4593/TD/061/RW-02

SP = Side Protection

RR =Road Restorartion

BR = Bank Restoration

NOTES:

SEP, 2023

ALL RDs/Coordinates should be confirmed by site engineer before construction.

						DRAWN	K.A
						SUBMITTED	M.M
						RECOMMENDED	Q.L
						CHD/VER	F.R.K
REV.	DATE	DESCRIPTION	BY	CKD.	APPR.	APPROVED	N.A

						LIST OF	PROPOS	SED REHAE	BILITA	TION WORKS	OF GIRS	SAL MINO	R			
				Coord	linates						Propos	sed Design D	ata			
Sr. No.	RD*	ID	Start Co	ordinates	End Cod	ordinates	Type of Rehab.	Length of Rehab.Work	Side	Type of Channel	Designed Bed	Exisitng	Top of	Existing	Proposed Bank Level	Refernce Drawing No.
			Easting	Northing	Easting	Northing	Works	L			Level	Bed Level	Lining	Bank Level	Dalik Level	
(-)	(ft)	(-)	(ft)	(ft)	(ft)	(ft)	(-)	(ft)	(-)	(-)	(ft)	(ft)	(ft)	(ft)	(ft)	(-)
1	2+220	RW-01	2234413	11614366	2234452	11614372	RR	40	L	Road Restoration	585.15	585.20	588.86	588.79	590.86	
2	4+920	RW-02	2237078	11614766	2237118	11614770	RR	40	L	Road Restoration	584.56	583.89	588.27	589.07	590.27	
3	7+915	RW-03	2240025	11615032	2240055	11615035	RR	30	L	Road Restoration	583.20	583.58	586.80	587.33	588.80	Asphalt Road
4	8+325	RW-04	2240423	11615072	2240473	11615077	RR	50	L	Road Restoration	583.14	583.17	586.74	587.79	588.74	
5	12+375	RW-05	2244463	11615254	2244512	11615259	RR	50	L	Road Restoration	582.26	582.07	585.76	586.03	587.76	
6	16+225	RW-06	2247046	11615430	2248041	11613652	CL	2500		Concrete PCC Lining	579.26	580.15	582.66	584.99	584.66	4593/TD/061/RW-02
7	17+500	RW-07	2247046	11615430	2250443	11612964	RR	5000	L	Road Restoration	578.97	579.42	582.37	585.08	584.37	Asphalt Road

SP = Side Protection

RR = Road Restorartion

BR = Bank Restoration

NOTES:

SEP, 2023

ALL RDs/Coordinates should be confirmed by site engineer before construction.



	HEV.	DATE	DESCRIPTION	Dī	CKD.	APPR.	APPROVED	N.A
	REV.	DATE	DESCRIPTION	BY	CKD.	APPR.	ADDDOVED	N.A
Γ							CHD/VER	F.R.K
							RECOMMENDED	Q.L
₹							SUBMITTED	M.M
							DRAWN	K.A



					LIST (OF PROP	OSED R	EHABILIT	ATIO	N WORKS OF	GIRSAL	FEEDER			
				Coord	inates						Proposed D	Design Data			
Sr. No.	RD*	ID	Start Cod	ordinates	End Coo	ordinates	Type of Rehab.	Length of Rehab.Work	Side	Type of	Exisitng	Top of	Existing	Proposed	Refernce Drawing No.
			Easting	Northing	Easting	Northing	Works	L		Rehabilitation	Bed Level	Lining / Wall	Bank Level	Bank Level	•
(-)	(ft)	(-)	(ft)	(ft)	(ft)	(ft)	(-)	(ft)	(-)	(-)	(ft)	(ft)	(ft)	(ft)	(-)
1	4+400	RW-01	2231068	11617051	2231221	11616923	SP	200	L&R	Brick R/W Side Protection	586.51	590.01	591.93	592.01	
2	5+675	RW-02	2231915	11616073	2231958	11615937	SP+RR	150	L	Brick R/W Side Protection+Road	589.97	593.47	594.85	595.47	4593/TD/061/RW-03
3	6+550	RW-03	2232104	11615203	2232103	11615103	SP+RR	100	L	Rehabilitation	587.34	590.84	593.88	593.88	

SP = Side Protection

RR = Road Restorartion

BR = Bank Restoration

NOTES:

ALL RDs/Coordinates should be confirmed by site engineer before construction.

DATE.

2. The Client did not provide the Consultants with the required L-sections of the canal, despite a request made in letter No. 4593/064/NKA/01/18 dated 23-8-23. As a result of the unavailability of the L-section, the Consultants were unable to retrieve the last design level data. However, the Consultants have deducted 1-2ft from the existing bed level to arrive at probable last design bed level, following instructions from the Client during a meeting held at NESPAK House on September 14, 2023.

EMERGENCY FLOOD ASSISTANCE PROJECT (EFAP)-KP "RECONSTRUCTION AND REHABILITATION OF **IRRIGATION AND DRAINAGE SYSTEM AND FLOOD** PROTECTION WORKS IN KHYBER PAKHUNKHWA"



							DRAWN	K.A
₹							SUBMITTED	M.M
							RECOMMENDED	Q.L
Γ							CHD/VER	F.R.K
	REV.	DATE	DESCRIPTION	BY	CKD.	APPR.	APPROVED	N.A



TABLE OF DETAILS FOR REHABILITATION OF DAMAGED / WASHED AWAY CANAL SECTION OF GIRSAL FEEDER

HEAD OFFICE: NESPAK HOUSE, 1-C BLOCK N, MODEL TOWN EXTENSION, LAHORE PAKISTAN DRAWING NO.

				Coord	linates					ATION WORKS OF SE		Design Data	1			
C. N.	DD*	I.D.			IIIIates		Time of	I a mostle of				Design Date	•	<u> </u>		
Sr. No.	RD*	ID	Start Cod			ordinates	Type of Rehab. Works	Length of Rehab.Work	Side	Type of Rehabilitation	Designed Bed Level	Exisitng Bed Level	Top of Lining	Existing Bank Level	Proposed Bank Level	Refernce Drawing No.
(-)	(ft)	(-)	Easting (ft)	Northing (ft)	Easting (ft)	Northing (ft)	(-)	L (ft)	(-)	(-)	(ft)	(ft)	(ft)	(ft)	(ft)	(-)
1	2+675	RW-01	2228619	11630779	2228665	11630760	RR	50	R	Road Rehabilitation	587.31	587.31	590.81	592.70	592.81	Road Rehabilitation
•							SP									
2	3+175	RW-02	2229100	11630654	2229149	11630646		50	R	Concrete Side Protection	587.48	587.48	590.98	592.23	592.98	4593/TD/061/RW-01-B
3	4+335	RW-03	2230249	11630436	2230279	11630430	RR	30	R		586.95	586.95	590.45	592.20	592.45	
4	4+590	RW-04	2230495	11630390	2230543	11630377	RR	40	R	Road Rehabilitation	587.13	587.13	590.63	592.35	592.63	Road Rehabilitation
5	5+065	RW-05	2230952	11630243	2230980	11630234	RR	30	R		586.97	586.97	590.47	591.62	592.47	
6	5+140	RW-06	2230999	11630227	2231075	11630203	SP	80	L&R	Compute Cide Bustastics	586.81	586.81	590.31	591.95	592.31	4500/TD/004/D\N/ 04 0
7	6+125	RW-07	2231964	11629971	2232013	11629960	SP	50	L&R	Concrete Side Protection	587.48	587.48	590.98	591.51	592.98	4593/TD/061/RW-01-C
8	6+500	RW-08	2231866	11629991	2232838	11629761	RR	1000	R	Road Rehabilitation	586.71	586.71	590.21	591.33	592.21	Road Rehabilitation
9	6+925	RW-09	2232696	11629807	2232838	11629761	SP	150	L&R	Concrete Side Protection	586.63	586.63	590.13	590.76	592.13	4593/TD/061/RW-01-C
10	8+250	RW-10	2233288	11629544	2234706	11629083	RR	1500	R	Road Rehabilitation	585.29	585.29	588.79	590.33	590.79	Road Rehabilitation
11	9+475	RW-11	2235097	11628997	2235243	11628964	SP	150	L&R	Concrete Side Protection	585.40	585.40	588.90	589.84	590.90	4593/TD/061/RW-01-C
12	13+250	RW-12	2237646	11628489	2240108	11628056	RR	2500	R	Road Rehabilitation	584.89	584.89	588.39	587.21	590.39	Road Rehabilitation
13	14+650	RW-13	2240196	11628014	2240247	11627928	RR&SP	100	R	Road Rehabilitation+Concrete Side Protection With Side Wall	584.90	584.90	588.40	589.20	590.40	4593/TD/061/RW-01-D
14	16+675	RW-14	2241187	11626276	2241261	11626146	SP	150	R		-	-	-	-	-	
15	17+650	RW-15	2241682	11625407	2241731	11625320	SP	100	R			_		_	_	4500 TD (004 DIM 04 D
16	17+830	RW-16	2241761	11625268	2241832	11625147	SP	140	R	Raising Wall	_	_		_	_	4593/TD/061/RW-01-D (DETAIL D)
														_	_	
17	18+100	RW-17	2241883	11625061	2241984	11624889	SP	200	R		-	-	-	-	-	
18	18+435	RW-18	2242085	11624716	2242121	11624656	RR&SP	70	L&R	Road Rehabilitation+Concrete Side Protection With Side Wall	583.37	583.37	586.87	588.67	588.87	4593/TD/061/RW-01-D
19	18+600	RW-19	2242162	11624587	2242212	11624501	SP	100	R		-	-	-	-	-	
20	18+950	RW-20	2242288	11624372	2242441	11624113	SP	300	R	Raising Wall	-	-	-	-	-	4593/TD/061/RW-01-D (DETAIL D)
21	20+000	RW-21	2242632	11623762	2243130	11622895	SP	1000	R		583.16	583.16	586.66	587.21	588.66	(32.7.423)
22	21+025	RW-22	2243377	11622460	2243401	11622416	RR&SP	50	L&R		583.20	583.20	586.70	586.89	588.70	
23	22+935	RW-23	2244330	11620817	2244365	11620756	RR&SP	70	L&R		582.69	582.69	586.19	585.07	588.19	
					2244475											
24	23+170	RW-24	2244455	11620600		11620565	RR&SP	40	L&R	Road Rehabilitation+Concrete	582.71	582.71	586.21	585.69	588.21	4500 75 45 4 7 1 1 1 1
25	24+015	RW-25	2244878	11619863	2244893	11619837	RR&SP	30	L&R	Side Protection With Side Wall	582.29	582.29	585.79	585.66	587.79	4593/TD/061/RW-01-D
26	24+315	RW-26	2245028	11619603	2245043	11619577	RR&SP	30	L&R		582.26	582.26	585.76	586.57	587.76	
27	26+015	RW-27	2245875	11618129	2245890	11618103	RR&SP	30	L&R	582.31	582.31	585.81	585.99	587.81		
28	27+135	RW-28	2246417	11617172	2246452	11617111	RR&SP	70	L&R	582.28	582.28	585.78	585.18	587.78		

SP = Side Protection

NOTES:

ALL RDs/Coordinates should be confirmed by site engineer before construction.

EMERGENCY FLOOD ASSISTANCE PROJECT (EFAP)-KP
"RECONSTRUCTION AND REHABILITATION OF
IRRIGATION AND DRAINAGE SYSTEM AND FLOOD PROTECTION WORKS IN KHYBER PAKHUNKHWA"



							DRAWN	K.A
							SUBMITTED	M.M
							RECOMMENDED	Q.L
							CHD/VER	F.R.K
	REV.	DATE	DESCRIPTION	BY	CKD.	APPR.	APPROVED	N.A
_								



TABLE OF DETAILS FOR REHABILITATION OF DAMAGED / WASHED AW CANAL SECTION OF SHAH KOT MINOR

HEAD OFFICE : NESPAK HOUSE, 1-C BLOCK N, MODEL TOWN EXTENSION, LAHORE PAKISTAN

DATE. DRAWING NO.

RR =Road Restorartion

BR = Bank Restoration

					LIST OF	PROPO	SED REI	HABILITAT	TION V	VORKS OF SH	IAHKOT F	EEDER			
				Coord	inates						Proposed De	esign Data			
Sr. No.	RD*	ID	Start Cod	ordinates	End Coo	rdinates		Length of Rehab.Work	Side	Type of Rehabilitation	Exisitng Bed Level	Top of Lining	Existing Bank Level	Proposed Bank Level	Refernce Drawing No.
			Easting	Northing	Easting	Northing	Works	L							
(-)	(ft)	(-)	(ft)	(ft)	(ft)	(ft)	(-)	(ft)	(-)	(-)	(ft)	(ft)	(ft)	(ft)	(-)
1	0+050	RW-01	2228336	11635605	2228287	11635518	SP	100	L		588.24	591.74	597.99	597.99	
2	0+100	RW-02	2228336	11635605	2228238	11635431	SP	200	R	Brick R/W Side	588.18	591.68	596.46	596.46	4502/TD/064/DML02
3	2+750	RW-03	2227034	11633355	2226885	11633094	SP	300	L	L Protection	588.42	591.92	598.09	598.09	4593/TD/061/RW-03
4	3+250	RW-04	2226736	11632834	2226687	11632747	SP	100	L&R		587.67	591.17	598.20	598.20	

SP = Side Protection

RR = Road Restorartion

BR = Bank Restoration

NOTES:

- ALL RDs/Coordinates should be confirmed by site engineer before construction.
- 2. The Client did not provide the Consultants with the required L-sections of the canal, despite a request made in letter No. 4593/064/NKA/01/18 dated 23-8-23. As a result of the unavailability of the L-section, the Consultants wer unable to retrieve the last design level data. However, the Consultants have deducted 1-2ft from the existing bed level to arrive at probable last design belevel, following instructions from the Client during a meeting held at NESPAK House on September 14, 2023.

EMERGENCY FLOOD ASSISTANCE PROJECT (EFAP)-KP
"RECONSTRUCTION AND REHABILITATION OF
IRRIGATION AND DRAINAGE SYSTEM AND FLOOD
PROTECTION WORKS IN KHYBER PAKHUNKHWA"



							DRAWN	K.A
2							SUBMITTED	M.M
							RECOMMENDED	Q.L
'							CHD/VER	F.R.K
	REV.	DATE	DESCRIPTION	BY	CKD.	APPR.	APPROVED	N.A



TABLE OF DETAILS FOR REHABILITATION OF DAMAGED / WASHED AW CANAL SECTION OF SHAHKOT FEEDER

HEAD OFFICE : NESPAK HOUSE, 1-C BLOCK N, MODEL TOWN EXTENSION, LAHORE PAKISTAN DATE. DRAWING NO. 4593/TD/061/TOD-19

				LIS	ST OF PR	OPOSED R	REHABI	LITATION	WOR	KS OF BUND	KURAI	MINOR			
				Coord	linates						Proposed	Design Data			
Sr. No.	RD*	ID	Start 0	Coordinates	End Co	ordinates	Type of Rehab. Works	Length of Rehab.Work	Side	Type of Channel	Exisitng Bed Level	Top of Lining	Existing Bank Level	Proposed Bank Level	Refernce Drawing No.
			Easting	Northing	Easting	Northing		L							
(-)	(ft)	(-)	(ft)	(ft)	(ft)	(ft)	(-)	(ft)	(-)	(-)	(ft)	(ft)	(ft)	(ft)	(-)
1	4+700	RW-01	2226404	11632127	2225697	11630901	CL	1400	L&R	Concrete Lining	591.34	596.34	597.44	597.44	4593/TD/061/RW-02
2	6+550	RW-02	2225151	11629947	2225108	11629857	SP&BR	100	R	Concrete Side Protection With side walls	591.24	596.24	595.65	598.24	4593/TD/061/RW-01-A
3	7+750	RW-03	2224983	11629477	2224978	11627992	CL	1500	L&R	Concrete Lining	592.24	597.24	595.67	599.24	4593/TD/061/RW-02
4	10+275	RW-04	2225585	11626367	2225599	11626319	BR	50	L&R	Bank Restoration	590.80	595.80	596.09	596.09	
5	11+550	RW-05	2225700	11626003	2226289	11624640	CL	1500	L&R	Concrete Lining	590.70	595.70	594.87	597.70	4502/TD/064/DW/02
6	13+550	RW-06	2226387	11624526	2227098	11622617	CL	1900	L&R	Concrete Lining	589.77	594.77	594.50	596.77	4593/TD/061/RW-02

SP = Side Protecti

RR =Road Restorartion

BR = Bank Restoration

NOTES:

- ALL RDs/Coordinates should be confirmed by site engineer before construction.
- 2. The Client did not provide the Consultants with the required L-sections of the canal, despite a request made in letter No. 4593/064/NKA/01/18 dated 23-8-23. As a result of the unavailability of the L-section, the Consultants were unable to retrieve the last design level data. However, the Consultants have deducted 1-2ft from the existing bed level to arrive at probable last design bed level, following instructions from the Client during a meeting held at NESPAK House on September 14, 2023.

EMERGENCY FLOOD ASSISTANCE PROJECT (EFAP)-KP
"RECONSTRUCTION AND REHABILITATION OF
IRRIGATION AND DRAINAGE SYSTEM AND FLOOD
PROTECTION WORKS IN KHYBER PAKHUNKHWA"



							DRAWN	K.A
R							SUBMITTED	M.M
							RECOMMENDED	Q.L
Τ							CHD/VER	F.R.K
	REV.	DATE	DESCRIPTION	BY	CKD.	APPR.	APPROVED	N.A



TABLE OF DETAILS FOR REHABILITATION OF DAMAGED / WASHED AWAY CANAL SECTION OF BUND KURAI MINOR

HEAD OFFICE : NESPAK HOUSE, 1-C BLOCK N, MODEL TOWN EXTENSION, LAHORE PAKISTAN

DATE. DRAWING NO.

LIST OF PROPOSED REHABILITATION WORKS OF BUND KURAI BRANCH

				Coord	inates						Proposed [Design Data			
Sr. No.	RD*	ID	Start (Coordinates	End Co	oordinates	Type of Rehab. Works	Length of Rehab.Work	Side	Type of Channel	Exisitng Bed Level	Top of Lining	Existing Bank Level	Proposed Bank Level	Refernce Drawing No.
			Easting	Northing	Easting	Northing		L							
(-)	(ft)	(-)	(ft)	(ft)	(ft)	(ft)	(-)	(ft)	(-)	(-)	(ft)	(ft)	(ft)	(ft)	(-)
1	0+200	RW-01	2228821	11640409	2228841	11640009	SP&BR	400	R	Concrete Side Protection With side walls	594.70	599.32	598.03	601.32	4593/TD/061/RW-01-A
2	0+800	RW-02	2228866	11639909	2228932	11639318	CL	600	L&R	Concrete Lining	593.60	598.22	597.33	600.22	4593/TD/061/RW-02-C
3	1+650	RW-03	2228983	11638922	2229035	11638626	SP&BR	300	L&R	Concrete Side Protection With Both side walls	593.11	597.73	596.75	599.73	4502/TD/064/DW 04 C
4	2+595	RW-04	2229090	11637034	2229030	11636867	SP&BR	150	L&R	Concrete Side Protection With Both side walls	593.87	598.49	596.77	600.49	4593/TD/061/RW-01-C

*RDs are taken from the mid of the proposed rehabilitation works

SP = Side Protecti

RR =Road Restorartion

BR = Bank Restoration

NOTES

- ALL RDs/Coordinates should be confirmed by site engineer before construction.
- 2. The Client did not provide the Consultants with the required L-sections of the canal, despite a request made in letter No. 4593/064/NKA/01/18 dated 23-8-23. As a result of the unavailability of the L-section, the Consultants were unable to retrieve the last design level data. However, the Consultants have deducted 1-2ft from the existing bed level to arrive at probable last design bed level, following instructions from the Client during a meeting held at NESPAK House on September 14, 2023.

EMERGENCY FLOOD ASSISTANCE PROJECT (EFAP)-KP
"RECONSTRUCTION AND REHABILITATION OF
IRRIGATION AND DRAINAGE SYSTEM AND FLOOD
PROTECTION WORKS IN KHYBER PAKHUNKHWA"



							DRAWN	K.A
₹							SUBMITTED	M.M
							RECOMMENDED	Q.L
Γ							CHD/VER	F.R.K
	REV.	DATE	DESCRIPTION	BY	CKD.	APPR.	APPROVED	N.A



TABLE OF DETAILS FOR REHABILITATION OF DAMAGED / WASHED AWAY CANAL SECTION OF BUND KURAI BRANCH

HEAD OFFICE : NESPAK HOUSE, 1-C BLOCK N, MODEL TOWN EXTENSION, LAHORE PAKISTAN DATE. DRAWING NO.

				LI	ST OF PF	ROPOSED	REHAB	BILITATIO	N WOF	RKS OF KETO	CH MIN	OR			
				Coord	inates						Proposed	Design Data			
Sr. No.	RD*	ID	Start C	Coordinates	End Co	ordinates	Type of Rehab. Works	Length of Rehab.Work	Side	Type of Channel	Exisitng Bed Level	Top of Lining	Existing Bank Level	Proposed Bank Level	Refernce Drawing No.
			Easting	Northing	Easting	Northing		L							
(-)	(ft)	(-)	(ft)	(ft)	(ft)	(ft)	(-)	(ft)	(-)	(-)	(ft)	(ft)	(ft)	(ft)	(-)
1	0+550	RW-01	2228045	11620084	2228104	11620003	SP&BR	100	L&R	Concrete Side Protection With Both side walls	589.23	594.33	594.32	596.33	4593/TD/061/RW-01-C
2	2+620	RW-02	2229483	11618555	2229513	11618529	SP&BR	40	LS	Concrete Side Protection With side walls	590.01	595.11	595.54	595.54	4593/TD/061/RW-01-A
3	3+450	RW-03	2229832	11618198	2230342	11617720	CL	700	L&R	Concrete Lining	590.16	595.26	594.15	597.26	4593/TD/061/RW-02
4	3+900	RW-04	2230342	11617720	2230498	11617595	SP&BR	200	LS	Concrete Side Protection With side walls	589.71	594.81	593.60	596.81	4593/TD/061/RW-01-A
5	5+350	RW-05	2231270	11616959	2231743	11616449	SP&BR	700	L&R	Concrete Side Protection With Both side walls	589.26	594.36	593.66	596.36	4593/TD/061/RW-01-C
6	9+100	RW-06	2232511	11613410	2232871	11612932	CL	400	L&R	Concrete Lining	588.11	593.21	593.21	595.21	4593/TD/061/RW-02
7	11+050	RW-07	2233846	11611928	2234884	11610846	CL	300	L&R	Concrete Lining	587.54	592.64	591.69	594.64	4-09-01 DIOUTINVV-02
8	14+500	RW-08	2236217	11609389	2236881	11608389	BR	200	L&R	Bank Restoration	587.01	592.11	591.99	594.11	

^{*}RDs are taken from the mid of the proposed rehabilitation works

NOTES:

ALL RDs/Coordinates should be confirmed by site engineer before construction.

DATE.

2. The Client did not provide the Consultants with the required L-sections of the canal, despite a request made in letter No. 4593/064/NKA/01/18 dated 23-8-23. As a result of the unavailability of the L-section, the Consultants were unable to retrieve the last design level data. However, the Consultants have deducted 1-2ft from the existing bed level to arrive at probable last design bed level, following instructions from the Client during a meeting held at NESPAK House on September 14, 2023.

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DAI		ļ
PAI	3	

						DRAWN	K.A
						SUBMITTED	M.M
						RECOMMENDED	Q.L
						CHD/VER	F.R.K
REV.	DATE	DESCRIPTION	BY	CKD.	APPR.	APPROVED	N.A

TABLE OF DETAILS FOR REHABILITATION OF DAMAGED / WASHED AWAY CANAL SECTION OF KETCH MINOR

SP = Side Protection

RR =Road Restoration

BR = Bank Restoration

LIST OF PROPOSED REHABILITATION WORKS OF PAHARPUR DISTRIBUTARY

				Coord	linates							Proposed Des	ign Data			
Sr. No.	RD*	ID	Start Co	ordinates	End Co	ordinates	Type of Rehab. Works	Length of Rehab.Wor k	Side	Type of Channel	Designed Bed Level	Exisitng Bed Level	Top of Lining	Existing Bank Level	Proposed Bank Level	Refernce Drawing No.
			Easting	Northing	Easting	Northing		L								
(-)	(ft)	(-)	(ft)	(ft)	(ft)	(ft)	(-)	(ft)	(-)	(-)	(ft)	(ft)	(ft)	(ft)	(ft)	(-)
1	12+950	RW-01	2249639	11660711	2249426	11660680	SP&BR	200	L&R	Concrete Side Protection With Both side walls	593.39	593.33	599.39	598.22	601.39	
2	13+700	RW-02	2248864	11660585	2248268	11660649	SP&BR	600	L&R	Concrete Side Protection With Both side walls	592.35	592.01	598.35	599.11	599.11	4593/TD/061/RW-01-C
3	25+950	RW-03	2239882	11656336	2239843	11656245	SP&BR	300	L&R	Concrete Side Protection With Both side walls	591.31	591.92	597.31	596.24	599.31	
4	28+000	RW-04	2239271	11654476	2239212	11654285	SP&BR	200	L	Concrete Side Protection With side walls	591.11	590.85	597.11	595.94	599.11	4593/TD/061/RW-01-A
5	28+975	RW-05	2238662	11653547	2238589	11653416	SP&BR	400	L&R	Concrete Side Protection With Both side walls	591.05	591.42	597.05	597.74	597.74	4502(TD)(004/D)AL 04 0
6	37+750	RW-06	2232627	11648155	2232447	11648068	SP&BR	200	L&R	Concrete Side Protection With Both side walls	590.01	589.34	596.01	597.34	597.34	4593/TD/061/RW-01-C
7	39+400	RW-08	2231777	11647631	2231605	11647528	RR	200	L	Road Rehabilation	589.88	589.34	595.88	598.31	598.31	
8	39+560	RW-09	2231379	11647397	2231283	11647282	SP&BR	200	L&R	Concrete Side Protection With Both side walls	589.80	588.43	595.80	596.33	596.33	4593/TD/061/RW-01-C
9	40+100	RW-10	2230729	11646585	2230649	11647392	RR	200	L	Road Rehabilation	589.75	589.34	595.75	597.34	597.34	
10	43+765	RW-12	2229556	11643366	2229509	11643141	RR	230	L	Road Rehabilation	589.62	588.96	595.62	597.32	597.32	
11	43+700	RW-13	2229483	11643141	2229439	11642946	SP&BR	200	L	Concrete Side Protection With side walls	589.50	590.37	595.50	597.23	597.23	4593/TD/061/RW-01-A

^{*}RDs are taken from the mid of the proposed rehabilitation works

NOTES:

ALL RDs/Coordinates should be confirmed by site engineer before construction.

EMERGENCY FLOOD ASSISTANCE PROJECT (EFAP)-KP
"RECONSTRUCTION AND REHABILITATION OF
IRRIGATION AND DRAINAGE SYSTEM AND FLOOD
PROTECTION WORKS IN KHYBER PAKHUNKHWA"



							DRAWN	K.A
R							SUBMITTED	M.M
							RECOMMENDED	Q.L
Τ							CHD/VER	F.R.K
	REV.	DATE	DESCRIPTION	BY	CKD.	APPR.	APPROVED	N.A



MODEL TOWN EXTENSION, LAHORE PAKISTAN

TABLE OF DETAILS
FOR REHABILITATION OF DAMAGED / WASHED AWAY
CANAL SECTION OF PAHARPUR DISTY

DATE. DRAWING NO.

SP = Side Protection

RR =Road Restorartion

BR = Bank Restoration

			LIST O	F PROP	OSED	REHAB	ILITATIO	ON WORK	S OF C	LD PAHARP	UR CAI	NAL RD	(118+50	0 - 122-	+300)	
				Coord	inates						Propo	sed Desigı	n Data			
Sr. No.	RD*	ID	Start Coo	ordinates	End Co	ordinates	Type of Rehab. Works	Length of Rehab.Wor k	Side	Type of Channel	Designe d Bed Level	Exisitng Bed Level	Top of Lining	Existing Bank Level	Proposed Bank Level	Refernce Drawing No.
			Easting	Northing	Easting	Northing		L								
(-)	(ft)	(-)	(ft)	(ft)	(ft)	(ft)	(-)	(ft)	(-)	(-)	(ft)	(ft)	(ft)	(ft)	(ft)	(-)
1	120+070	RW-01	2229333	11642712	2228819	11641228	SP&BR	660	L&R	Brick Retaining Wall	589.37	592.17	595.12	597.45	597.45	4593/TD/061/RW-03
2	119+075	RW-02	2229343	11642712	2229012	11641801	RR	450	L	Road Restoration	589.42	592.65	592.92	597.85	597.85	Asphalt Poad
3	120+320	RW-03	2228860	11641380	2228815	11641225	RR	160	L	Road Restoration	589.24	591.94	592.74	597.69	597.69	Asphalt Road

SP = Side Protection

RR =Road Restorartion

BR = Bank Restoration

NOTES:

ALL RDs/Coordinates should be confirmed by site engineer before construction.

EMERGENCY FLOOD ASSISTANCE PROJECT (EFAP)-KP
"RECONSTRUCTION AND REHABILITATION OF
IRRIGATION AND DRAINAGE SYSTEM AND FLOOD
PROTECTION WORKS IN KHYBER PAKHUNKHWA"



						DRAWN	K.A
						SUBMITTED	M.M
						RECOMMENDED	Q.L
						CHD/VER	F.R.K
REV.	DATE	DESCRIPTION	BY	CKD.	APPR.	APPROVED	N.A

TABLE OF DETAILS FOR REHABILITATION OF DAMAGED / WASHED AWAY CANAL SECTION OF OLD PAHARPUR CANAL RD (118+500-122+300)

	TAB	LE OF	DETAILS	S OF PRO	POSED	REHABI	LITATIC	ON WOF	RKS OF	OLD	PAHARPU	JR CANA	L RD	(130+00	0 - 160+00	0)
				Coord	inates						Pro	posed Desi	gn Data			
Sr. No.	RD*	ID	Start Co	ordinates	End Co	ordinates	Type of Rehab. Works	Length of Rehab. Work	Side	Туре	Designed Bed Level	Existing Bed Level	Top of Lining	Exisitng Bank Level	Proposed Bank Level	Refernce Drawing No.
			Easting	Northing	Easting	Northing		L								
(-)	(ft)	(-)	(ft)	(ft)	(ft)	(ft)	(-)	(ft)	(-)	(-)	(ft)	(ft)	(ft)	(ft)	(ft)	(-)
1	130+000	RW-01	2226147	11631804	2226120	11631761	RR	50	┙		586.47	588.33	589.47	596.61	596.61	
2	132+200	RW-02	2225087	11629941	2225068	11629894	RR	50	L		587.75	588.66	590.75	596.97	596.97	
3	136+590	RW-03	2225696	11625789	2225743	11625646	RR	150	L	ction	587.62	588.30	590.62	594.47	594.47	
4	138+650	RW-04	2226689	11623946	2226719	11623906	RR	50	L	Construction	587.16	588.81	590.16	595.40	595.40	4593/TD/061/RW-01
5	138+850	RW-05	2226794	11623805	2226851	11623722	RR	100	L	d Cor	587.14	590.60	590.14	595.27	595.27	(Detail A)
6	139+050	RW-06	2226896	11623628	2226935	11623536	RR	100	L	Road	587.08	590.90	590.08	595.20	595.20	
7	141+750	RW-07	2227050	11622445	2228271	11619705	RR	3100	L		588.54	589.27	591.54	595.02	595.02	
8	148+650	RW-08	2231957	11615938	2231987	11615843	RR	100	L		585.62	589.24	588.62	594.67	594.67	

SP = Side Protection

RR =Road Restorartion

BR = Bank Restoration

CL = Concrete Lining

NOTES:

ALL RDs/Coordinates should be confirmed by site engineer before construction.

EMERGENCY FLOOD ASSISTANCE PROJECT (EFAP)-KP
"RECONSTRUCTION AND REHABILITATION OF
IRRIGATION AND DRAINAGE SYSTEM AND FLOOD PROTECTION WORKS IN KHYBER PAKHUNKHWA"



							DRAWN	K.A
2							SUBMITTED	M.M
							RECOMMENDED	Q.L
•							CHD/VER	F.R.K
	REV.	DATE	DESCRIPTION	BY	CKD.	APPR.	APPROVED	N.A



TABLE OF DETAILS FOR REHABILITATION OF DAMAGED / WASHED AWAY CANAL SECTION OF OLD PAHARPUR CANAL RD (130+000-160+000)

DRAWING NO. DATE. HEAD OFFICE : NESPAK HOUSE, 1-C BLOCK N, MODEL TOWN EXTENSION, LAHORE PAKISTAN

4593/TD/061/TOD-25 SEP, 2023

			Т	ABLE	OF DET	AILS O	F PROF	POSED R	EHABII	LITATION W	VORKS (OF CIV	IL MIN	OR	
				Coord	linates					Р	roposed De	sign Data			
Sr. No.	RD*	ID	Start Co	ordinates	End Co	ordinates	Type of Rehab.	Length of Rehab.	Side	Туре	Existing	Top of Lining /	Existing Bank	Proposed	Reference Drawing No.
			Easting	Northing	Easting	Northing	Works	Work		71	Bed Level	Wall	Level	Bank Level	3
(-)	(ft)	(-)	(ft)	(ft)	(ft)	(ft)	(-)	(ft)	(-)	(-)	(ft)	(ft)	(ft)	(ft)	(-)
1	3+025	RW-01	2237239	11646677	2237127	11646782	CL	200	L&R	Concret Lining	583.82	588.07	587.32	590.07	4593/TD/061/RW-02
2	5+950	RW-02	2239238	11644763	2239330	11644643	RR	200	L	Concrete Side Protection	-	-	586.71	-	4593/TD/061/RW-01 (c)
3	6+425	RW-03	2239424	11644410	2239461	11644319	RR	200	L	Road	-	-	586.74	-	4593/TD/061/RW-01 (Detail
4	7+195	RW-04	2239746	11643576	2239768	11643523	RR	150	L	Construction	-	-	586.37	-	A)
5	8+520	RW-05	2240214	11642376	2240256	11642263	SP & RR	200	L&R	Concrete Side Protection	582.86	587.11	586.18	589.11	4593/TD/061/RW-01 (c)
6	10+240	RW-06	2240620	11641357	2241118	11640094	RR	1500	L	Road Construction	582.22	586.47	585.84	588.47	4593/TD/061/RW-01 (Detail A)
7	11+775	RW-07	2241423	11639476	2241572	11639180	SP & RR	400	L&R	Concrete Side Protection	581.25	585.50	586.60	587.50	
8	12+340	RW-08	2241726	11638968	2241851	11638838	SP & RR	200	L&R	Road Construction	581.53	585.78	586.16	587.78	4593/TD/061/RW-01 (c)
9	12+645	RW-09	2241949	11638734	2242103	11638563	RR	250	L	Road Construction	581.19	585.44	585.72	587.44	4593/TD/061/RW-01 (Detail A)
10	14+250	RW-10	2242849	11637385	2242939	11637245	SP & RR	160	L&R	Concrete Side Protection	581.22	585.47	585.49	587.47	4593/TD/061/RW-01 (c)
11	15+595	RW-11	2243612	11636192	2243640	11636150	RR	100	L		581.04	585.29	584.71	587.29	
12	17+750	RW-12	2244692	11634503	2244824	11634292	RR	300	L		581.06	585.31	584.28	587.31	
13	18+350	RW-13	2245060	11633915	2245151	11633772	RR	200	L	L Road Construction	_	-	584.92	-	4593/TD/061/RW-01 (Detail A)
14	19+565	RW-14	2245736	11632853	2245785	11632778	RR	100	L		-	-	583.89	-	, i
15	19+755	RW-15	2245846	11632681	2245888	11632619	RR	150	L		-	-	584.18	-	

SP = Side Protection

RR =Road Restorartion

BR = Bank Restoration

CL = Concrete Lining

NOTES:

- 1. ALL RDs/Coordinates should be confirmed by
- 2. The Client did not provide the Consultants with the required L-sections of the canal, despite a request made in letter No. 4593/064/NKA/01/18 dated 23-8-23. As a result of the unavailability of the L-section, the Consultants were unable to retrieve the last design level data. However, the Consultants have deducted 1-2ft from the existing bed level to arrive at probable last design bed level, following instructions from the Client during a meeting held at NESPAK House on September 14, 2023.

EMERGENCY FLOOD ASSISTANCE PROJECT (EFAP)-KP
"RECONSTRUCTION AND REHABILITATION OF
IRRIGATION AND DRAINAGE SYSTEM AND FLOOD
PROTECTION WORKS IN KHYBER PAKHUNKHWA"

11	GOVERNMENT OF KHYBER
St Eraff (tok-ang)	PAKHTUNKHWA
The state of the s	IRRIGATION DEPARTMENT

							DRAWN	K.A
HYBER							SUBMITTED	M.M
/A							RECOMMENDED	Q.L
TMENT							CHD/VER	F.R.K
	REV.	DATE	DESCRIPTION	BY	CKD.	APPR.	APPROVED	N.A



TABLE OF DETAILS FOR REHABILITATION OF DAMAGED / WASHED AWAY CANAL SECTION OF CIVIL MINOR

HEAD OFFICE : NESPAK HOUSE, 1-C BLOCK N, MODEL TOWN EXTENSION, LAHORE PAKISTAN DATE. DRAWING NO.

			TABL	E OF DI	ETAILS	OF PR	OPOSE	D REHA	BILITA	TION W	ORKS OF	RAKHI	DISTRI	BUTAR	Υ	
				Coord	inates						Propos	ed Design D	ata			
Sr. No.	RD*	ID	Start Cod	tart Coordinates		End Coordinates		Length of Rehab. Works	Side	Type of Channel	Designed Bed Level	Existing Bed Level	Top of Lining	Existing Bank	Propose d Bank	Reference Drawing
			Easting	Northing	Easting	Northing	Works	L						Level	Level	
(-)	(ft)	(-)	(ft)	(ft)	(ft)	(ft)	(-)	(ft)	(-)	(-)	(ft)	(ft)	(ft)	(ft)	(ft)	(-)
1	3+090	RW-01	2232191	11641667	2232210	11641648	CL & BR	30	L&R	Concrete	588.94	589.37	592.06	591.69	594.06	4593/TD/061/RW-02
2	4+025	RW-02	2232832	11640970	2232846	11640956	CL & BR	30	L&R	Lining	588.55	589.21	591.67	590.50	593.67	1000/12/00 1/1111 02
3	4+500	RW-03	2229493	11643005	2237196	11639168	Shingle	9000	R	Shingle Road	-	-	-	-	-	Shingle Road
4	5+055	RW-04	2233535	11640212	2233515	11640234	CL & BR	30	L&R		588.26	589.09	591.38	592.18	593.38	
5	5+875	RW-05	2234077	11639613	2234096	11639591	CL & BR	30	L&R		588.01	589.18	591.13	592.34	593.13	
6	5+945	RW-06	2234115	11639573	2234129	11639559	CL & BR	30	L&R	Concrete	587.98	589.50	591.10	591.79	593.10	4502/TD/061/DW/ 02
7	6+165	RW-07	2234311	11639461	2234338	11639451	CL & BR	30	L&R	Lining	587.92	588.66	591.04	592.30	593.04	
8	6+850	RW-08	2234958	11639454	2235060	11639440	CL & BR	100	L&R		585.55	586.96	589.13	589.82	591.13	
9	9+035	RW-09	2237152	11639171	2237196	11639168	CL & BR	50	L&R		584.89	585.00	588.47	588.59	590.47	

SP = Side Protection

RR =Road Restorartion

BR = Bank Restoration

CL = Concrete Lining

NOTES:

ALL RDs/Coordinates should be confirmed by site engineer before construction.

EMERGENCY FLOOD ASSISTANCE PROJECT (EFAP)-KP
"RECONSTRUCTION AND REHABILITATION OF
IRRIGATION AND DRAINAGE SYSTEM AND FLOOD
PROTECTION WORKS IN KHYBER PAKHUNKHWA"

Mr. S. All	GOVERNMENT OF KHYBER
St. Craft Line area	PAKHTUNKHWA IRRIGATION DEPARTMENT
	IRRIGATION DEPARTMENT

						DRAWN	K.A
						SUBMITTED	M.M
						RECOMMENDED	Q.L
						CHD/VER	F.R.K
REV.	DATE	DESCRIPTION	BY	CKD.	APPR.	APPROVED	N.A

TABLE OF DETAILS FOR REHABILITATION OF DAMAGED / WASHED AWAY CANAL SECTION OF RAKH DISTY

TABLE OF DETAILS OF PROPOSED REHABILITATION WORKS OF KATH GARH MINOR

			Proposed Dsign Data									
Sr. No.	RD*	ID	Type of Rehab. Works	Length of Rehab. Work	Side	Type of Channel	Existing Bed Level	Top of Lining / Wall	Existing Bank Level	Proposed Bank Level	Reference Drawing No.	
(-)	(ft)	(-)	(-)	(ft)	(-)	(-)	(ft)	(ft)	(ft)	(ft)	(-)	
1	5+885	RW-01	SP & BR	150	R		593.32	596.44	597.58	598.44		
2	6+500	RW-02	SP & BR	50	R	Concrete Side	593.25	596.37	597.81	598.37	4593/TD/061/RW-01 (C)	
3	8+450	RW-04	SP & BR	200	L&R	Protetion	593.27	596.39	596.38	598.39	4593/1 D/00 1/RVV-01 (C)	
4	10+500	RW-05	SP & BR	100	R		591.82	594.94	596.36	596.94		
5	16+150	RW-06	CL	100	L&R	Concrete	589.54	592.66	594.89	594.89	4593/TD/061/RW-02	
6	18+600	RW-07	CL	100	L&R	Lined	589.38	592.50	593.12	594.50	4593/10/001/KVV-02	

*RDs are taken from the mid of the proposed rehabilitation works

SP = Side Protection

RR =Road Restorartion

BR = Bank Restoration

CL = Concrete Lining

- ALL RDs/Coordinates should be confirmed by site engineer before construction.
- 2. The Client did not provide the Consultants with the required L-sections of the canal, despite a request made in letter No. 4593/064/NKA/01/18 dated 23-8-23. As a result of the unavailability of the L-section, the Consultants were unable to retrieve the last design level data. However, the Consultants have deducted 1-2ft from the existing bed level to arrive at probable last design bed level, following instructions from the Client during a meeting held at NESPAK House on September 14, 2023.

EMERGENCY FLOOD ASSISTANCE PROJECT (EFAP)-KP "RECONSTRUCTION AND REHABILITATION OF **IRRIGATION AND DRAINAGE SYSTEM AND FLOOD** PROTECTION WORKS IN KHYBER PAKHUNKHWA"

18 July 18 18 18 18 18 18 18 18 18 18 18 18 18	GOVERNMENT OF KHYBER
STATION AND A	PAKHTUNKHWA
	IRRIGATION DEPARTMENT

							DRAWN	K.A
R							SUBMITTED	M.M
							RECOMMENDED	Q.L
Τ							CHD/VER	F.R.K
	REV.	DATE	DESCRIPTION	BY	CKD.	APPR.	APPROVED	N.A



TABLE OF DETAILS FOR REHABILITATION OF DAMAGED / WASHED AWAY CANAL SECTION OF KAT GARH MINOR

DATE. HEAD OFFICE: NESPAK HOUSE, 1-C BLOCK N, MODEL TOWN EXTENSION, LAHORE PAKISTAN

DRAWING NO.

			TABLE	OF DE	TAILS C	F PROF	POSED	REHAB	ILITA	TIOI	N WORK	(S OF I	BIGWA	NI MIN	OR	
				Coord	inates						Pro	posed De	sign Data	3		
Sr. No.	RD*	ID	Start Cod	ordinates	End Coordinates		Type of Rehab.	Length of Rehab. Work	Side	Туре	Designed Bed	Existing Bed	Lining /	Existing Bank	Proposed Bank	Refernce Drawing No.
			Easting	Northing	Easting	Northing	Works	L			Level	Level	Wall	Level	Level	110.
(-)	(ft)	(-)	(ft)	(ft)	(ft)	(ft)	(-)	(ft)	(-)	(-)	(ft)	(ft)	(ft)	(ft)	(ft)	(-)
1	3+825	RW-01	2275087	11691683	2275055	11691644	RR	80	L	ction	597.20	597.54	602.96	603.50	604.96	
2	4+325	RW-02	2274646	11691358	2274602	11691334	RR	70	L	nstru	597.16	597.48	602.92	603.25	604.92	4593/TD/061/RW-01
3	5+025	RW-03	2273984	11691143	2273935	11691132	RR	50	L	ad Cor	597.00	597.25	602.76	602.95	604.76	(Detail A)
4	12+910	RW-04	2266321	11689375	2266423	11689439	RR	150	L	Roa	596.03	596.54	600.01	601.21	602.01	

SP = Side Protection

RR =Road Restorartion

BR = Bank Restoration

CL = Concrete Lining

NOTES:

ALL RDs/Coordinates should be confirmed by site engineer before construction.

EMERGENCY FLOOD ASSISTANCE PROJECT (EFAP)-KP
"RECONSTRUCTION AND REHABILITATION OF
IRRIGATION AND DRAINAGE SYSTEM AND FLOOD
PROTECTION WORKS IN KHYBER PAKHUNKHWA"



							DRAWN	K.A
2							SUBMITTED	M.M
							RECOMMENDED	Q.L
•							CHD/VER	F.R.K
	REV.	DATE	DESCRIPTION	BY	CKD.	APPR.	APPROVED	N.A

				TABL	E OF D	ETAILS	OF PROF	POSED RE	HABILIT	TATION WORKS	OF TAK	ARWAH	DISTRIE	BUTARY		
				Coord	inates						Propose	d Design Da	ta			
Sr. No.	RD*	ID		ordinates		ordinates	Type of Rehab. Works	Length of Rehab. Works	Side	Type of Channel	Designed Bed Level	Existing Bed Level	Top of Lining / Wall	Existing Bank Level	Proposed Bank Level	Reference Drawing No.
(-)	(ft)	(-)	Easting (ft)	Northing (ft)	Easting (ft)	Northing (ft)	(-)	(ft)	(-)	(-)	(ft)	(ft)	(ft)	(ft)	(ft)	(-)
1	8+450	RW-01	2303670	11696720	2303681	11696820	SP & BR	100		(-)	600.28	600.47	604.76	605.89	606.76	(-)
2	8+650	RW-02	2303654	11696621	2303635	11696525	SP & BR	100	L&R	Concrete Side	600.22	599.98	604.70	606.62	606.70	
3	8+850	RW-03	2303518	11696368	2303590	11696435	SP & BR	100	R	Protection	600.15	598.80	604.63	601.00	606.63	-
4	11+300	RW-04	2303516	11694832	2303390	11694645	SP & BR	200	L&R	Brick Retaining Wall	599.61	599.88	604.09	601.94	606.09	4593/TD/061/RW-03
5	11+840	RW-05	2301705	11694364	2301693	11694065	SP & BR	300	R	Brick Retaining Wall	599.55	599.36	604.03	603.80	606.03	4093/10/00/1/100-03
6	13+730	RW-06	2301892	11692492	2301844	11692297	SP & RR	200	L&R		599.13	599.68	603.61	603.70	605.61	
7	14+515	RW-07	2301740	11691688	2301790	11691604	SP & BR	100	L&R		598.84	599.13	603.32	604.81	605.32	
8	15+125	RW-08	2301931	11691339	2301921	11690837	SP & BR	520	L&R	Concrete Side Protection	598.51	598.89	602.88	599.70	604.88	4593/TD/061/RW-01 (c)
9	21+683	RW-09	2298284	11686918	2298126	11686705	SP & BR	265	R		597.96	596.36	602.33	597.73	604.33	
10	23+200	RW-10	2297325	11685718	2297176	11685556	SP & BR	220	R		596.77	594.92	601.14	597.00	603.14	
11	23+800	RW-11	2296853	11685217	2296818	11685181	SP & BR	50	R		596.43	-	600.80	-	-	
12	25+955	RW-12	2295646	11683540	2295487	11683469	SP & BR	180	L&R		596.00	598.05	600.37	596.40	602.37	
13	29+375	RW-13	2293189	11681582	2293113	11681344	SP & BR	250	L&R		596.25	593.53	600.62	595.00	602.62	1
14	31+040	RW-14	2293554	11679940	2293567	11679861	SP & BR	80	R		594.88	595.56	599.25	599.80	601.25	
15	31+425	RW-15	2293535	11679451	2293573	11679600	SP & BR	150	R	Brick Retaining Wall	594.66	594.59	599.03	598.30	601.03	4593/TD/061/RW-03
16	36+955	RW-16	2291759	11674754	2291729	11674702	SP & BR	60	L&R		593.40	593.13	597.74	592.80	599.74	
17	37+060	RW-17	2291710	11674667	2291669	11674598	SP & BR	80	L&R		594.84	594.20	599.18	597.17	601.18	
18	37+510	RW-18	2291475	11674268	2291449	11674225	SP & BR	50	R	Concrete Side Protection	592.85	593.37	597.19	592.53	599.19	4593/TD/061/RW-01 (c)
19	37+950	RW-19	2291314	11674005	2291154	11673750	SP & BR	300	L&R	1 101001011	592.42	593.30	596.76	593.70	598.76	
20	44+080	RW-20	2287952	11668864	2287916	11668632	SP & BR	240	L&R		591.58	591.43	595.92	593.23	597.92	
21	46+810	RW-21	2287707	11666175	2287551	11665981	SP & BR	250	R	Brick Retaining Wall	589.98	590.75	594.32	593.75	596.32	4593/TD/061/RW-03
22	47+520	RW-22	2287193	11665540	2287130	11665466	SP & BR	280	L		589.98	590.21	593.98	588.71	595.98	
23	48+875	RW-23	2286406	11664569	2286251	11664373	SP & RR	250	R	Concrete Side Protection	589.61	590.13	593.61	589.77	595.61	
24	59+905	RW-24	2279598	11656408	2279631	11656313	SP & RR	100	L&R		588.04	587.34	592.04	593.62	594.04	
25	60+640	RW-25	2279535	11655883	2279443	11655683	SP & BR	220	L&R	Brick Retaining Wall	588.27	586.47	592.27	593.16	594.27	4593/TD/061/RW-03

SP = Side Protection

RR =Road Restorartion

BR = Bank Restoration

CL = Concrete Lining

NOTES:

ALL RDs/Coordinates should be confirmed by site engineer before construction.

EMERGENCY FLOOD ASSISTANCE PROJECT (EFAP)-KP
"RECONSTRUCTION AND REHABILITATION OF
IRRIGATION AND DRAINAGE SYSTEM AND FLOOD PROTECTION WORKS IN KHYBER PAKHUNKHWA"



							DRAWN	K.A
₹							SUBMITTED	M.M
							RECOMMENDED	Q.L
Γ							CHD/VER	F.R.K
	REV.	DATE	DESCRIPTION	BY	CKD.	APPR.	APPROVED	N.A



HEAD OFFICE: NESPAK HOUSE, 1-C BLOCK N, MODEL TOWN EXTENSION, LAHORE PAKISTAN

TABLE OF DETAILS FOR REHABILITATION OF DAMAGED / WASHED AWAY CANAL SECTION OF TAKARWAH DISTY

TYPICAL DRAWINGS FOR PROPERTY OF DRAWINGS FOR PROPERTY OF THE POSED DRAINS

REHABILITATION OF DRAINS IN PAHARPUR IRRIGATION DIVISION, DERA ISMAIL KHAN								
	LIST OF TYPICAL DRAWINGS FOR PROPOSED REHABILITATION WORKS OF DRAINS							
SR. NO.	SR. NO. DRAWING TITLE DRAW							
1	GENERAL NOTES (SHEET 1 OF 2)	4593-TD-061-GN-01						
2	GENERAL NOTES (SHEET 2 OF 2)	4593-TD-061-GN-01						
3	DRAIN SECTION DESILTING AND CLEANING (CASE-1)	4593-TD-061-DR-RW-01						
4	DRAIN BANK RESTORATION (CASE-2)	4593-TD-061-DR-RW-02						
5	TYPICAL BRICK RETAINING WALL (CASE-3A)	4593-TD-061-DR-RW-03 A						
6	TYPICAL PLUM CONCRETE RETAINING WALL (CASE-3B)	4593-TD-061-DR-RW-03 B						
7	TYPICAL STONE PROTECTION COMPLETE (CASE-4A)	4593-TD-061-DR-RW-04A						
8	TYPICAL STONE PROTECTION PARTIAL (CASE-4B)	4593-TD-061-DR-RW-0BA						
	LIST OF TYPICAL DRAWINGS FOR PROPOSED HYDRAULIC STRUCTUI	RES OF DRAINS						
9	DRAINAGE CULVERT LARGI-1 AT RD 0+000 (PLAN)	4593/TD/061/DR/DC-01						
10	DRAINAGE CULVERT LARGI-1 AT RD 0+000 (SECTION AND DETAILS)	4593/TD/061/DR/DC-02						
11	DRAINAGE CULVERT LARGI-1 AT RD 0+000 (TABLE OF DIMENSIONS)	4593/TD/061/DR/DC-03						
12	DRAINAGE CULVERT MAIN DRAIN AT RD 28+300 (PLAN)	4593/TD/061/DR/DC-01						
13	DRAINAGE CULVERT LARGI-1 AT RD 0+000 (SECTION AND DETAILS)	4593/TD/061/DR/DC-02						
14	DRAINAGE CULVERT LARGI-1 AT RD 0+000 (TABLE OF DIMENSIONS)	4593/TD/061/DR/DC-03						

EMERGENCY FLOOD ASSISTANCE PROJECT (EFAP)-KP
"RECONSTRUCTION AND REHABILITATION OF
IRRIGATION AND DRAINAGE SYSTEM AND FLOOD
PROTECTION WORKS IN KHYBER PAKHUNKHWA"





							DRAWN	F.A
R							SUBMITTED	M.M
-							RECOMMENDED	Q.L
•							CHD/VER	F.R.K
	REV.	DATE	DESCRIPTION	BY	CKD.	APPR.	APPROVED	N.A



HEAD OFFICE : NESPAK HOUSE, 1-C BLOCK N, MODEL TOWN EXTENSION, LAHORE PAKISTAN LIST OF DRAWINGS

•	DATE	DWG. NO.
	AUG 2023	

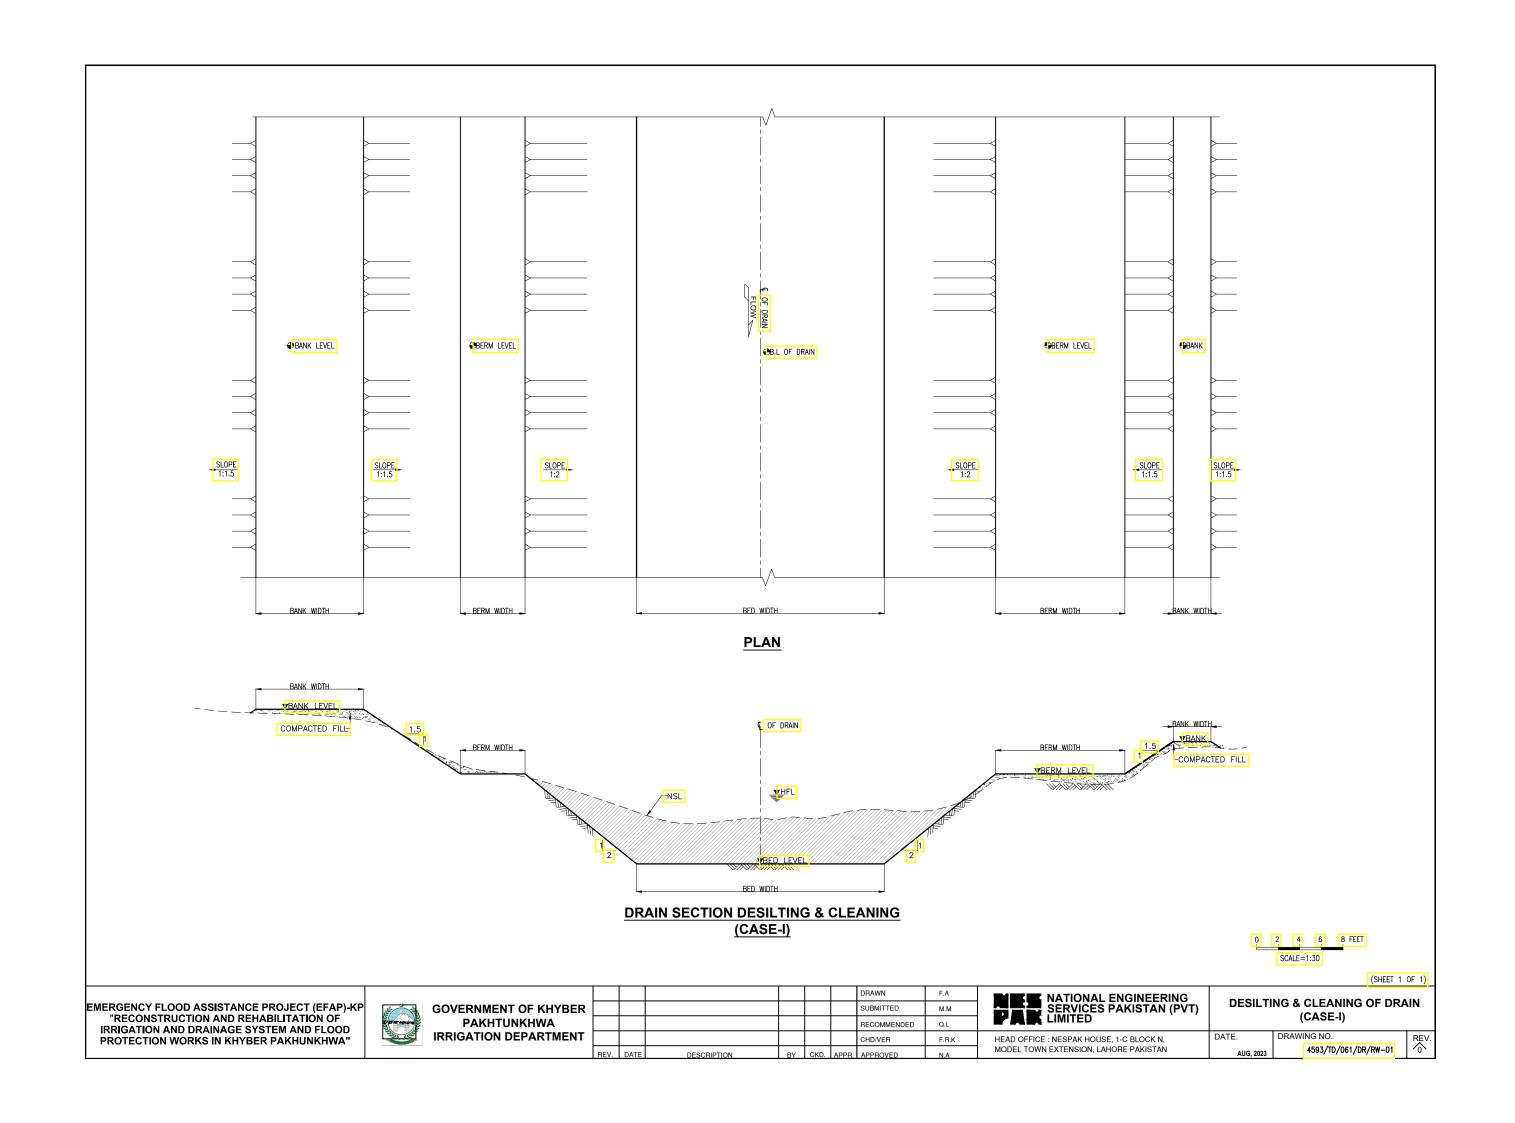

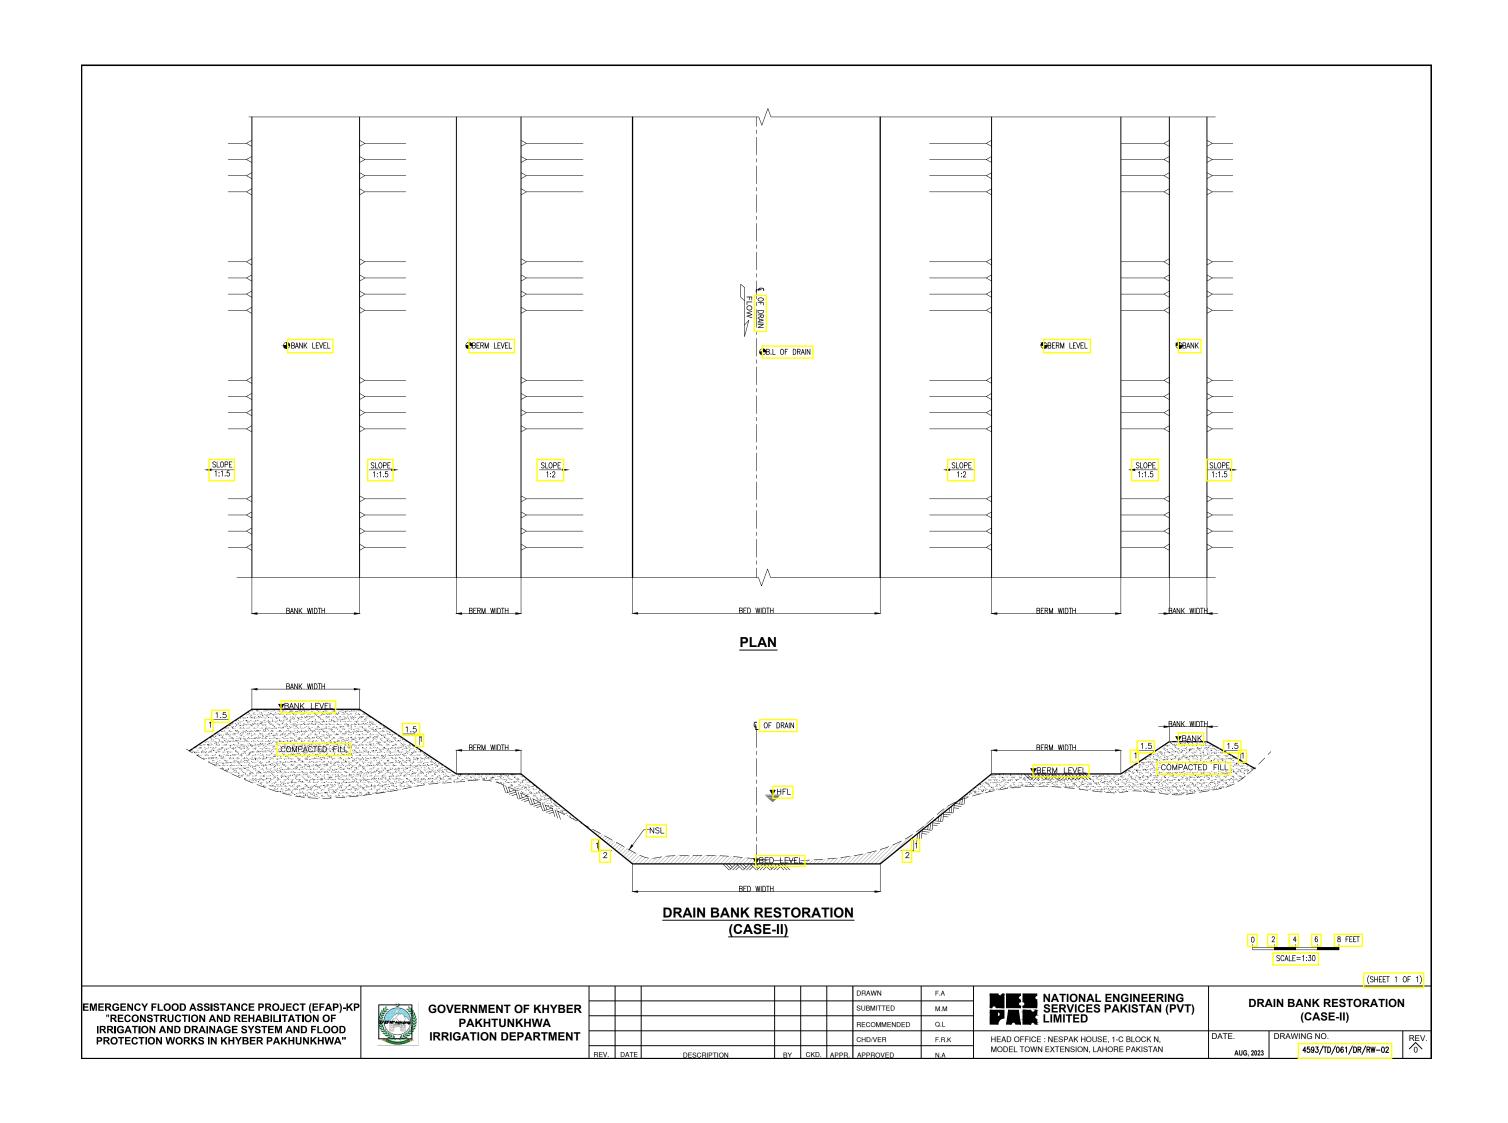


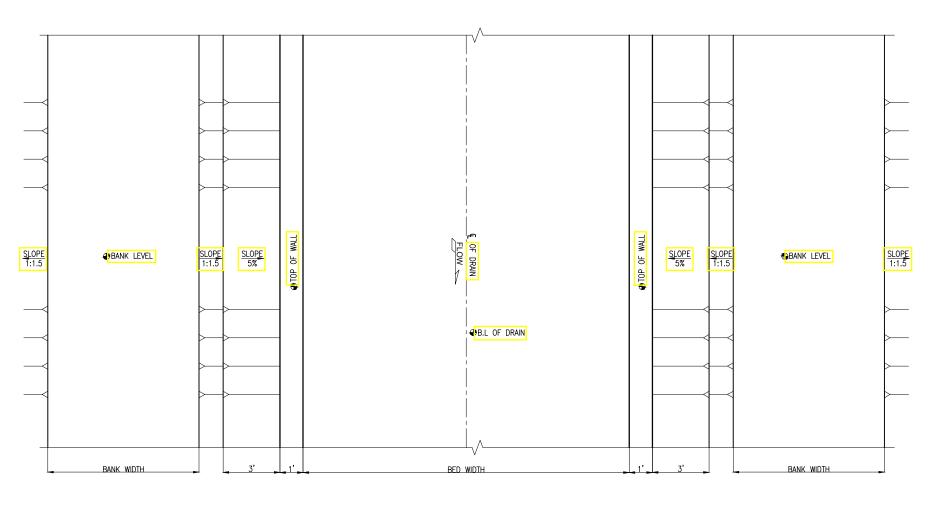


	TABLE OF DIMENSION							
Sr.No.	Drain Name	RD.	Side	Length	Height (H)			
(-)	(-)	(ft)	(-)	(ft)	(ft-Inch)			
1	Jabbarwala	5+000	L&R Banks	100	7'-3"			
2	Jabbarwala	11+650	Right Bank	300	6'-6"			
3	Largi-1	2+750	Left Bank	300	7'-9"			
4	Largi-1	4+150	Right Bank	350	7'-9"			

REFERENCE DRAWINGS:

1. APPROVED L- SECTION OF CHANNEL CONCERNED

...4593/TD/061/GN-01

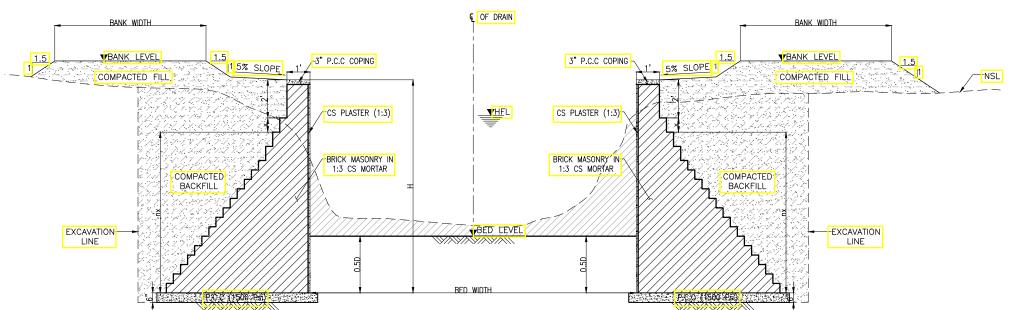

TYPICAL DRAIN BRICK RETAINING WALL


(CASE-III)

NOTES:

- PROVIDE WELL COMPACTED BACKFILL MATERIAL IN EXCAVATED PORTION AROUND STRUCTURE. THE COMPACTION SHALL NOT BE LESS THAN 95% OF MAXIMUM DRY DENSITY AS DETERMINED BY MODIFIED AASHTO.
- ALL BRICK TO BE USED IN MASONRY WORK SHALL BE OF STANDARD SIZE AND SHALL CONFORM TO THE SPECIFICATIONS.
- ALL BRICK MASONRY SHALL BE LAID WITH C/S MORTAR (RATIO 1:3)
- 4. ALL EXPOSED SURFACE OF BRICK MASONRY SHALL BE PROVIDED WITH C/S POINTING (RATIO 1:3).
- 'D' DENOTÉS DESIGNED WATER DEPTH AND W IS DESIGNED UNLINED WIDTH AS PER L.SECTION.
- MINIMUM DEPTH OF FOOTING IS EQUAL TO 0.5D, MINOR ADDITIONAL DEPTH MAY BE NEEDED TO ACCOMMODATE A WHOLE NUMBER OF BRICK COURSES.
- x= 0.75', BOTTOM STEP TO BE ADJUSTED FOR A WHOLE NUMBER OF BRICK COURSES.
- EXISTING DIMENSIONS/LEVELS NEED TO BE VERIFIED BY THE ENGINEER.
- 9. SIDE OF BANK AND ROAD (L/R) MAY BE CHANGED AS PER SITE CONDITIONS. 10. BANK WIDTH TO BE ADOPTED AS PER RESPECTIVE

AUG, 2023

DRAIN L-SECTIONS.

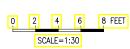

(SHEET 1 OF 2)

EMERGENCY FLOOD ASSISTANCE PROJECT (EFAP)-KP "RECONSTRUCTION AND REHABILITATION OF **IRRIGATION AND DRAINAGE SYSTEM AND FLOOD** PROTECTION WORKS IN KHYBER PAKHUNKHWA"



GOVERNMENT OF KHYBER PAKHTUNKHWA IRRIGATION DEPARTMENT

						DHAWN	F.A	l
						SUBMITTED	M.M	
						RECOMMENDED	Q.L	
						CHD/VER	F.R.K	
REV.	DATE	DESCRIPTION	BY	CKD.	APPR.	APPROVED	N.A	


NATIONAL ENGINEERING SERVICES PAKISTAN (PVT) LIMITED

YPICAL DRAIN BRICK RETAINING WALL (CASE-III)

HEAD OFFICE: NESPAK HOUSE, 1-C BLOCK N, MODEL TOWN EXTENSION, LAHORE PAKISTAN

REV

4593/TD/061/DR/RW-03

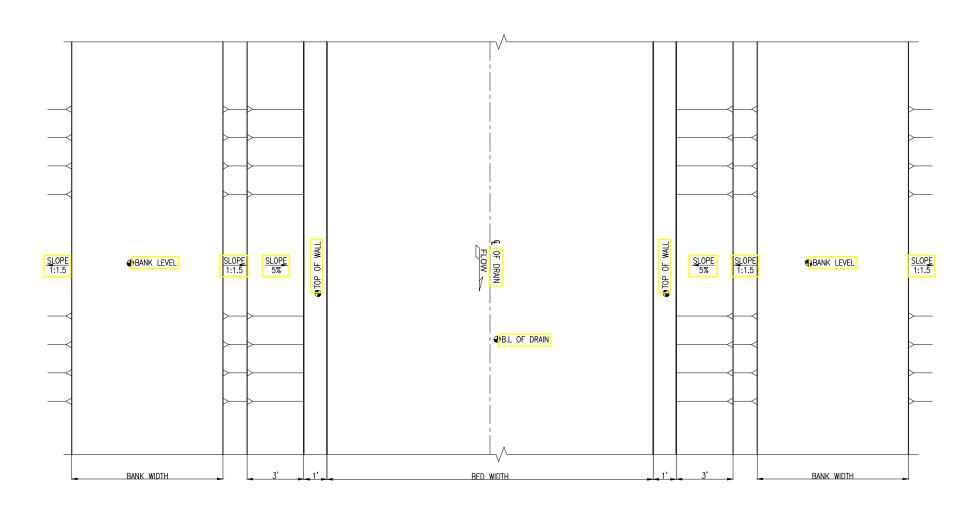


RETAINING WALL								
	TABLE OF DIMENSION							
Sr.No. Drain Name RD. Side Length Height (
(-)	(-) (ft)		(-)	(ft)	(ft-Inch)			
1	Bilot Creek	14+000	Left Bank	150	7'-0"			
2	Largi-1	5+800	Left Bank	100	7'-0"			
	Largi-1	0.000	Leit Dalik	100	1 -0			

REFERENCE DRAWINGS:

1. APPROVED L- SECTION OF CHANNEL CONCERNED

...4593/TD/061/GN-01

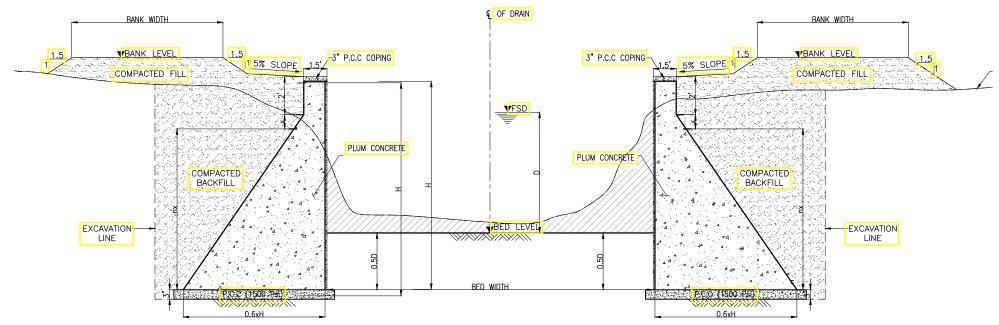

NOTES:

- PROVIDE WELL COMPACTED BACKFILL MATERIAL IN EXCAVATED PORTION AROUND STRUCTURE. THE COMPACTION SHALL NOT BE LESS THAN 95% OF MAXIMUM DRY DENSITY AS DETERMINED BY MODIFIED AASHTO.
- ALL BRICK TO BE USED IN MASONRY WORK SHALL BE OF STANDARD SIZE AND SHALL CONFORM TO THE SPECIFICATIONS.
- ALL BRICK MASONRY SHALL BE LAID WITH C/S MORTAR (RATIO 1:3)
- 4. ALL EXPOSED SURFACE OF BRICK MASONRY SHALL BE PROVIDED WITH C/S POINTING (RATIO 1:3).
- 'D' DENOTÉS DESIGNED WATER DEPTH AND W IS DESIGNED UNLINED WIDTH AS PER L.SECTION.
- MINIMUM DEPTH OF FOOTING IS EQUAL TO 0.5D, MINOR ADDITIONAL DEPTH MAY BE NEEDED TO ACCOMMODATE A WHOLE NUMBER OF BRICK COURSES.
- x= 0.75', BOTTOM STEP TO BE ADJUSTED FOR A WHOLE NUMBER OF BRICK COURSES. EXISTING DIMENSIONS/LEVELS NEED TO BE VERIFIED BY THE ENGINEER.
- 9. SIDE OF BANK AND ROAD (L/R) MAY BE CHANGED AS PER SITE CONDITIONS. 10. BANK WIDTH TO BE ADOPTED AS PER RESPECTIVE DRAIN L-SECTIONS.





(SHEET 3 OF 3)

REV

EMERGENCY FLOOD ASSISTANCE PROJECT (EFAP)-KP "RECONSTRUCTION AND REHABILITATION OF **IRRIGATION AND DRAINAGE SYSTEM AND FLOOD** PROTECTION WORKS IN KHYBER PAKHUNKHWA"



GOVERNMENT OF KHYBER PAKHTUNKHWA IRRIGATION DEPARTMENT

						DHAWN	r.A	ĺ
						SUBMITTED	M.M	
						RECOMMENDED	Q.L	
						CHD/VER	F.R.K	
REV.	DATE	DESCRIPTION	BY	CKD.	APPR.	APPROVED	N.A	

DDAWN

NATIONAL ENGINEERING SERVICES PAKISTAN (PVT) LIMITED


HEAD OFFICE: NESPAK HOUSE, 1-C BLOCK N,


MODEL TOWN EXTENSION, LAHORE PAKISTAN


TYPICAL DRAIN PLUM CONCRETE **RETAINING WALL** (CASE-III B)

AUG, 2023

4593/TD/061/DR/RW-03

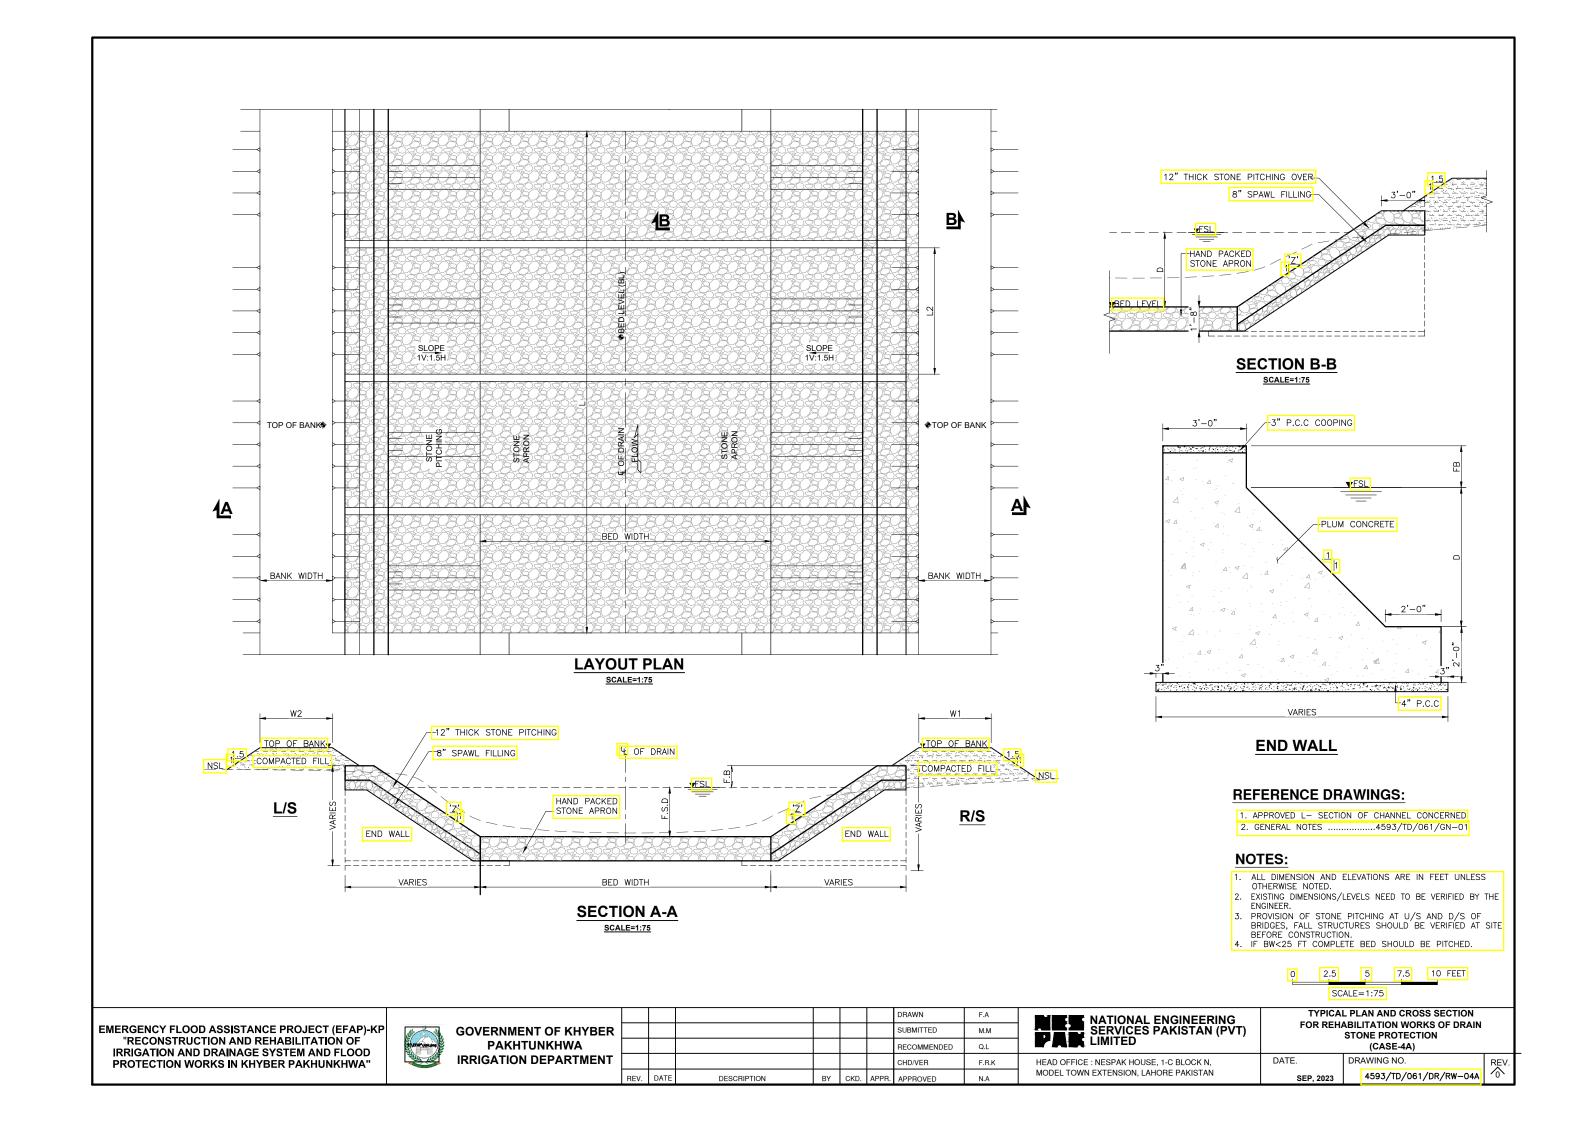

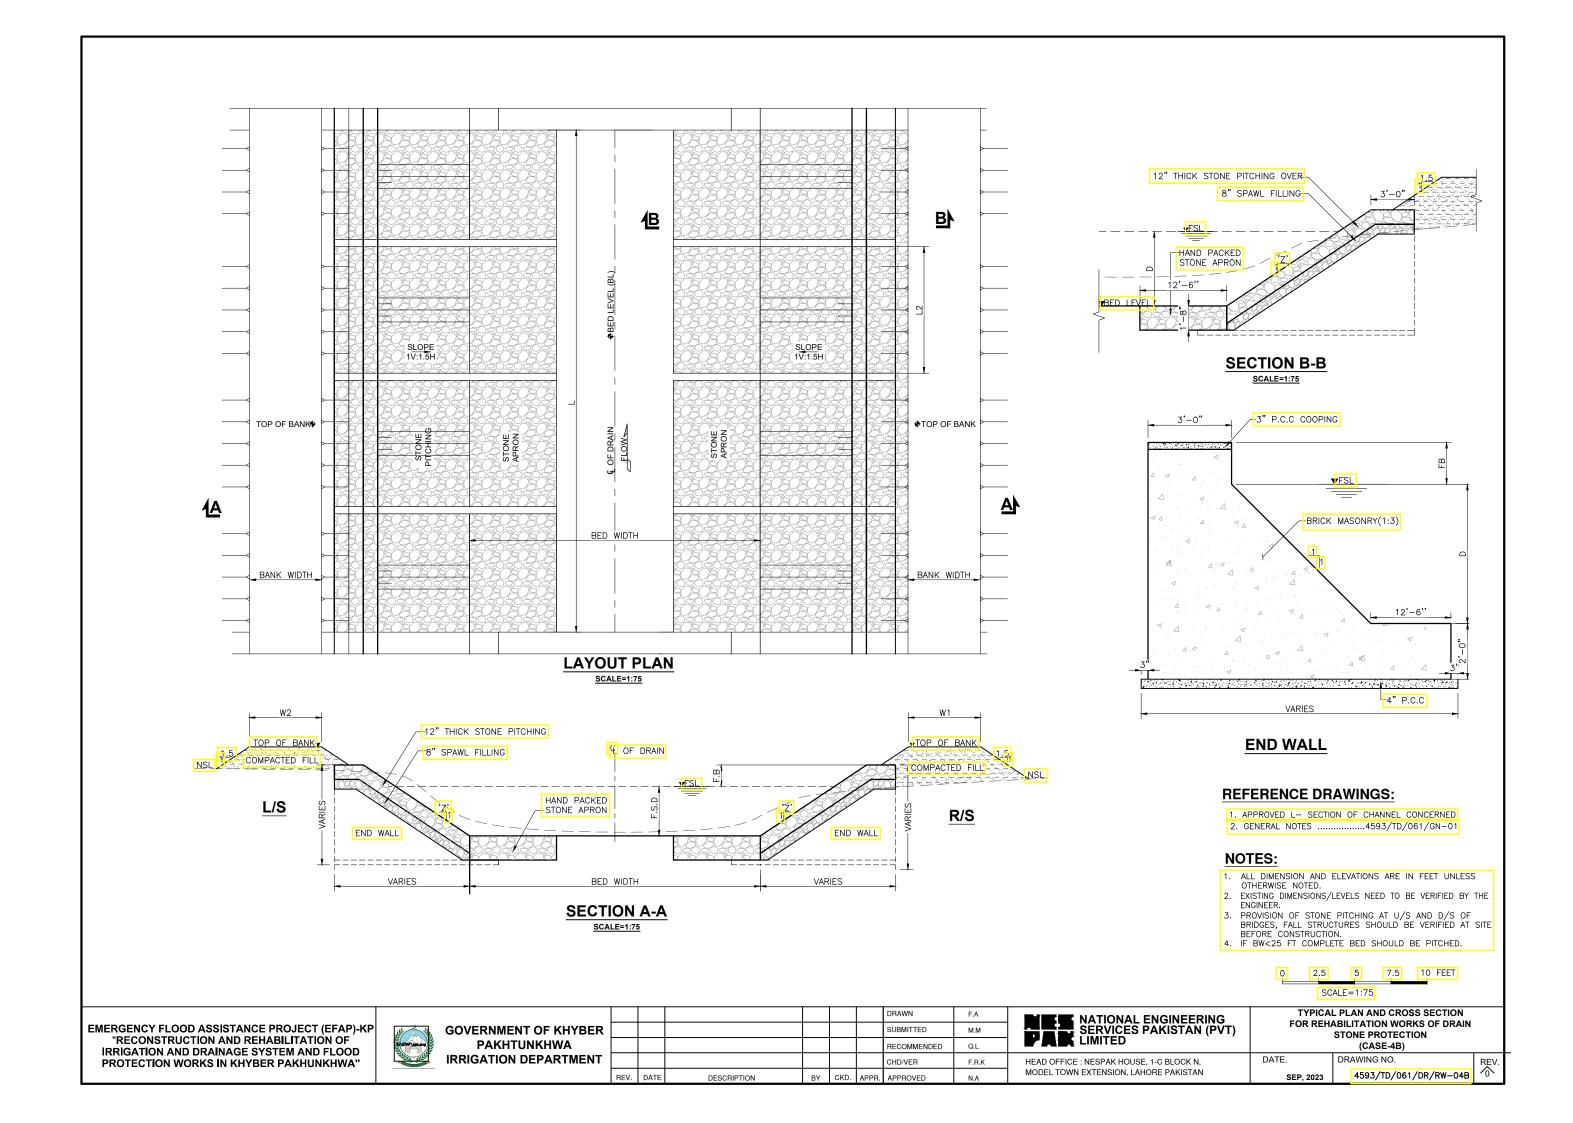

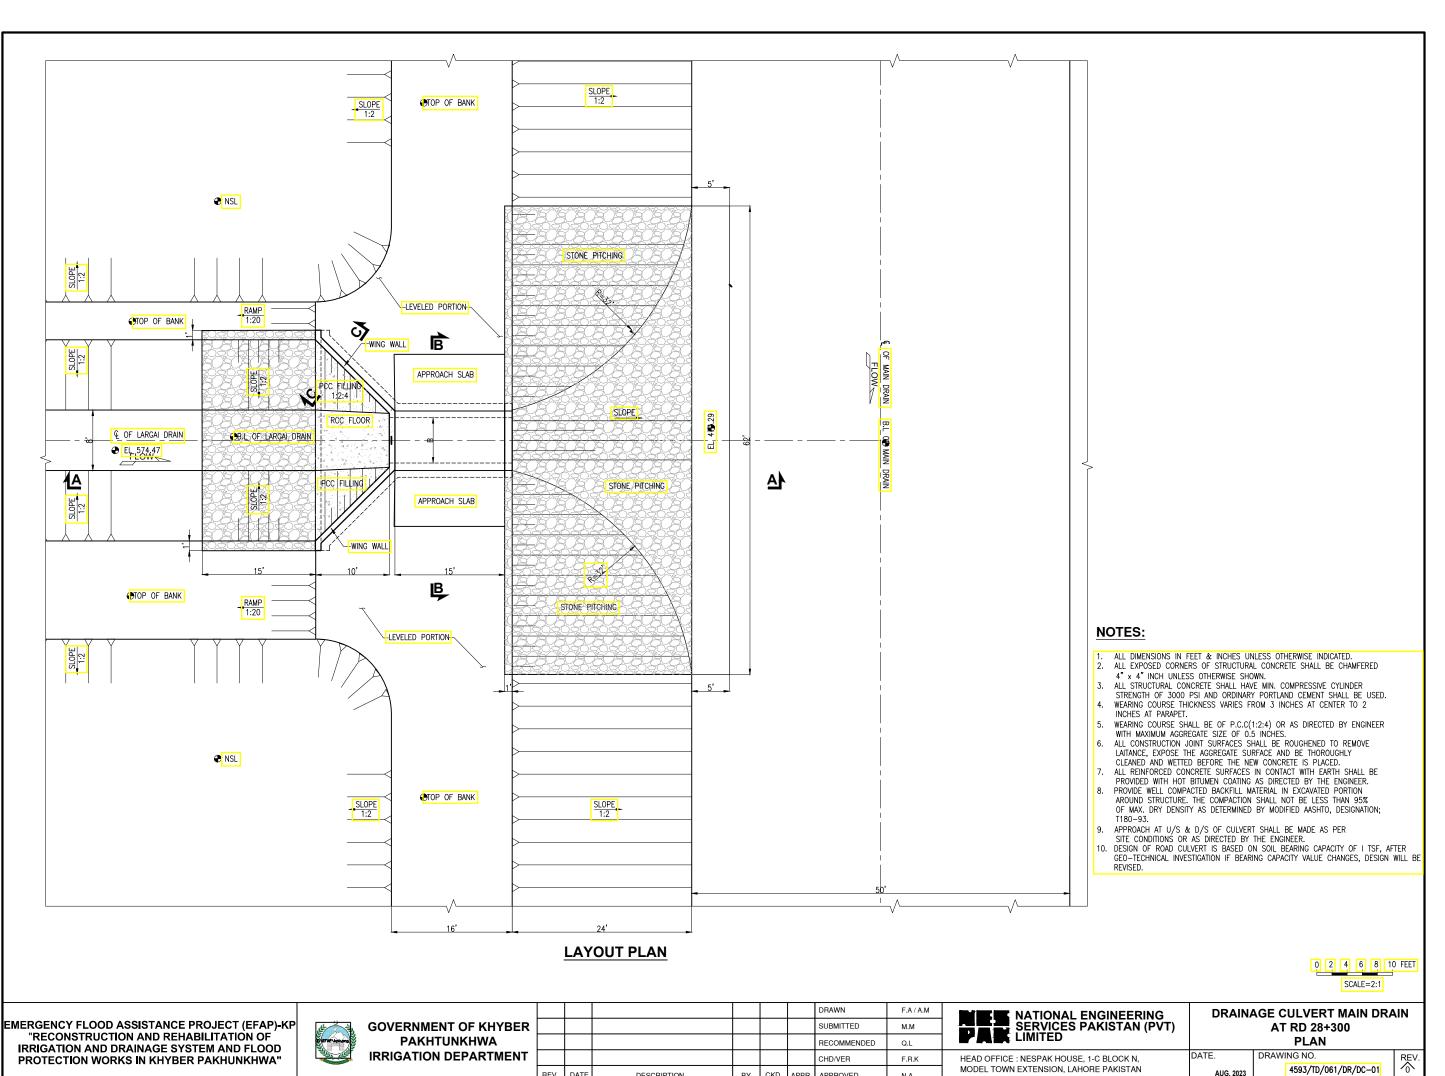

PROTECTION WORKS IN KHYBER PAKHUNKHWA"

IRRIGATION DEPARTMENT

CHD/VER F.R.K

HEAD OFFICE: NESPAK HOUSE, 1-C BLOCK N, MODEL TOWN EXTENSION, LAHORE PAKISTAN

4593/TD/061/DR/DC-01

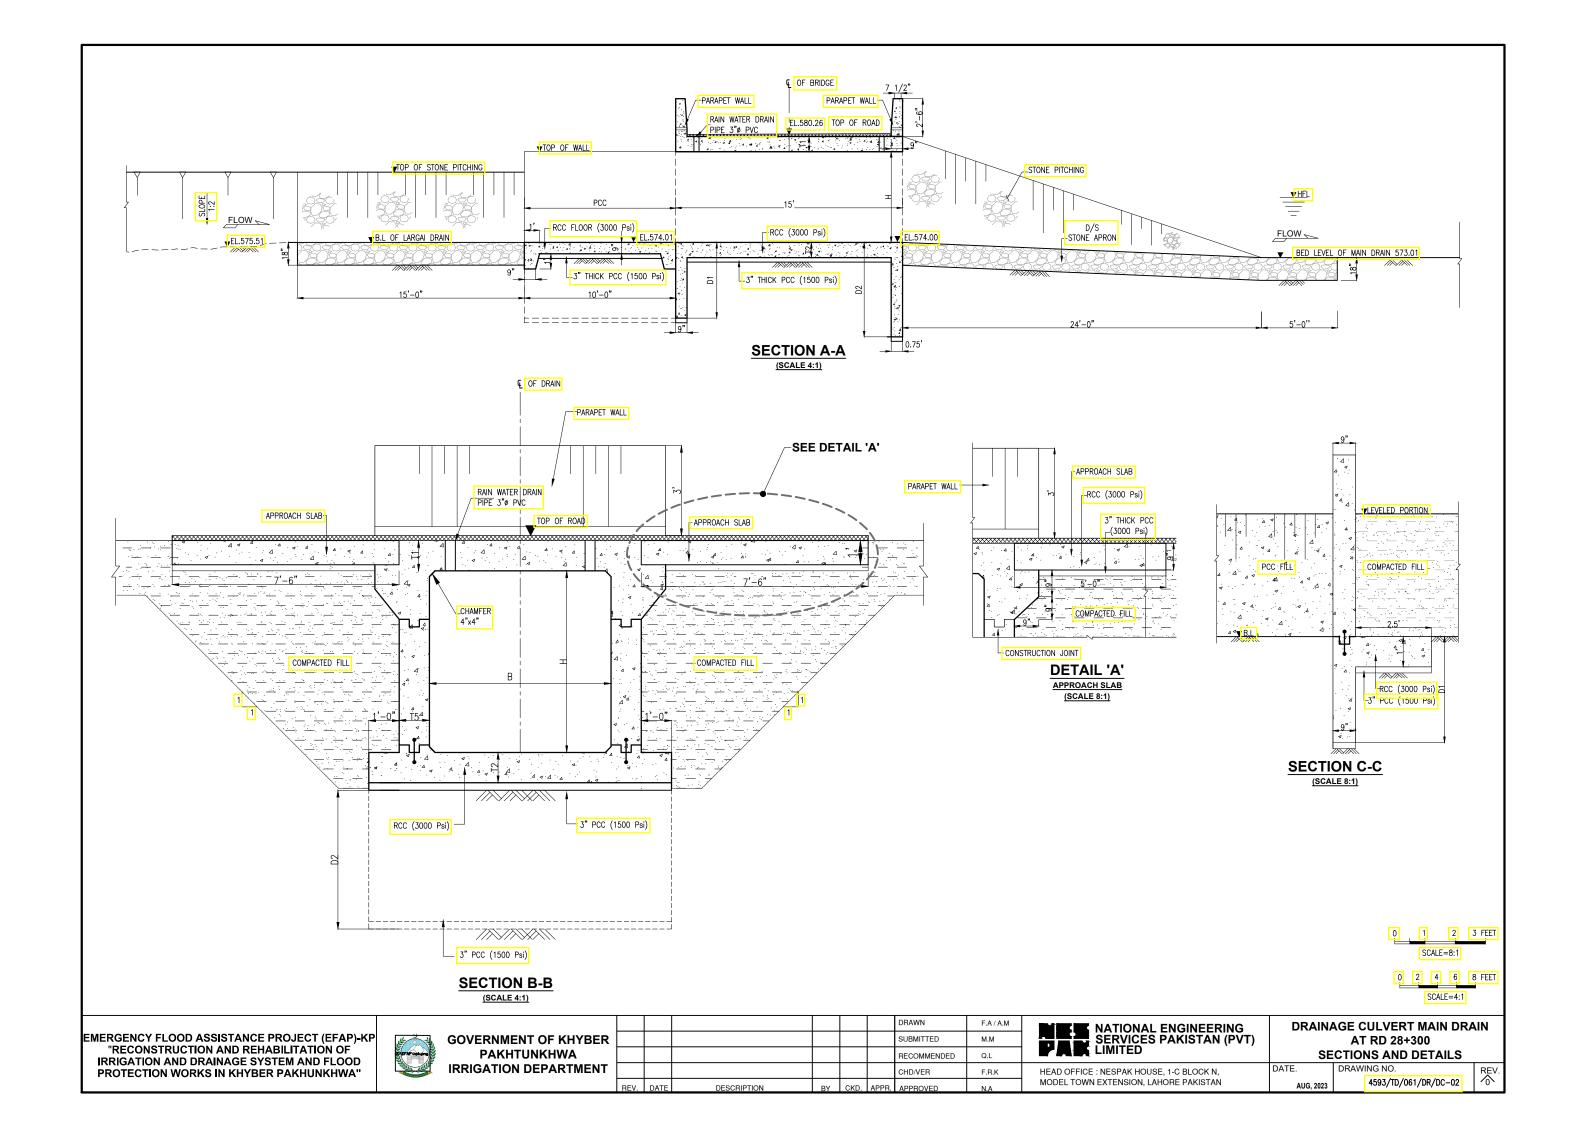


	TABLE OF DIMENSIONS AND ELEVATIONS OF DRAINAGE CULVERT																				
			, Dispose		Exist	ing Hydrauli	: Data		Proposed Culvert Structural Data												
Sr No	. Drain Name	Nullah PII	off in Main	Design Discharge	Bed Width	Existing Bed Level	Flow Depth	Free Board	Design U/S Floor Level	Top Level of Road	No. of Barrel	Width of Barrel (B)	No. of Peir	Barrel Height (H)	SCOUR	D/S Scour Depth (D2)	T1	Т2	Т3	Т4	Т5
(-)	(-)	(ft)	(ft)	(ft ³ /sec)	(ft)	(ft)	(ft)	(ft)	(ft)	(ft)	(-)	(ft)	(ft)	(ft)	(ft)	(ft)	(ft)	(ft)	(ft)	(ft)	(ft)
1	Village Drain (Seed Farms)	0+000	28+300	45.00	6.00	574.41	3.00	2.00	574.01	580.26	1	6.00	-	5.00	2.50	6.00	1.00	1.00	0.75	0.75	-

DIMENSIONS

T1 SLAB THICKNESS T2 FLOOR THICKNESS


Т3 PARAPET WALL THICKNESS

T4 WALL THICKNESS T5 PIER THICKNESS

GOVERNMENT OF KHYBER PAKHTUNKHWA IRRIGATION DEPARTMENT
PAKHTUNKHWA

							DRAWN	F.A / A.M	ĺ
R							SUBMITTED	M.M	l
							RECOMMENDED	Q.L	
T							CHD/VER	F.R.K	ſ
	REV.	DATE	DESCRIPTION	BY	CKD.	APPR.	APPROVED	N.A	



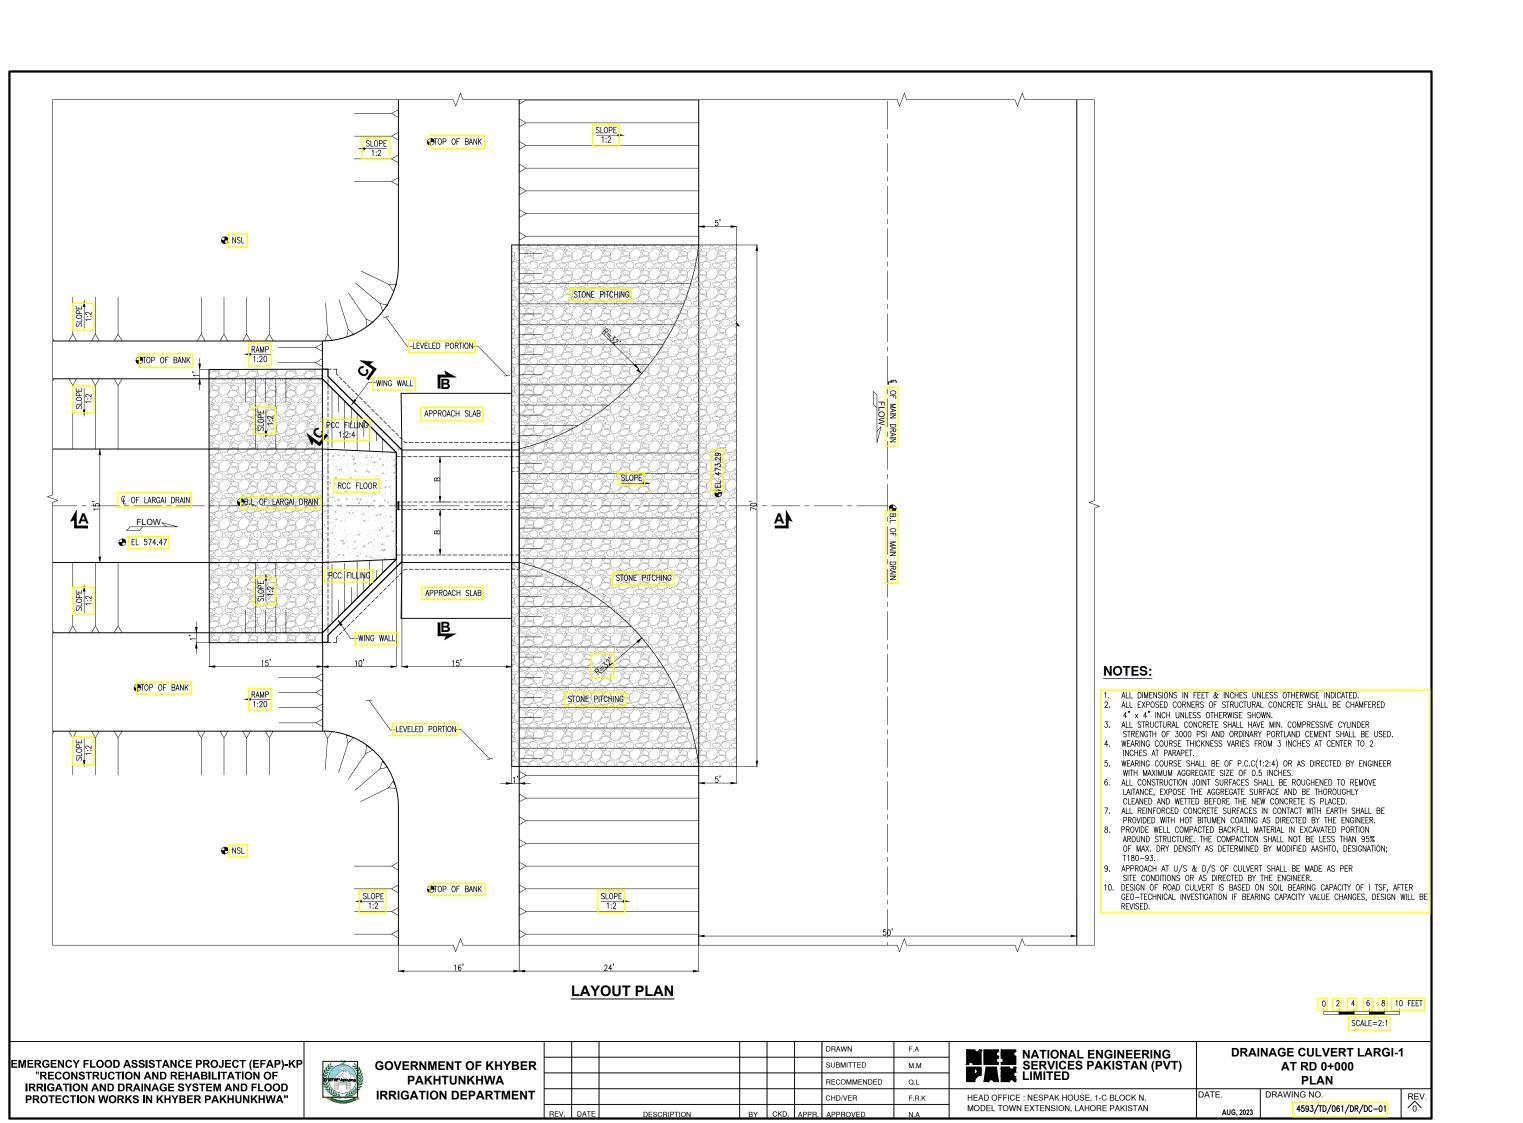

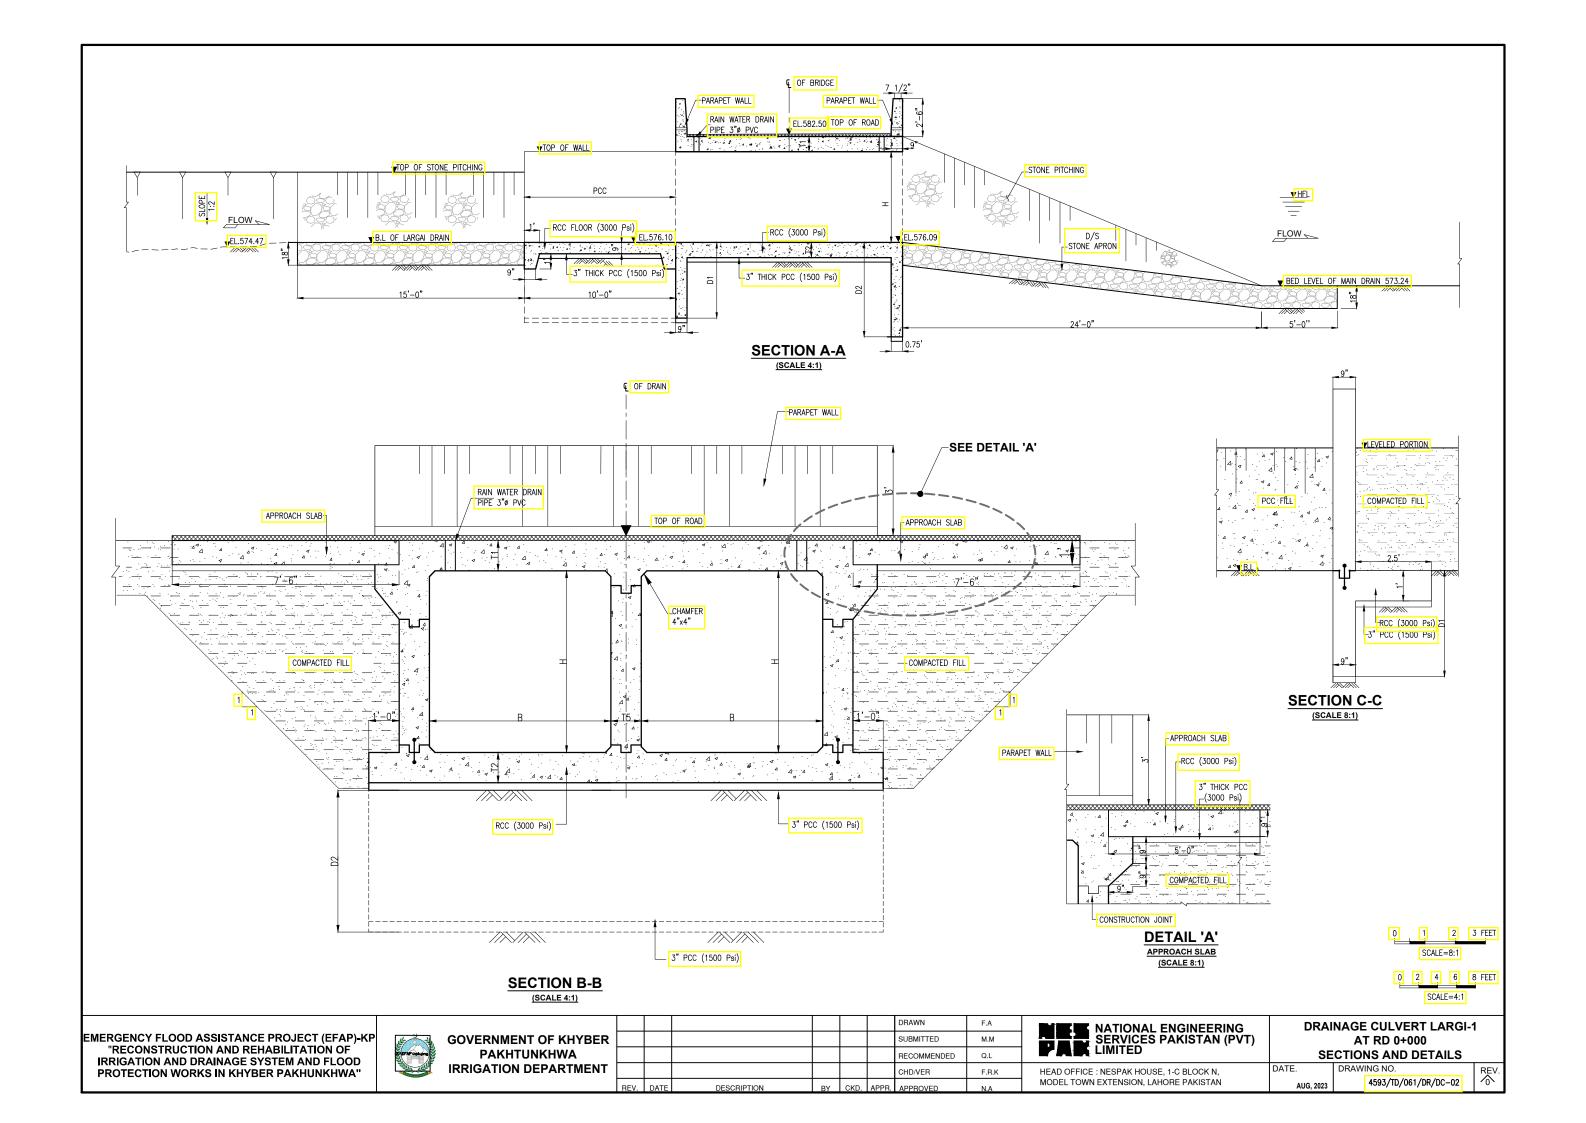


	TABLE OF DIMENSIONS AND ELEVATIONS OF DRAINAGE CULVERT																				
			ь.		Exis	ting Hydraulid	: Data						Propos	ed Culve	rt Struct	ural Data					
Sr	No. Drain Name	Drain / Nullah RD.	Dispose off in Main Drain RD.	Design Discharge	Bed Width	Existing Bed Level	Flow Depth	Free Board	Design U/S Floor Level	Top Level of Road	No. of Barrel	Width of Barrel (B)	No. of Peir	Barrel Height (H)	Scour	D/S Scour Depth (D2)	Т1	Т2	Т3	T4	Т5
	(-) (-)	(ft)	(ft)	(ft³/sec)	(ft)	(ft)	(ft)	(ft)	(ft)	(ft)	(-)	(ft)	(ft)	(ft)	(ft)	(ft)	(ft)	(ft)	(ft)	(ft)	(ft)
	1 Largi-I	0+000	38+000	95.00	14.00	575.85	3.15	2.00	576.10	582.50	2	6.00	1.00	5.15	3.00	6.00	1.00	1.00	0.75	0.75	0.75

DIMENSIONS

T1 SLAB THICKNESS
T2 FLOOR THICKNESS

T3 PARAPET WALL THICKNESS

T4 WALL THICKNESST5 PIER THICKNESS

(P		GOVERNMENT OF KHYBI PAKHTUNKHWA IRRIGATION DEPARTMEN
	311	IRRIGATION DEPARTME

							DRAWN	F.A
NT OF KHYBER							SUBMITTED	M.M
TUNKHWA							RECOMMENDED	Q.L
DEPARTMENT							CHD/VER	F.R.K
	REV.	DATE	DESCRIPTION	BY	CKD.	APPR.	APPROVED	N.A



DRAINAGE CULVERT LARGI-1 AT RD 0+000 TABLE OF DIMENSIONS

PROPOSED REHABILITATION WORKS OF DISTRIBUTARIES & MINORS TYPICAL DRAWINGS FOR


	REHABILITATIONS OF CANALS IN PAHARPUR IRRIGATION DIVISION, DERA ISMAIL KHAN											
	LIST OF TYPICAL DRAWINGS FOR PROPOSED REHABILITATION WORKS OF DISTRIBUTRY AND MINORS											
SR. NO.	DRAWING TITLE	DRAWING NO.										
1	GENERAL NOTES (SHEET 1 OF 2)	4593-TD-061-GN-01										
2	GENERAL NOTES (SHEET 2 OF 2)	4593-TD-061-GN-01										
3	TYPICAL CROSS SECTION FOR REHABILITATION WORKS CONCRETE SIDE PROTECTION WITH SIDE WALL(CASE-1A) (SHEET 1 OF 4)	4593-TD-061-RW-01										
4	TYPICAL CROSS SECTION FOR REHABILITATION WORKS CONCRETE SIDE PROTECTION WITHOUT SIDE WALL(CASE-1B) (SHEET 2OF 4)	4593-TD-061-RW-01										
5	TYPICAL CROSS SECTION FOR REHABILITATION WORKS CONCRETE SIDE PROTECTION WITH BOTH SIDE WALL(CASE-1C) (SHEET 3OF 4)	4593-TD-061-RW-01										
6	TYPICAL CROSS SECTION FOR REHABILITATION WORKS CONCRETE SIDE PROTECTION WITH SIDE WALL DETAILS	4593-TD-061-RW-01										
7	TYPICAL CROSS SECTION FOR REHABILITATION WORKS COMPLETE CONCRETE REHABILIATITION (CASE-2)	4593-TD-061-RW-02										
8	TYPICAL PLAN AND CROSS SECTION FOR REHABILITATION WORKS BRICK RETAINING WALL SIDE PROTECTION (CASE-3) (SHEET 1 OF 1)	4593-TD-061-RW-03										
9	TYPICAL PLAN AND CROSS SECTION FOR REHABILITATION WORKS STONE PROTECTION SIDE PROTECTION (CASE-4)	4593-TD-061-RW-04										
	LIST OF TYPICAL DRAWINGS FOR PROPOSED REHABILITATION WORKS OF HYDRAULIC STRUCTUR	ES										
12	TYPICAL PLAN FOR REHABILITATION WORKS OF BRIDGE (SHEET 1 OF 2)	4593/TD/061/RHS-01										
13	TYPICAL CROSS SECTIONS FOR REHABILITATION WORKS OF BRIDGE (SHEET 2 OF 2)	4593/TD/061/RHS-01										
14	TYPICAL PLAN FOR REHABILITATION WORKS OF FOOT BRIDGE (SHEET 1 OF 2)	4593/TD/061/RHS-02										
15	TYPICAL CROSS SECTIONS FOR REHABILITATION WORKS OF FOOT BRIDGE (SHEET 2 OF 2)	4593/TD/061/RHS-02										
16	TYPICAL PLAN AND CROSS SECTIONS FOR REHABILITATION WORKS BRIDGE CUM GLACIS FALL STRUCTURE (SHEET 1 OF 2)	4593/TD/061/RHS-03										
17	TYPICAL CROSS SECTIONS FOR REHABILITATION WORKS BRIDGE CUM GLACIS FALL STRUCTURE (SHEET 2 OF 2)	4593/TD/061/RHS-03										
18	TYPICAL PLAN AND CROSS SECTION FOR REHABILITATION WORKS BRICK RETAINING WALL DETAILS	4593/TD/061/RHS-04										

						DRAWN	F.A
						SUBMITTED	м.м
						RECOMMENDED	Q.L
						CHD/VER	F.R.K
REV.	DATE	DESCRIPTION	BY	CKD.	APPR.	APPROVED	N.A



LIST OF DRAWINGS

AUG 2023

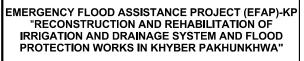

GENERAL NOTES

1. GENERAL

- 1.1 Coordinates, wherever mentioned, refer to "Universal Traverse Mercator (UTM)" System Zone 43 Northern Mercator as per hemisphere WGS 1984.
- 1.2 All dimensions and elevations etc. shown on the drawings are in FP System unless otherwise indicated.
- 1.3 The Grid, Co-ordinates of points and contours are in feet.
- 1.4 Canal chainages are shown as Reduced Distances (RD) in 1000 feet measured along center line of canal.
- 1.5 Locations of variable Layout features such as sand dunes, nullahs, depressions and houses etc., are subject to change.
- 1.6 To record the existing ground levels for measurement of excavation and fill in embankments, the area shall jointly be surveyed by the Contractor and the Engineer before starting the works, and same shall be used for quantity estimation & certification.
- 1.7 The Contractor shall prepare and submit plan for excavation of foundation and drawings for concrete structures to the Engineer for approval prior to pouring of concrete.
- 1.8 All areas disturbed due to the construction activities shall properly be restored to its original form or as directed by the Engineer.
- 1.9 Location of structures are approximate and subject to adjustment and shall be finalized as per site conditions and as per directions of the site Engineer.
- 1.10 Any variation between drawings and site conditions shall be brought into the notice of the Engineer for clarification before execution of the work
- 1.11 Drawings shall be read in conjunction with all other relevant drawings.
- 1.12 Two coats of approved quality of bitumen shall be applied on the earth face of the structures for waterproofing as per contract specifications or as directed by the Engineer.

2. BRIDGES

- 2.1 Construction shall conform to the latest versions of AASHTO, LRFD Loadings and NHA Code Requirements.
- 2.2 Deck Slab shall be installed in their correct position.
- 2.3 Design loads are those defined in the "Code of Practice for Highway Bridges West Pakistan Highway Deptt: 1967-Class AA Tracked Military Loading Class A and Class B loadings including NLC loading
- 2.4 The RCC deck shall be constructed prior to back filling at abutments.

3. EARTH WORK

- 3.1 Excavation shall be carried out to the lines and grades shown on the drawings or as directed by the Engineer.
- 3.2 Fill, backfill and selected fill material where required, shall be placed and compacted to the requirements as per Technical provisions.
- 3.3 Backfill for the bridge abutment walls shall consist of coarse grained soil without admixture of fine particles, non-expansive and non cohesive, clean sand and gravel, having Ø ≥ 33°.
- 3.4 Backfill material for retaining walls, wing walls and other earth retaining structures shall consist of silty-sandy soils (SM soils) containing fines (Passing 200 sieve) up to 16% and compacted to 95% standard proctor dry density (ASTM D698).
- 3.5 All backfill material for bridge abutment walls shall be compacted to 95% of maximum modified proctor dry density. (ASTM D1557).
- 3.6 The structures to be constructed on fill, shall be placed on engineered fill as per specifications or as directed by the Engineer.
 - On the basis of limited geotechnical investigations as conveyed in supplementary bidding document, all the structures at Main Canal, Distributaries/Minors and Flood Carrier channels shall comply to the following instructions;
 - i Shallow foundation above NSL must be placed over selected fill material, as specified, against the bearing capacity of 1.25 MTon/sq. ft. Selected fill material must be ensured to have the minimum depth of 5ft below fo
 - ii Shallow foundation below NSL has been designed against the bearing capacity of 1.25 MTon/sq. ft and subjected to further verification on the basis of geotechnical investigations duly approved by the competent authority prior to construction.
- 3.8 Development of any excessive pressure behind the abutment & retaining walls due to over compaction shall be avoided.
- 3.9 Any loose soil encountered during excavation of canal or structure foundation shall be replaced with approved fill material.
- The Contractor shall keep the excavated area dry during the construction activity and atleast 12 hours after its excavation or as directed by the Engineer.

4. CONCRETE

- 4.1 Concrete design and construction shall conform to the latest version of ACI 350-21 (code requirements for Environmental Engineering Concrete Structures) and ACI 318-19 (Building code requirements).
- 4.2 Unless otherwise noted on the drawings the minimum compressive concrete cylinder strength at 28 days shall be as follows:
 - i RC Class B 3000 psi Structural concrete and precast concrete.
 - ii PC Class C 3000 psi Mass concrete and concrete lining.
 - iii PC Class D 1500 psi Blinding concrete.

- 4.3 Sulphate resisting cement conforming to ASTM-C150 or specified equivalent shall be used for canal lining. For other related structures Sulphate resisting cement shall be used where specified on the basis of recommendations of water and soil test results.
- 4.4 Concrete finishes and tolerances shall be as per technical specifications.
- 4.5. All exposed concrete edges shall be champhered $\frac{3}{4}$ " $\times \frac{3}{4}$ " unless otherwise shown on the drawings.
- 4.6 The design of formwork and false work as well as its construction shall be the responsibility of the Contractor. Design of formwork and false work shall conform to latest version of ACI 347 and ACI SP4-05.
- 4.7 All reinforced concrete shall be fair-faced to be casted in properly designed steel formwork and plates.
- 4.8 2 ½ " x 2 ½" precast concrete spacer blocks having minimum concrete cylinder compressive strength of 4000 psi and spaced not more than 3' c/c shall be used for provision of cover to main reinforcement. Thickness of these blocks shall be equal to the recommended cover.

5. REINFORCEMENT

- 5.1 All reinforcing steel indicated on drawings, except for stirrups, shall be deformed bars conforming to ASTM A-615 Grade 60 with minimum yield strength of 60,000 psi, while for stirrups use deformed bars conforming to ASTM A-615 Grade 40 with minimum yield strength of 40,000 psi.
- .2 Minimum concrete cover to reinforcement, unless otherwise noted, shall be:

Bottom reinforcement of slabs. = 1"
Faces in contact with earth. = 3"
Piles. = 3"

Top surface of glacis and stilling basin floors. = $2\frac{1}{2}$ "

Beams, diaphragms & deck slabs (top reinforcement). = $1\frac{1}{2}$ "

- 3 Concrete reinforcement strength of all precast RC pipes dia 6" & 9" shall conform to the requirements of BS 5911: 1981 (part-1)
- 5.4 Concrete and reinforcement strength of all precast RC pipes used, shall conform to the requirements of ASTM designation C-76 for class- III, wall- A pipe.
- 5.5 Wherever required, the lap and development lengths will be according to the following table. All lap splices shall be staggered.

LAP/DEVELOPMENT LENGTHS (60.000 Psi Tension)

				,						
BAR SIZE	(#)	3	4	5	6	7	8	9	10	11
LAP LENGTHS	(in.)	24	32	40	48	70	80	90	100	110
DEVELOPMENT LENGTHS	(in.)	18	25	31	37	54	62	69	77	85

LAP/DEVELOPMENT LENGTHS (4,000 Psi Compression)


BAR SIZE	(#)	3	4	5	6	7	8	9	10	11
LAP LENGTHS	(in.)	11	15	19	23	26	30	34	38	41
DEVELOPMENT LENGTHS	(in.)	8	10	12	15	17	19	21	24	26

- 5.6 The Contractor shall prepare all bar bending schedules as per construction drawings etc. and submit to the Engineer well before execution for approval.
- 5.7 All reinforcing steel shall be accurately placed in the formwork and held firmly before placing concrete by means of 16 gauge black annealed wires and adequately designed spacers.
- 5.8 Bars in columns shall be joggled for laps with starter bars.
- Except as otherwise shown on the drawing, whenever reinforcing bars of different sizes are to be lapspliced in compression, splice length shall be the larger of the development length of the longer bar or splice length of smaller bar.
- 5.10 The bend details shall be as shown in the table and figures below

MINIMUM DIAMETER OF BEND.

BAR SIZE	MINIMUM DIAMETER OF BEND
#3 through #8	6 d₀
#9, #10 and #11	8 d₀

STANDARD HOOKS

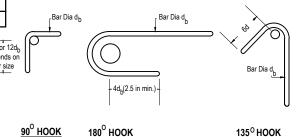

(SHEET 1 OF 2)

EMERGENCY FLOOD ASSISTANCE PROJECT (EFAP)-KP
"RECONSTRUCTION AND REHABILITATION OF
IRRIGATION AND DRAINAGE SYSTEM AND FLOOD
PROTECTION WORKS IN KHYBER PAKHUNKHWA"



							DRAWN		F.A	
							SUBMITTED		M.M	
						RECOMMEN	DED	Q.L		
							CHD/VER		F.R.I	K
REV.	DATE	C	DESCRIPTION	BY	CKD.	APPR.	APPROVED		N.A	



MODEL TOWN EXTENSION, LAHORE PAKISTA

GENERAL NOTES (DISTRIBUTARY)

DATE DWG. NO. 4593/TD/061/GN-01

GENERAL NOTES

STRUCTURAL STEEL

- All structural steel shall conform to requirments of ASTM Designation A36
- Welding will be continous fillet weld unless otherwise shown on the drawings using electrodes of approved quality.
- All structural steel shall be galvanized or painted as directed by the Engineer.

7. **BRICK MASONRY**

- All bricks for brick masonry structures shall have minimum compressive strength of 2000 psi.
- Brick masonry shall be laid in 1:3 cement/sand mortar unless otherwise noted.
- Plastering/Pointing shall be done on all exposed faces of brick masonry in 1:3 cement/sand mortar.
- Absorption capacity of bricks varies with chemical composition of clay component. A good quality bricks should not absorb water more than 10 to 15 % by weight in 12 hours.

EXPANSION JOINTS 8.

- Preformed/premoulded expansion joint filler (non extruding and resilient type) conforming to AASHTO M213 specification shall be used at locations shown on the drawings
- Concrete joint-sealer, hot poured, Elastic type conforming to the AASHTO:M173. shall be used. 8.2

CONTRACTION, DUMMY & CONSTRUCTION JOINTS 9.

- Unless otherwise shown on the drawings, contraction, dummy & construction joints shall be provided as per specifications with the approval of The Engineer and shall be planned 9.1
- All construction joint surfaces shall be roughened to remove latinate, expose the aggregate surface and be thoroughly cleaned and wetted 91 before the new concrete is placed.

10. **MISCELLANEOUS**

- Two coats of approved quality of Bitumen shall be applied on the earth face of the structures for waterproofing as per contract specifications unless otherwise shown on the drawings.
- 10.2 All water stops shall be 9" PVC water stops with three bulbs or as indicated on drawings.
- 10.3 The design of the foundations of the structures is based on recommendations of soil test report.
- All materials, workmanship and tests shall conform to AASHTO specifications except where specifically notified on the drawings.
- Construction of all components of the bridge shall conform to the relevant clauses of AASHTO standard specifications, unless otherwise specified.
- All elevations shown on drawings are finished surface.
- Placement of concrete shall extend to the full width of deck slab. Construction joint will be permitted at the centre line of diaphragm. Concrete for deck may be placed monolithically
- Concrete in the deck slab shall be placed in full width. No construction joints will be permitted. Concrete for the barriers and guardrail shall be placed not sooner than 10 days after placing the concrete in the deck slab or as directed by the Engineer.
- Asphalt layer / wearing surface of 3" shall be used on all Bridge deck slabs / Approach slabs. No surfacing is required over Foot Bridges / Water Pipe Crossings.
- 10.10 Rain water outlet / pipe of 4" dia shall conform to relevant Technical Specification.

11. MECHANICAL WORKS

- Gate and Hoisting arrangements shown on the Mechanical drawings are indicative and fabrication shall commence after approval of Contractor's design submitted to the Engineer. 11.1
- Suitable dogging bars shall be provided for the gates. 11.2
- Fabrication and installation shall be in accordance with the current AISC specifications for the design, fabrication and erection of structural steel for building. 11.3
- All welding shall be in accordance with the AWS Code D-1.1 welding in building construction. Minimum fillet weld shall be $\frac{1}{4}$ ". 11.4
- 11.5 All edges in contact with rubber seal shall be rounded.
- 11.6 C.G of gate shall be determined in shop after fabrication.
- 11.7 Welding pads shall be spaced at max. 1.5' C/C.
- Upstream stop log guids shall be opposite to each other.
- All materials/paintings and their thickness shall be according to the specifications and drawings and subject to prior approval.
- 11.10 Material test certificates shall be submitted for approval before start of fabrication.
- 11.11 Dimensions/sizes provided on the drawing are the minimum requiremnets. The Contractor shall design and submit the shop drawings/calculations or approval before start of manufacturing. No manufacturing shall be done without approval by Engineer.
- 11.12 The gate equipment shall not be transported to the site before shop inspection by the Engineer or representative.
- 11.13 All installation works shall be carried out according to approved schedule and in the presence of the Engineer or representative.
- 11.14 Complete BOQ shall be provided on the each shop drawing including item Nos.,description,dimensions and quantities.

(SHEET 2 OF 2)

EMERGENCY FLOOD ASSISTANCE PROJECT (EFAP)-KP "RECONSTRUCTION AND REHABILITATION OF **IRRIGATION AND DRAINAGE SYSTEM AND FLOOD** PROTECTION WORKS IN KHYBER PAKHUNKHWA"





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						SUBMITTED	M.M
						RECOMMENDED	Q.L
						CHD/VER	F.R.K
REV.	DATE	DESCRIPTION	BY	CKD.	APPR.	APPROVED	N.A





GENERAL NOTES (DISTRIBUTARY)


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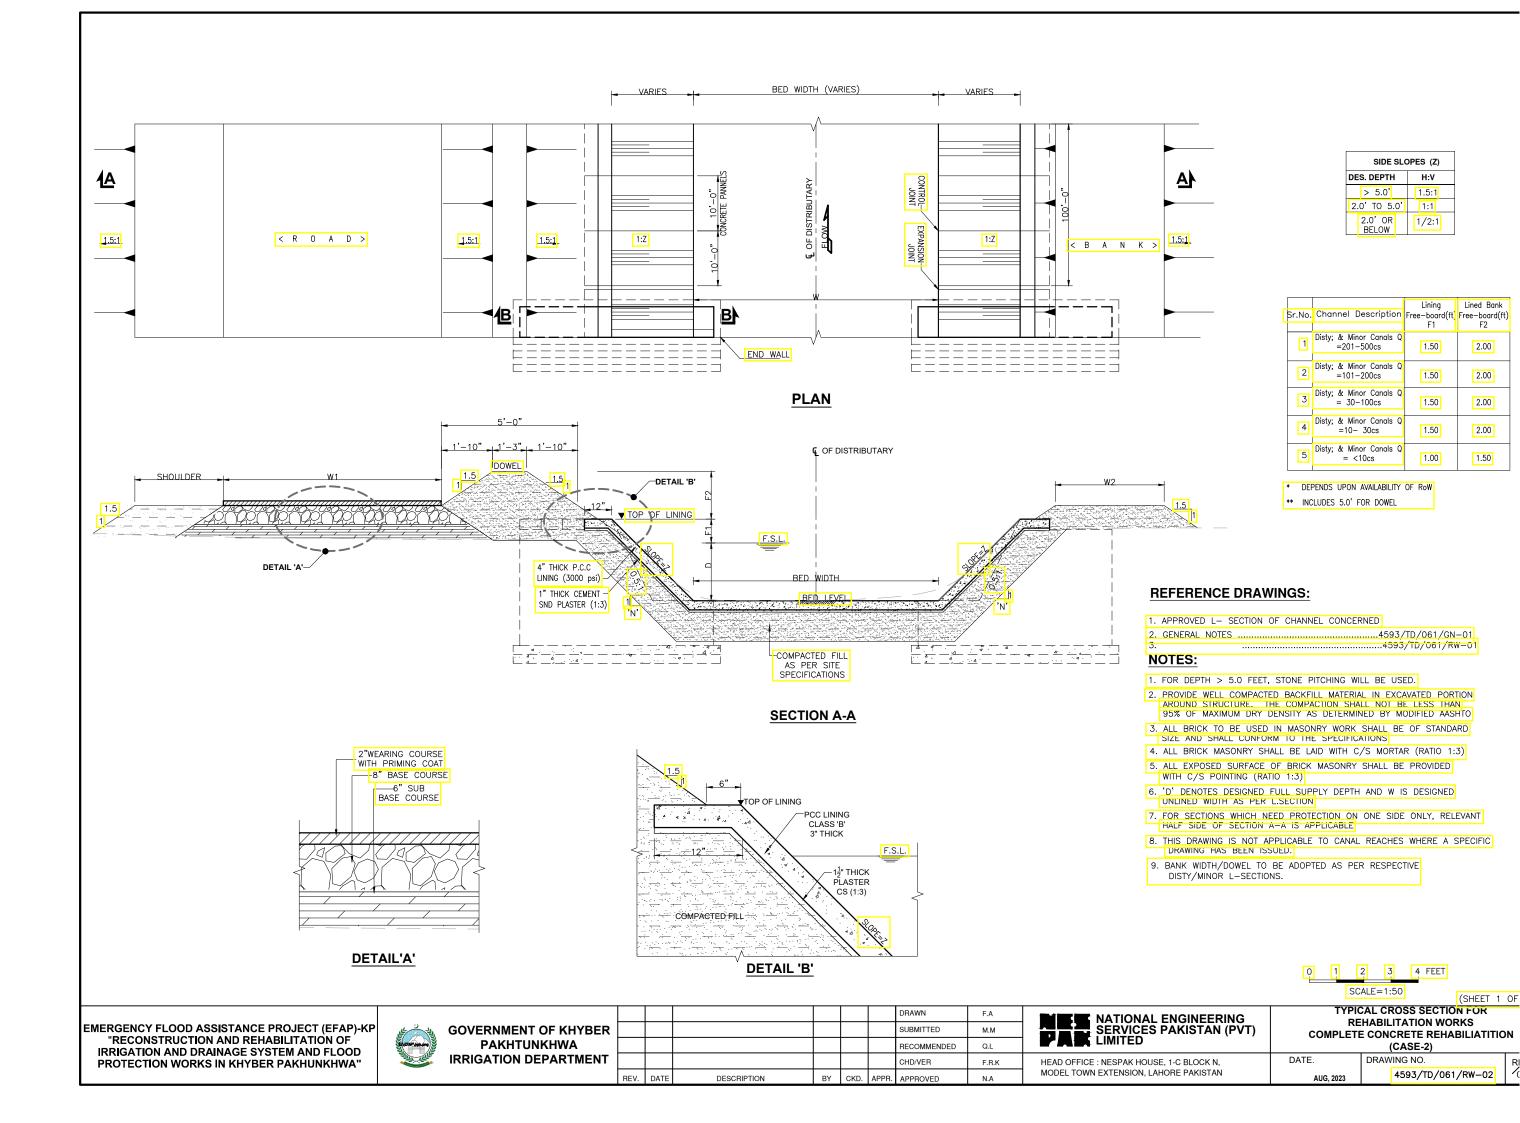


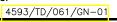


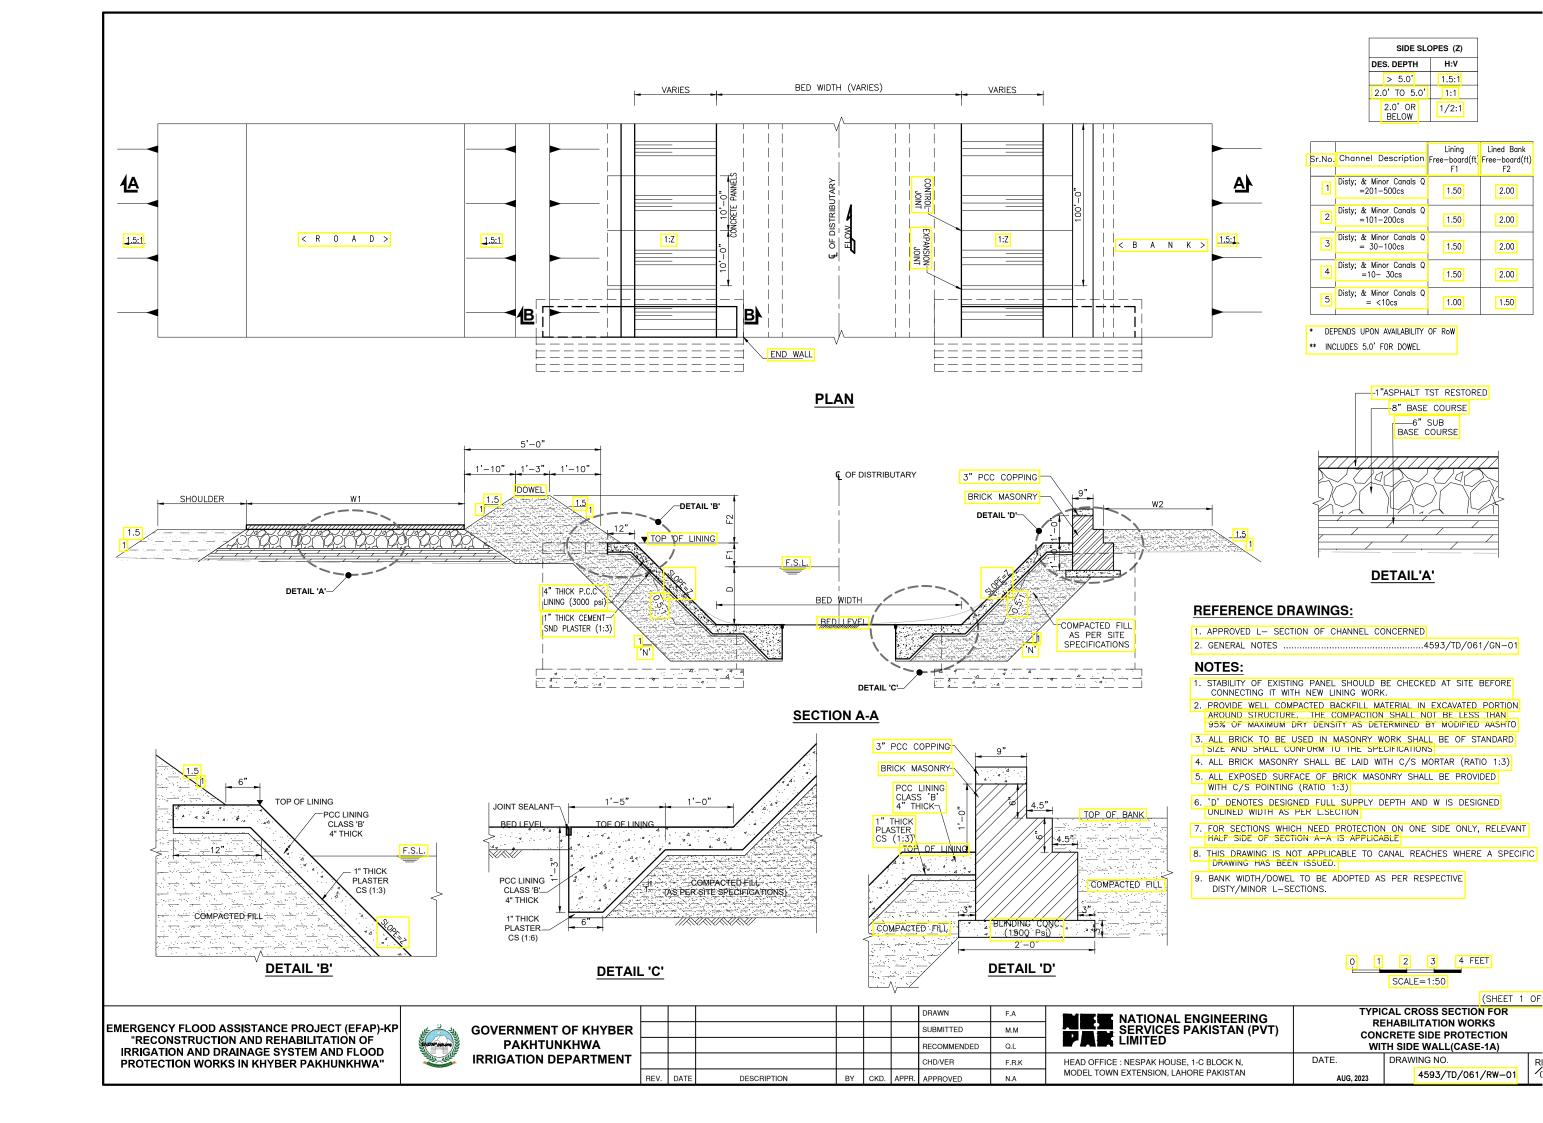

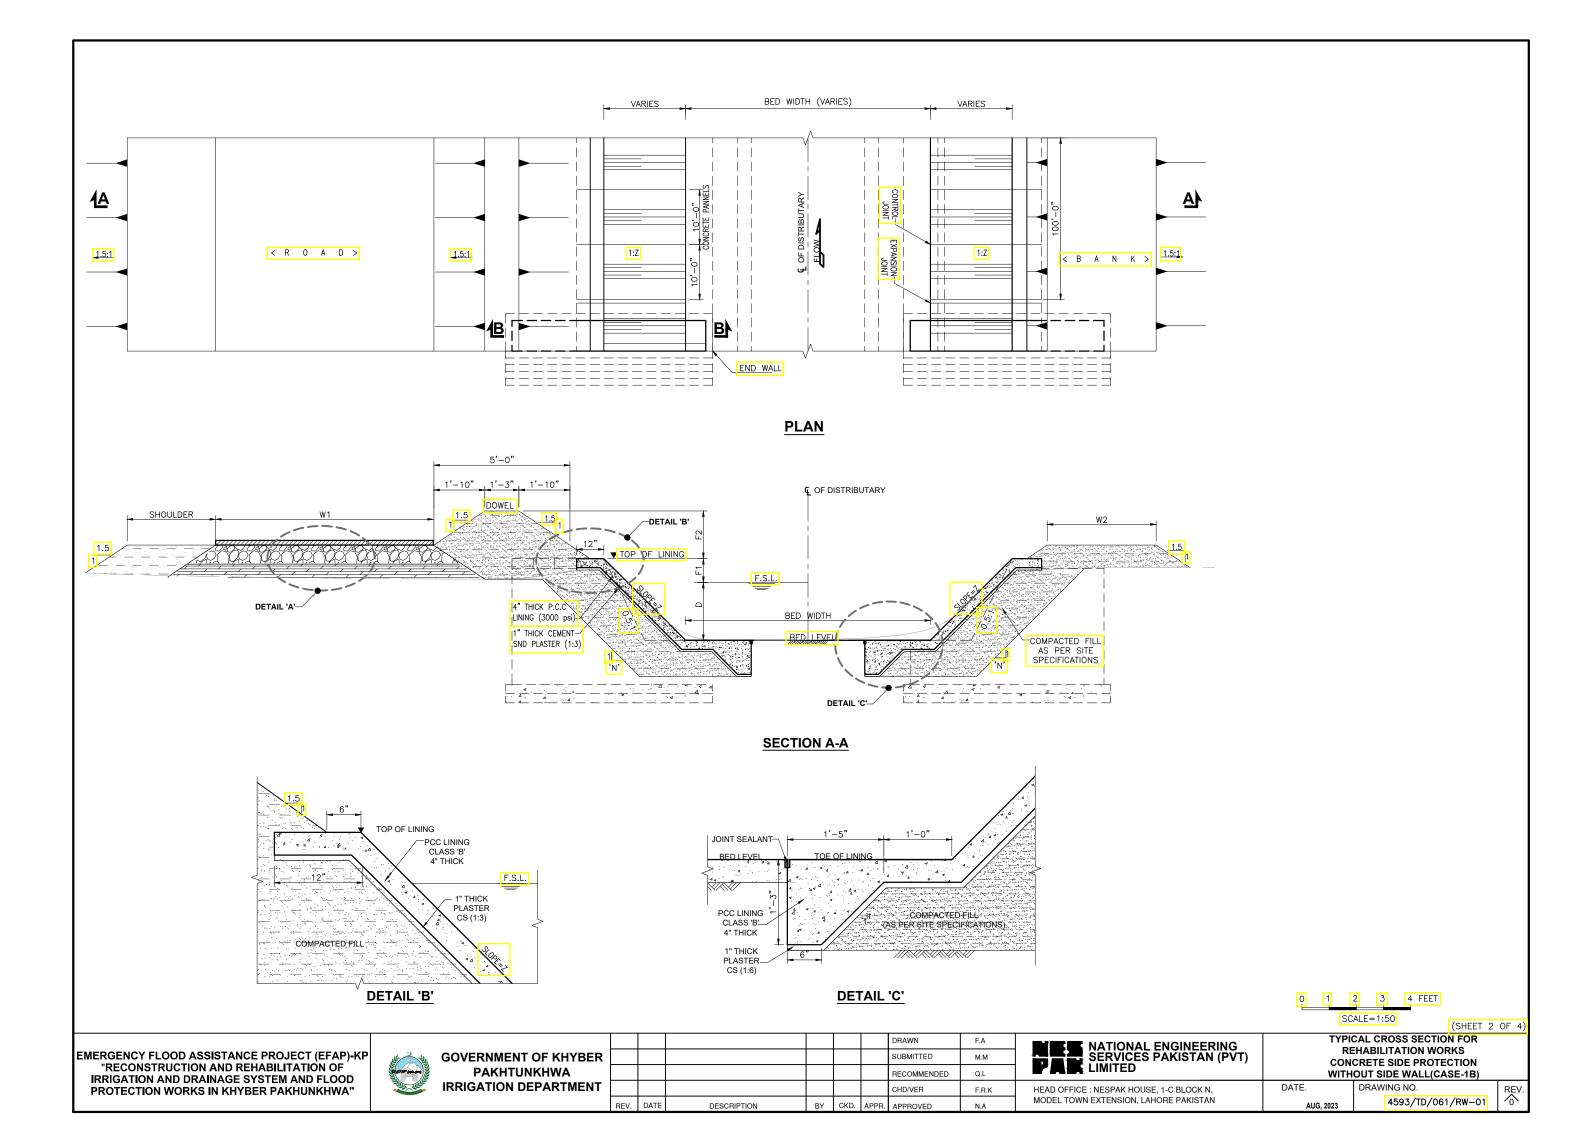

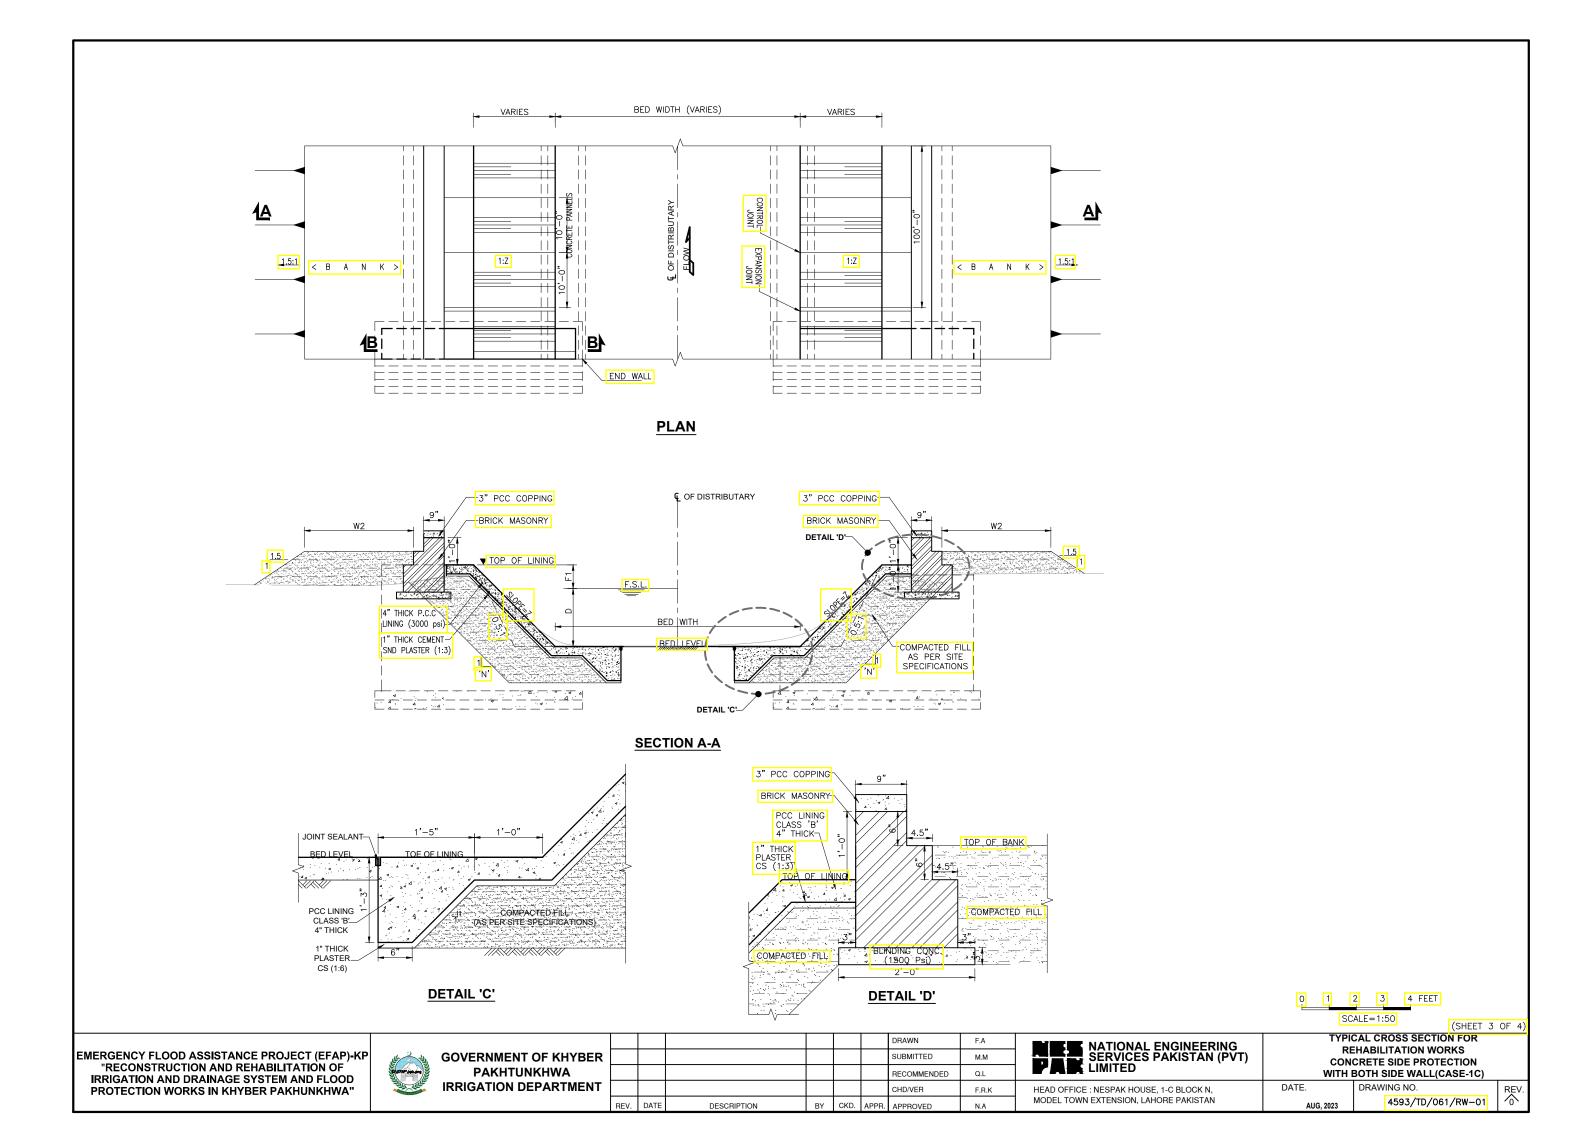

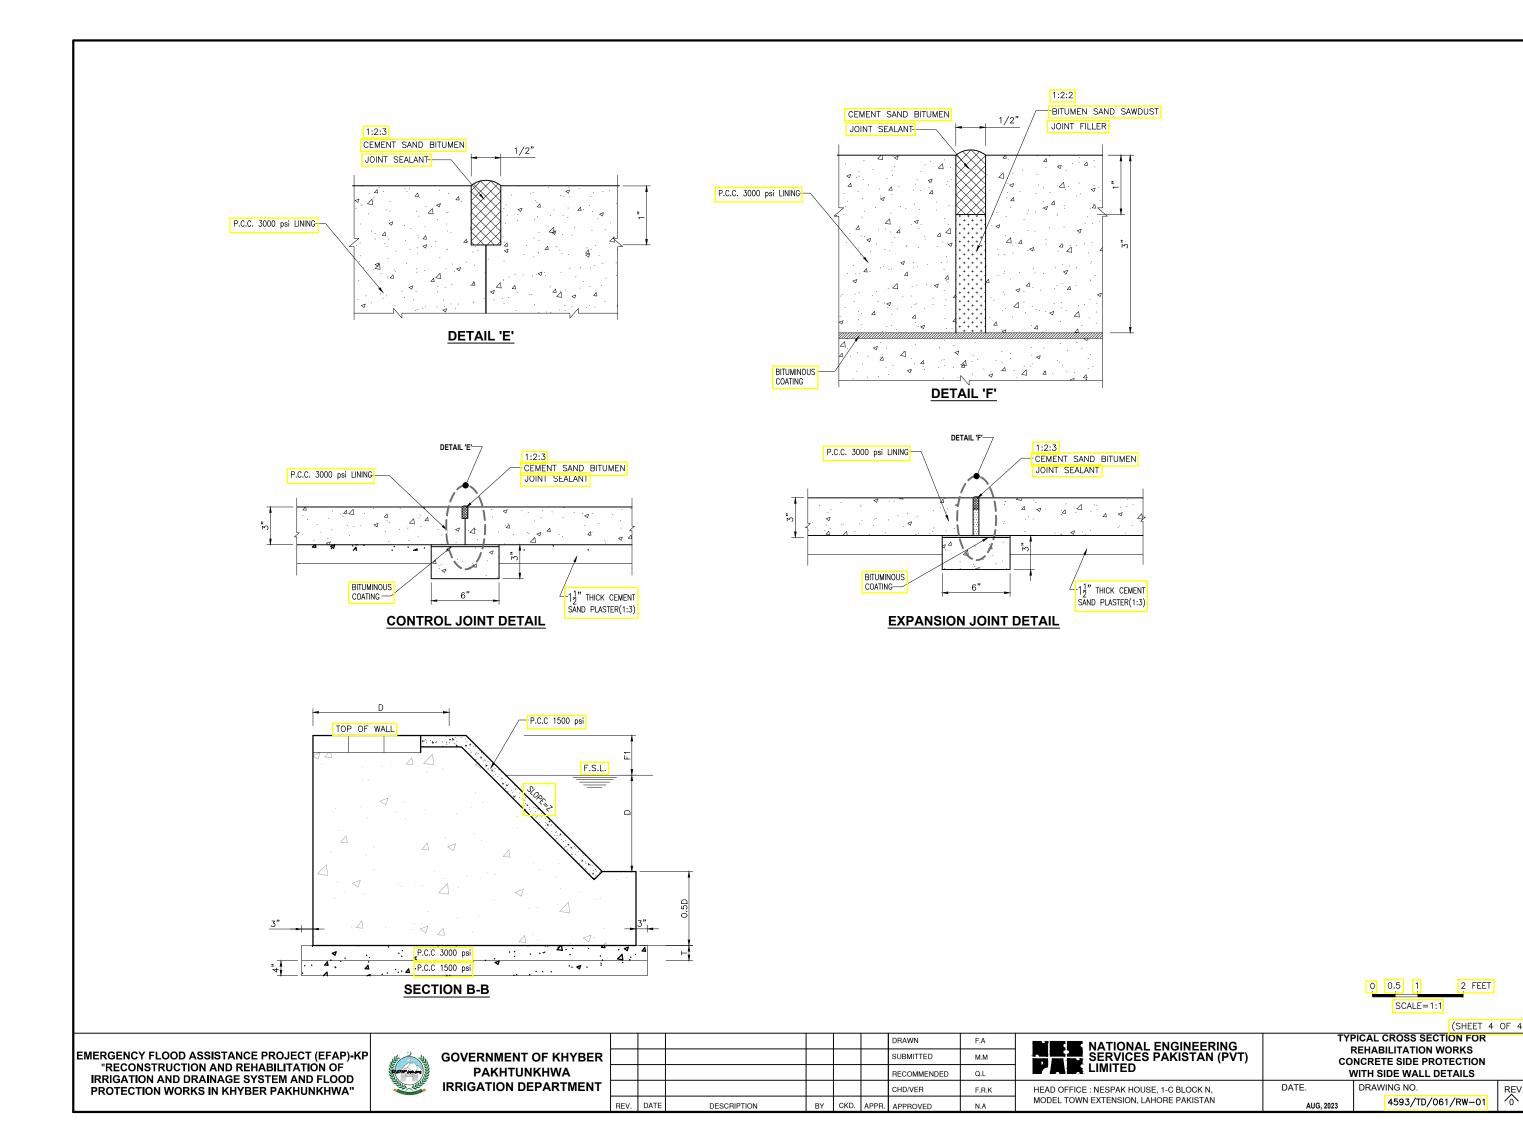

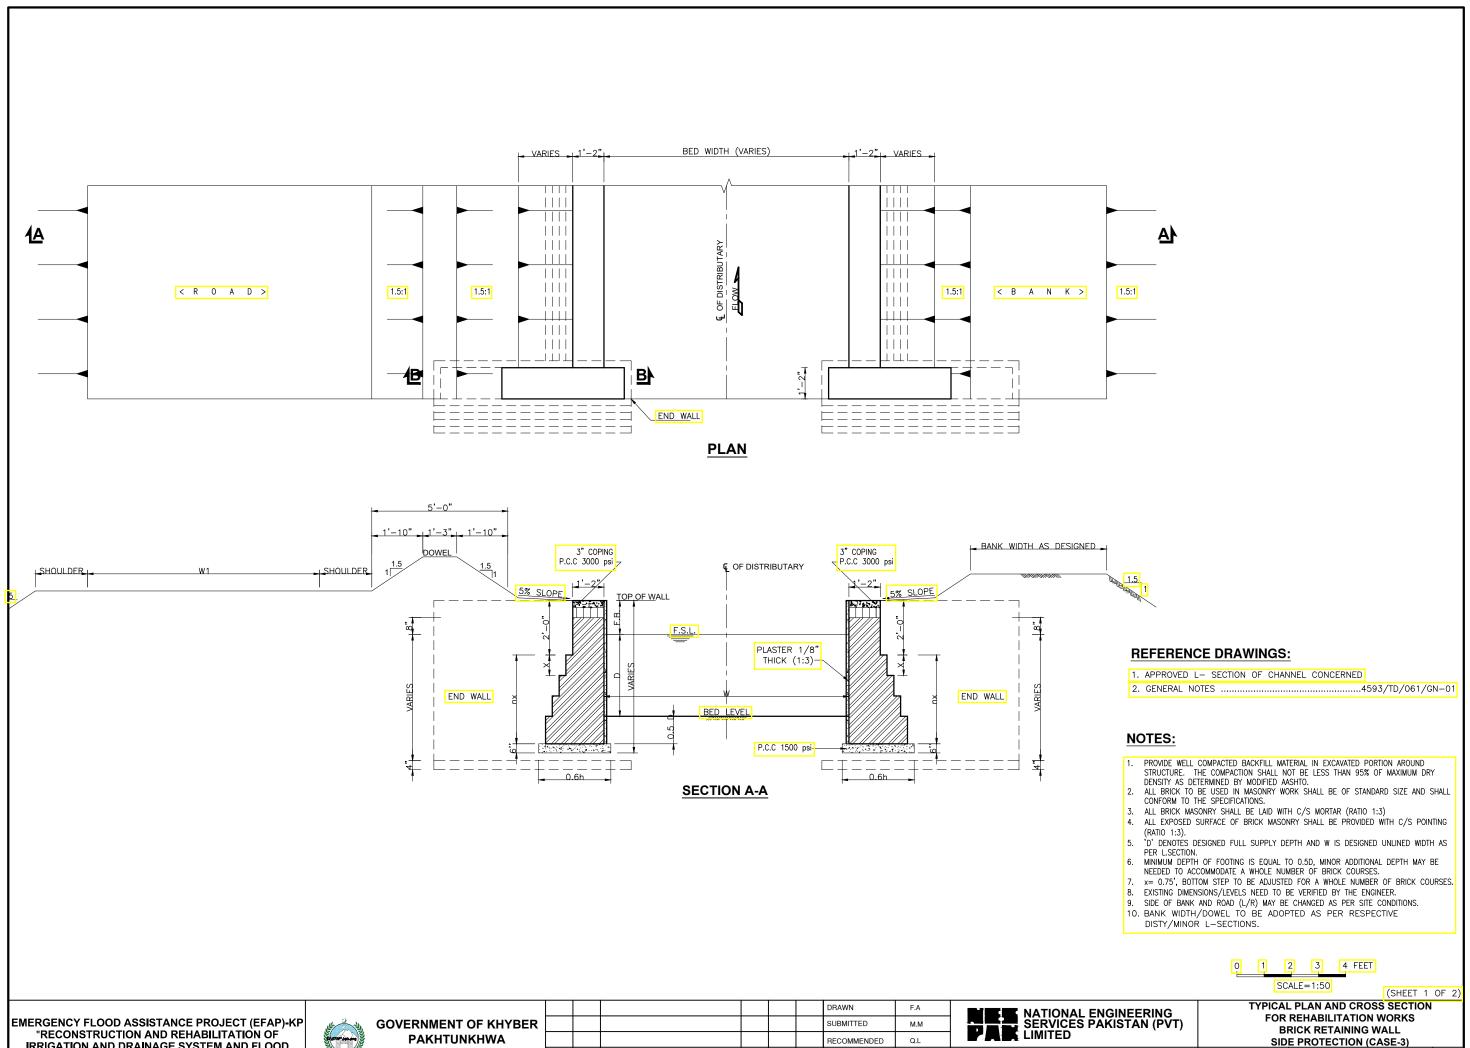

IRRIGATION AND DRAINAGE SYSTEM AND FLOOD PROTECTION WORKS IN KHYBER PAKHUNKHWA"

IRRIGATION DEPARTMENT


DESCRIPTION

DATE. DRAWING NO.


HEAD OFFICE: NESPAK HOUSE, 1-C BLOCK N,


MODEL TOWN EXTENSION, LAHORE PAKISTAN


4593/TD/061/RW-03

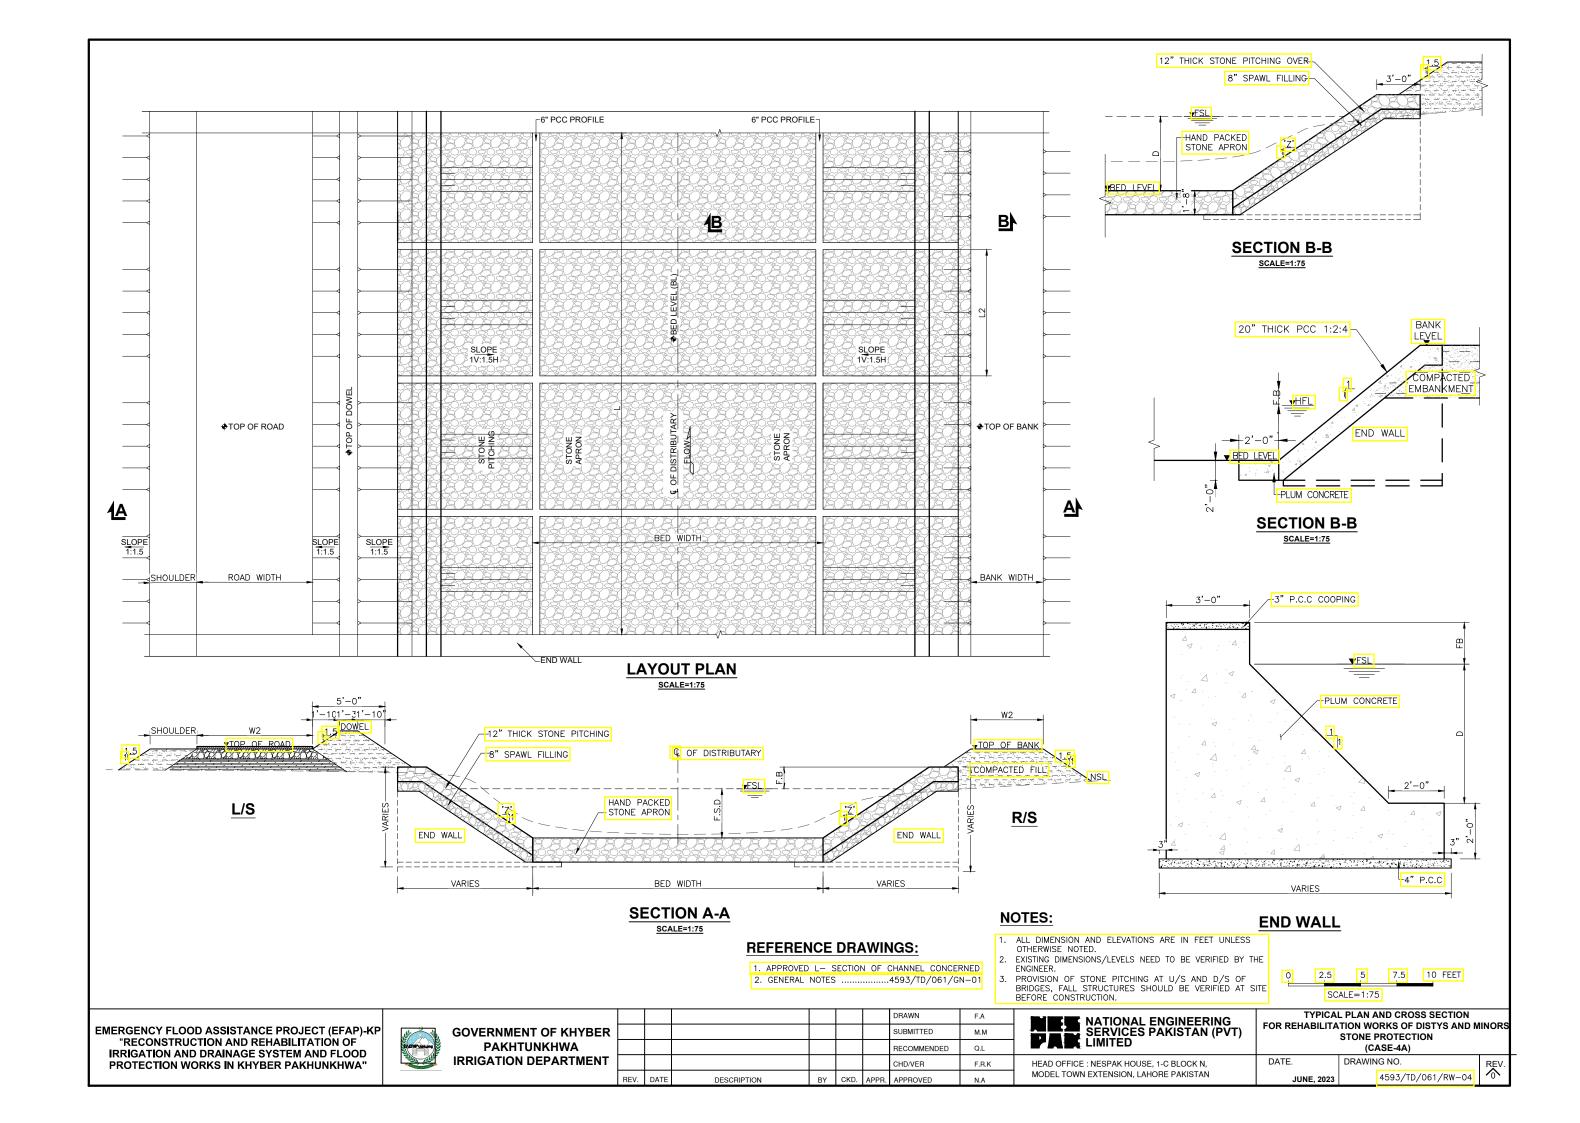

TYPICAL DRAWINGS OF REHABILITATION OF HYDRAULIC STRUCTURES (DRAIN & DISTRIBUTARIES)

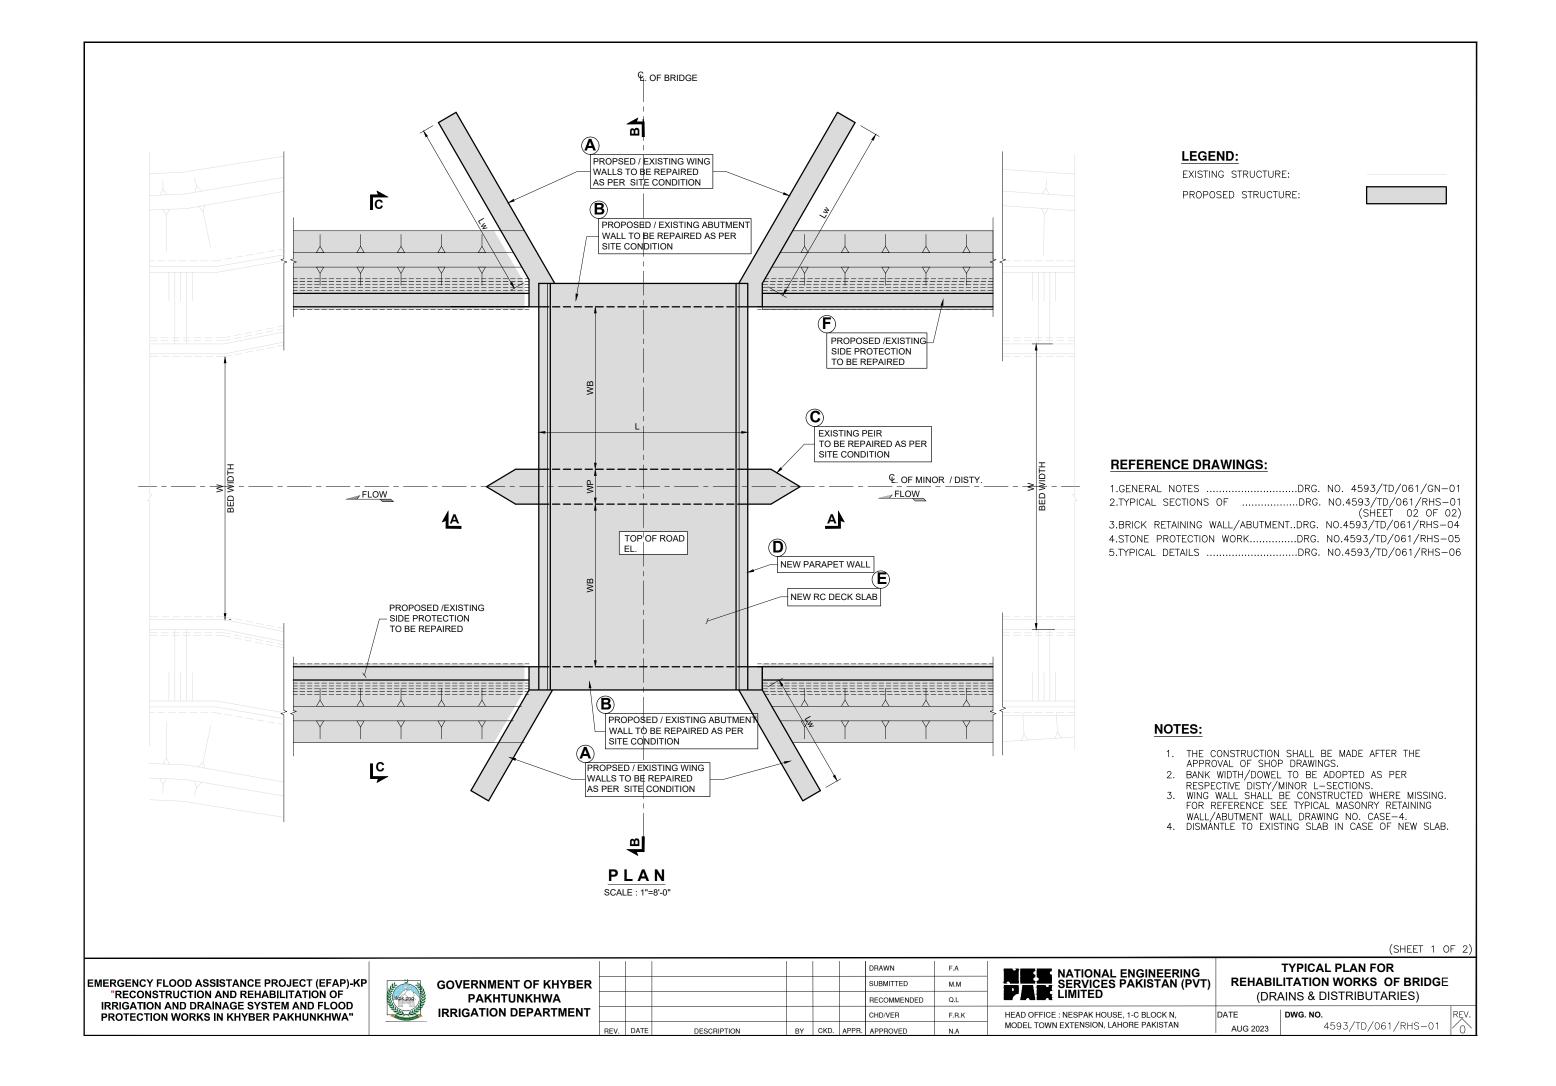


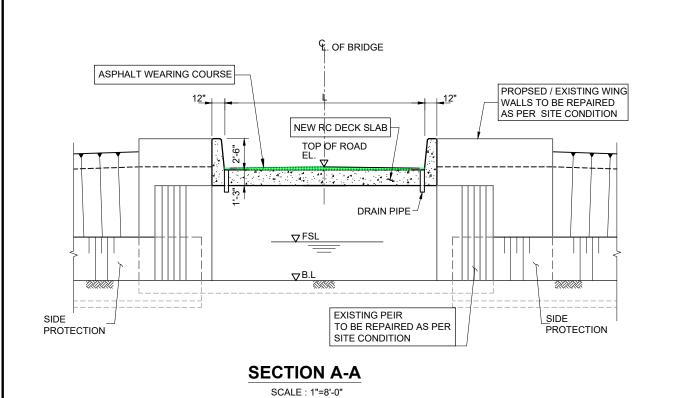

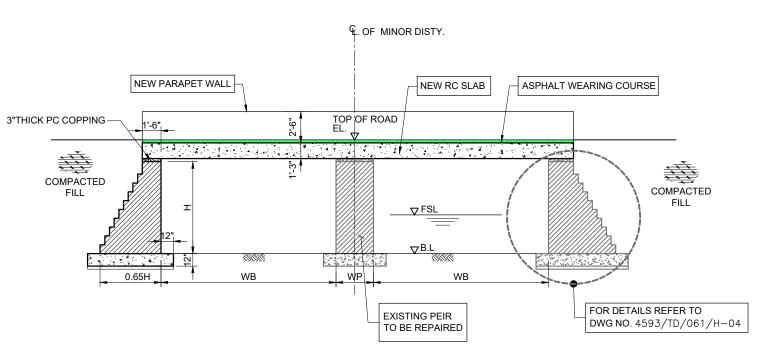

SECTION B-B

SCALE: 1"=8'-0"

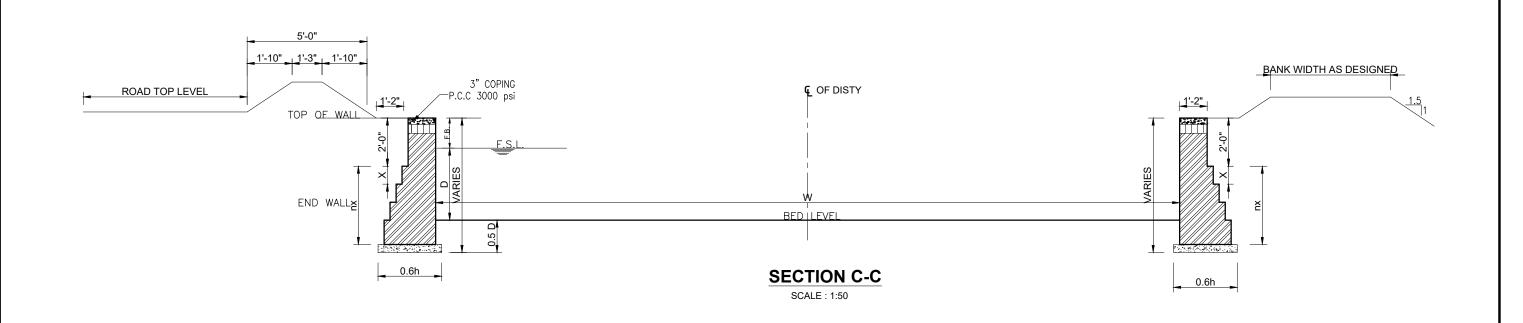

(SHEET 2 OF 2)

EMERGENCY FLOOD ASSISTANCE PROJECT (EFAP)-KP "RECONSTRUCTION AND REHABILITATION OF **IRRIGATION AND DRAINAGE SYSTEM AND FLOOD** PROTECTION WORKS IN KHYBER PAKHUNKHWA"

GOVERNMENT OF KHYBER PAKHTUNKHWA IRRIGATION DEPARTMENT


DRAWN M.M Q.L RECOMMENDED F.R.K REV. DATE DESCRIPTION

NATIONAL ENGINEERING SERVICES PAKISTAN (PVT) PAR LIMITED

TYPICAL SECTIONS FOR REHABILITATION WORKS OF BRIDGE (DRAINS & DISTRIBUTARIES)

HEAD OFFICE: NESPAK HOUSE, 1-C BLOCK N, MODEL TOWN EXTENSION, LAHORE PAKISTAN

4593/TD/061/RHS-01

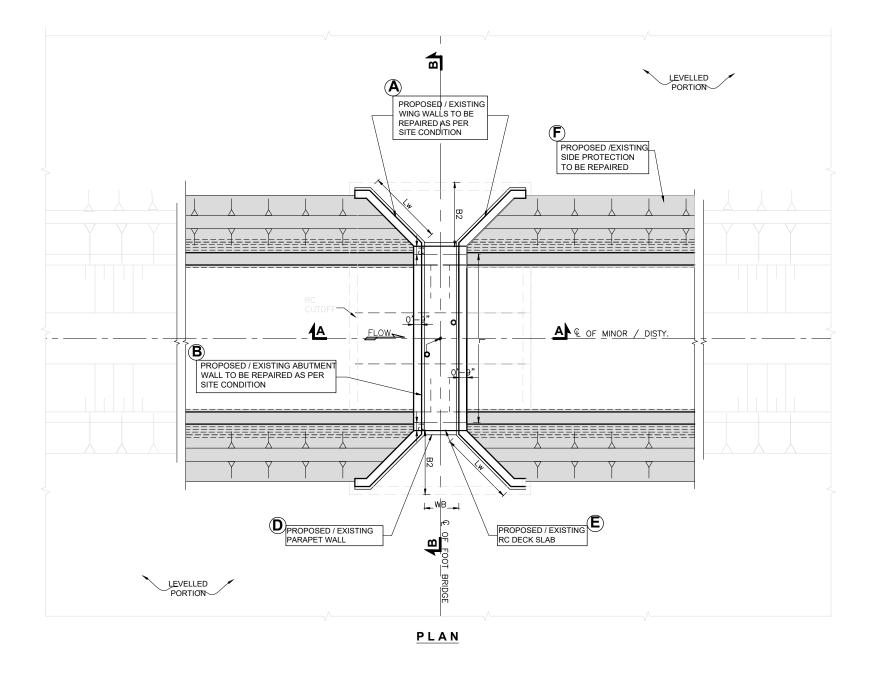

LEGEND:

EXISTING STRUCTURE:

PROPOSED STRUCTURE:

REFERENCE DRAWINGS:

1.GENERAL NOTESDRG. NO. 4593/TD/061/GN-01 2.TYPICAL SECTIONSDRG. NO.4593/TD/061/RHS-01 3.BRICK RETAINING WALL/ABUTMENT....DRG. NO.4593/TD/061/RHS-04 4.STONE PROTECTION WORK......DRG. NO.4593/TD/061/RHS-05DRG. NO.4593/TD/061/RHS-06 5.TYPICAL DETAILS ...

NOTES:

- THE CONSTRUCTION SHALL BE MADE AFTER THE APPROVAL OF SHOP DRAWINGS.
- 2. BANK WIDTH/DOWEL TO BE ADOPTED AS PER RESPECTIVE DISTY/MINOR L—SECTIONS.

 3. WING WALL SHALL BE CONSTRUCTED WHERE MISSING. FOR REFERENCE SEE TYPICAL MASONRY RETAINING WALL/ABUTMENT WALL DRAWING NO. CASE-4
- 4. DISMENTELE TO EXISTING SLAB IN CASE OF NEW SLAB.

(SHEET 1 OF 2)

EMERGENCY FLOOD ASSISTANCE PROJECT (EFAP)-KP "RECONSTRUCTION AND REHABILITATION OF IRRIGATION AND DRAINAGE SYSTEM AND FLOOD PROTECTION WORKS IN KHYBER PAKHUNKHWA"



GOVERNMENT OF KHYBER PAKHTUNKHWA IRRIGATION DEPARTMENT

						DRAWN	F.A
						SUBMITTED	M.M
						RECOMMENDED	Q.L
						CHD/VER	F.R.K
EV.	DATE	DESCRIPTION	BY	CKD.	APPR.	APPROVED	N.A

NATIONAL ENGINEERING SERVICES PAKISTAN (PVT) LIMITED

TYPICAL PLAN FOR REHABILITATION WORKS OF FOOT BRIDGE (DRAINS & DISTRIBUTARIES)

HEAD OFFICE : NESPAK HOUSE, 1-C BLOCK N, DATE MODEL TOWN EXTENSION, LAHORE PAKISTAN

4593/TD/061/RHS-02

